#### **CONSTRUCTION NOTES**

QUALITY ASSURANCE:

THE CONTRACTOR SHALL BE RESPONSIBLE FOR ANY DAMAGE TO THE PORTIONS OF THE BUILDING, PROPERTY, AND ADJACENT PROPERTIES NOT INVOLVED IN THE SCOPE OF WORK. SUCH DAMAGE SHALL BE CORRECTED AT NO COST TO THE OWNER. THE CONTRACTOR SHALL DEMOLISH AND REMOVE IN A PRECISE MANNER AS PER THE CONSTRUCTION DOCUMENTS. OBSERVE DIMENSIONS WHERE NOTED. VERIFY ALL DIMENSIONS IN THE FIELD. THE CONTRACTOR SHALL PROTECT ALL EXISTING ITEMS TO REMAIN (I.E. WINDOWS, ETC.) THROUGHOUT THE COURSE OF THE JOB.

SPECIAL PRECAUTION: THE CONTRACTOR SHALL TAKE ADEQUATE PRECAUTION DURING DEMOLITION TO MAINTAIN THE STRUCTURAL INTEGRITY OF THE BUILDING AND ADJACENT BUILDINGS DURING THE CONSTRUCTION, INCLUDING TEMPORARY SHORING AND BRACING WHERE REQUIRED. ADEQUATE PRECAUTION SHALL ALSO BE TAKEN WHEN DEMOLITION OCCURS IN THE VICINITY OF ALL BUILDING CHASES AND UTILITIES AND WHERE BUILDING SUPERSTRUCTURE ELEMENTS ARE PROTECTED BY FIRE RATED ASSEMBLIES AND/OR FIREPROOFING . THE CONTRACTOR SHALL REPORT TO THE ARCHITECT ANY CONDITIONS UNCOVERED REQUIRING REMEDIAL MEASURES. PROTECT ALL MECHANICAL, ELECTRICAL AND PLUMBING SYSTEMS AND FIXTURES FOR REUSE WHERE APPLICABLE (TO BE EVALUATED BY THE MEP DESIGNER / CONTRACTOR).

PARTIAL REMOVAL:

SYSTEMS OR ITEMS OF SALVAGEABLE VALUE OR ITEMS DEEMED FOR REUSE SHALL BE STORED IN A SAFE MANNER IN THE EXISTING BUILDING. ALL ITEMS SHALL BE DOCUMENTED TO ALLOW FOR REUSE OR SALE BY OWNER.

CONDUCT DEMOLITION OPERATIONS AND THE REMOVAL OF DEBRIS TO ENSURE MINIMUM INTERFERENCE WITH RESIDENCES, STREET, WALKS, AND OTHER ADJACENT, OCCUPIED OR USED FACILITIES. SECURE ALL NECESSARY PERMITS.

5. ELEMENTS TO BE REUSED OR SALVAGED:

ALL ELEMENTS TO BE REUSED OR SALVAGED SHALL BE LEFT CLEAN AND FREE OF FASTENERS, NAILS, SCREWS, AND ROUGH EDGES.

6. DISPOSALOF CONSTRUCTION MATERIALS:

TRANSPORT MATERIALS REMOVED FROM DEMOLITION AND LEGALLY DISPOSE OF OFF SITE. LEAVE SITE IN A BROOM CLEAN CONDITION AT THE END OF EACH WORKDAY. IF NEEDED, ALL SANITATION CONTAINERS SHALL BE LOCATED AS DIRECTED BY THE APPROPRIATE OGS AUTHORITY. SECURE ALL NECESSARY PERMITS.

PROTECTION OF EXISTING ADJACENT SPACES:

ALL CONSTRUCTION SHALL BE EXECUTED IN CONTROLLED AREAS. PROVIDE A DUST PROOF "SEAL" AT THE THRESHOLD BETWEEN PROPOSED DEMOLITION AREA AND EXISTING ADJACENT SPACES.

8. UTILITIES: THE CONTRACTOR SHALL TAKE CARE TO NOT INTERRUPT UTILITIES TO ANY PORTION OF THE BUILDING WITHOUT REQUIRED NOTICE. REMOVALS AND DISCONNECTS OF UTILITIES AS INDICATED BELOW SHALL ONLY APPLY TO THOSE UTILITIES SERVING THE AREA OF WORK WHOSE OUTLETS ARE LOCATED IN ASSEMBLIES TO BE REMOVED. THE CONTRACTOR SHALL DETERMINE THE LOCATION OF THE EXISTING METER PAN AND MAIN SWITCH, DISCONNECT ALL ELECTRICAL POWER AT THE METER PAN, AND PROVIDE NEW TEMPORARY SERVICE FOR LIGHTING AND POWER. REMOVE ALL OLD WIRING, CONDUIT, TELEPHONE, AND SIGNAL WIRE. DO NOT INTERRUPT SERVICE TO SPACES OUTSIDE THE AREA OF WORK. PROVIDE TEMPORARY POWER AND LIGHTING AS REQUIRED THROUGHOUT THE COURSE OF THE JOB. THE CONTRACTOR SHALL DETERMINE THE LOCATION OF THE SANITARY RISER AND DOMESTIC HOT AND COLD WATER SUPPLY. REMOVE AND CAP ALL EXISTING WASTE AND SUPPLY PIPING BACK TO RISER. AND PROVIDE NEW TEMPORARY COLD WATER SUPPLY PIPING AND SPIGOT FOR DEMOLITION USE, CLEAN UP, ETC. DO NOT INTERRUPT SERVICE TO SPACES OUTSIDE THE AREA OF WORK.

9. CLEAN UP:

IT IS THE RESPONSIBILITY OF THE CONTRACTOR TO KEEP CONSTRUCTION "DUST" FROM PENETRATING INTO THE REMAINDER OF THE EXISTING BUILDING. THE INTERIOR AND EXTERIOR (IF REQUIRED) OF THE SITE SHALL BE SWEPT CLEAN AT THE END OF EACH WORKING DAY. THERE SHALL BE NO VISUAL OBSTRUCTION TO THE NEIGHBORHOOD. THE CONDITION OF THE SITE SHALL BE MAINTAINED IN AN ORDERLY MANNER.

10. SECURITY: THE AREA OF WORK SHALL BE SECURELY ENCLOSED AND LOCKED BY LAST CONTRACTOR TO LEAVE THE JOBSITE AT THE END OF EACH WORKDAY.

11. MEANS & METHODS:

THE CONTRACTOR SHALL SUPERVISE AND DIRECT THE WORK, USING THE CONTRACTOR'S BEST SKILL AND ATTENTION. THE CONTRACTOR SHALL BE SOLELY RESPONSIBLE FOR AND HAVE CONTROL OVER MEANS, METHODS, TECHNIQUES, SEQUENCES, AND PROCEDURES AND FOR COORDINATING ALL PORTIONS OF THE WORK, WORK, MATERIALS, EQUIPMENT, MEANS AND METHODS SHALL BE IN STRICT ACCORDANCE WITH ALL CODES, RULES, REGULATIONS, AND ORDINANCES HAVING AUTHORITY. THIS SHALL INCLUDE THE BUILDING CODE OF NEW YORK STATE, THE ENERGY CONSERVATION CONSTRUCTION CODE OF NEW YORK STATE, THE AMERICAN'S WITH DISABILITIES ACT, ANSI A117.1, OSHA AND REGULATIONS OF THE NEW YORK STATE LABOR DEPARTMENT.

12. BUILDING RULES & REGULATIONS:

IT IS THE CONTRACTOR'S RESPONSIBILITY TO UNDERSTAND, OBEY AND ENFORCE THE BUILDING OWNER'S RULES & REGULATIONS AS THEY PERTAIN TO THE WORK, IT IS ALSO THE CONTRACTOR'S RESPONSIBILITY TO ENSURE ADHERENCE TO THE RULES AND REGULATIONS BY ALL SUBCONTRACTORS.

#### GENERAL NOTES

- 1. ALL WORK AND MATERIALS FURNISHED SHALL COMPLY WITH THE RULES AND REGULATIONS OF ALL GOVERNMENTAL AUTHORITIES HAVING JURISDICTION.
- 2. ALL WORK SHALL CONFORM TO THE LATEST REQUIREMENTS (UNLESS OTHERWISE NOTED) OF THE 2010 NEW YORK BUILDING CODE AND WITH THE STRICTEST PROVISIONS GOVERNING IN THE EVENT OF ANY CONFLICT BETWEEN PLANS, SPECIFICATIONS, AND/OR DIFFERENT CODES.
- 3. THE BUILDING PERMIT SHALL BE SECURED AND PAID FOR BY THE GENERAL CONTRACTOR WHO SHALL OBTAIN AND PAY FOR ALL OTHER PERMITS AND APPROVALS AS REQUIRED BY LAW FOR THE COMPLETION OF THE WORK.
- 4. THE CONTRACTOR SHALL FILE INSURANCE CERTIFICATION FOR LIABILITY, PROPERTY DAMAGE. DISABILITY AND WORKMAN'S COMPENSATION INSURANCE PRIOR TO COMMENCING CONSTRUCTION. COPIES OF SUCH POLICIES SHALL BE FILED WITH THE OWNER AND ARCHITECT.
- 5. THE CONTRACTOR SHALL VISIT THE SITE AND FAMILIARIZE HIMSELF WITH ALL CONDITIONS AND THE FULL EXTENT OF THE PROJECT. ANY DISCREPANCIES SHALL BE BROUGHT TO THE ATTENTION OF THE ARCHITECT.
- THE CONTRACTOR SHALL VERIFY ALL DIMENSIONS AND DETAILS IN THE FIELD AND NOTIFY THE ARCHITECTS OF ANY DISCREPANCIES BEFORE PROCEEDING WITH WORK.
- 7. ALL WORK, WHETHER SHOWN OR IMPLIED, UNLESS SPECIFICALLY QUESTIONED, SHALL BE CONSIDERED FULLY UNDERSTOOD IN ALL RESPECTS BY THE CONTRACTOR.THE CONTRACTOR SHALL BE RESPONSIBLE FOR ANY MISINTERPRETATIONS OR CONSEQUENCES THEREOF FOR ALL WORK ON ALL CONTRACT DOCUMENTS.
- WORK SHALL INCLUDE ALL CHARGES AND EXPENSES FOR FURNISHING ALL ITEMS SHOWN, SPECIFIED OR REQUIRED TO COMPLETE THE WORK, WHETHER OR NOT SPECIFICALLY MENTIONED OR SHOWN, BUT WHICH ARE NECESSARILY REQUIRED TO OBTAIN AND CONSTRUCT THE INDICATED DESIGN.
- 9. ALL WORK SHALL BE OF THE BEST CALIBER AND WORKMANSHIP. WORK NOT CONFORMING TO THE HIGHEST STANDARDS OR TO THE INTENT OF THE DESIGN SHALL BE REINSTALLED AT NO EXTRA CHARGE, IF SO DEEMED BY THE ARCHITECT.

- 10. NO SPECIFIED ITEM MAY BE SUBSTITUTED UNLESS AN EQUAL IS SUBMITTED FOR RESPONSIBILITY.
- 11. ALL MANUFACTURED ARTICLES, MATERIALS, AND EQUIPMENT SHALL BE SUPPLIED AND INSTALLED AS DIRECTED BY THE MANUFACTURER UNLESS NOTED OTHERWISE.
- 13. ANY WORK OR MATERIAL NOT ACCEPTABLE OR NOT CONFORMING TO LAW AND REGULATIONS BY ALL BODIES HAVING JURISDICTION SHALL BE REMOVED AT THE REQUEST OF THE ARCHITECT AND/OR GENERAL CONTRACTOR. REJECTION OF CONTRACTOR'S WORK SHALL BE IN ACCORDANCE WITH BUT NOT LIMITED TO: - DEVIATION FROM PLANS AND SPECIFICATIONS.
- WORKMANLIKE" MANNER.
- 14. CONSTRUCTION PERSONNEL MUST CARRY PROPER IDENTIFICATION AT ALL TIMES (SECURITY BADGES). COORDINATE WITH APPROPRIATE FACILITY SECURITY
- DEVICES FOR PROTECTION OF THE PUBLIC AND WORKPERSONS.
- 18. THE CONTRACTOR SHALL BE RESPONSIBLE FOR DAILY CLEAN UP OF THE PREMISES AND PROMPT

# APPROVAL TO THE ARCHITECT. BURDEN OF PRICE AND QUALITY IS THE CONTRACTOR'S

- 12. ALL WORK SHALL BE GUARANTEED FOR A PERIOD OF ONE YEAR. WARRANTY AND GUARANTEES OF EQUIPMENT SHALL BE THOSE OF MANUFACTURER FOR PERIOD SO STATED.
- ANY EQUIPMENT OR MATERIALS NOT INSTALLED IN A
- ANY EQUIPMENT OR MATERIAL THAT IS NOT INSTALLED PROPERLY ACCORDING TO MANUFACTURER'S RECOMMENDATIONS OR APPLICABLE BUILDING CODES.
- 15. THE CONTRACTOR SHALL PROVIDE PROTECTION OF ADJACENT PROPERTY AND
- 16. THE CONTRACTOR SHALL PROVIDE TEMPORARY SCAFFOLD, STAGING AND SAFETY
- 17. ALL EXITS SHALL BE KEPT READILY ACCESSIBLE AND UNOBSTRUCTED AT ALL TIMES. FIRE EXTINGUISHERS MUST BE KEPT ON THE JOB SITE DURING CONSTRUCTION.
- REMOVAL OF ALL WASTE MATERIALS AS GENERATED BY CONSTRUCTION, DEMOLITION, AND/OR DELIVERY AND INSTALLATION OF ANY PRODUCTS, MATERIALS, OR EQUIPMENT WHICH IS PART OF

# **ABBREVIATIONS**


LAVATORY

AFF ADJ AHU AL AN APPROX	ABOVE FINISHED FLOOR ADJUSTABLE AIR HANDLING UNIT ALUMINUM CLEAR ANODIZED ALUMINUM APPROXIMATELY	MFGR MO MAX MDF MIN ML	MANUFACTURE/MANUFACTURER MASONRY OPENING MAXIMUM MEDIUM DENSITY FIBERBOARD MINIMUM MICROLAM
BCoNYS B/O BOT BW	BUILDING CODE of NEW YORK STATE BOTTOM OF BOTTOM (OF) BEARING WALL	NA NIC NTS	NOT APPLICABLE NOT IN CONTRACT NOT TO SCALE
CB CPT	CERAMIC TILE BASE CARPET	OC OPP	ON CENTER OPPOSITE
CPT CT CONC CONT	CERAMIC TILE CONCRETE CONTINUOUS	PT PL PL	PAINT PLATE PLASTIC LAMINATE
DIA	DIAMETER	REQD	REQUIRED
ELEV. EX EXST EQ	ELEVATION EXISTING EXISTING EQUAL FEET	SIM SCW SQ SQ FT STL STN	SIMILAR SOLID CORE WOOD SQUARE SQUARE FEET STEEL STAIN
FRP FL FD FND	FIBERGLASS REINFORCED PLASTIC FLOOR FLOOR DRAIN FOUNDATION	T&G T/O TYP	TOUNGUE AND GROOVE TOP OF TYPICAL
GAL GT GWB	GALVANIZED GIRDER TRUSS GYPSUM WALL BOARD	UNO VB	UNLESS NOTED OTHERWISE VINYL BASE
HC HVAC HM	HANDICAPED ACCESSIBLE HEATING VENTILATION/AIR CONDITIONING HOLLOW METAL	VERT VIF VF	VERTICAL VERIFY IN FIELD VINYL FLOORING
HOR	HORIZONTAL	WD	WOOD
LW	LAMINATED WOOD		

# LAUNDROMAT **EXISTING RENOVATION**

67 ONTARIO STREET, ALBANY

#### LOCATION PLAN (NTS)

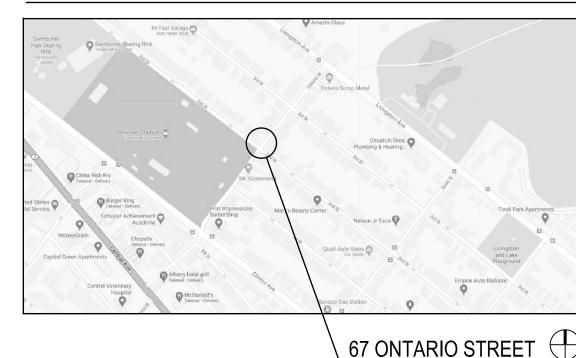



#### PROJECT NARRATIVE

- THIS PROJECT ENTAILS INSTALLING A SELF SERVICE LAUNDROMAT FACILITY ON THE FIRST FLOOR OF A RECENTLY RENOVATED 2 STORY BUILDING. THE FIRST FLOOR IS 1300 SQFT. THE LAUNDROMAT TENANT SPACE IS 850 SQFT.
- THERE ARE EXISTING FIRE SEPARATIONS IN PLACE AT THE FLOOR/CEILING AND THE STAIRWELL.
- THERE IS AN EXISTING ADA BATHROOM TO REMAIN.

EXTERIOR BEARING WALLS:

INTERIOR BEARING WALLS:

ROOF CONSTRUCTION:

#### **CODE REVIEW**


- 1. THE GOVERNING CODE IS THE 2020 INTERNATIONAL BUILDING CODE W/ NYS SUPPLEMENT.
- 2. THIS PROJECT HAS BEEN DESIGNED TO THE BEST OF MY BELIEF, KNOWLEDGE and PROFESSIONAL JUDGMENT TO BE IN COMPLIANCE with CHAPTER 11 ACCESSIBILITY of THE BUILDING CODE of NEW YORK STATE.

3. USE CLASSIFICATION:	BUSINESS (B)
4. OCCUPANCY CLASSIFICATION:	BUSINESS (B)
5. CLASSIFICATION OF WORK:	ALTERATION LEVEL 3
6. CONSTRUCTION CLASSIFICATION:	TYPE 5B, NON SPRINKLERED
7. ALLOWABLE HEIGHTS AND AREAS BASE <u>ASSEMBLY (B):</u> ALLOWABLE AREA W/O SPRINKLERS: ALLOWABLE HEIGHT W/O SPRINKLERS:	9,000 SQFT
8. ACTUAL HEIGHTS AND FIRE AREAS: ACTUAL AREA: ACTUAL HEIGHT:	2,600 SQFT 30 FEET, 2 STORIES
9. FIRE—RESISTANCE RATING REQUIREMENT STRUCTURAL FRAME: 0 HOL	

0 HOURS

0 HOURS

0 HOURS

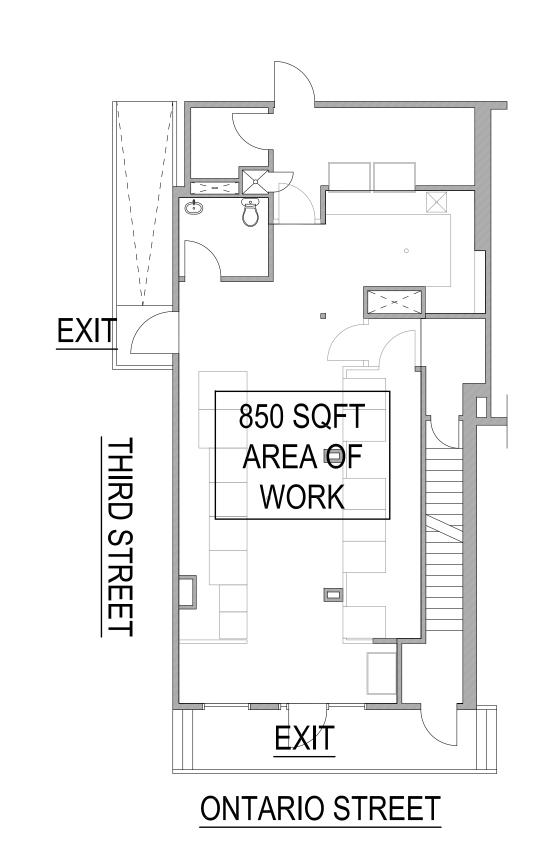



## **LOCAL DESIGN STUDIO**

1915 5TH AVENUE SUITE 104 TROY, NY 12180 **DESIGNISLOCAL.COM** 518.326.0536





**CONSULTANTS:** 

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### PROJECT:

**RESTAURANT EXPANSION** THE SHAKER AND VINE 221 HARBORSIDE DRIVE MOHAWK HARBOR SCHENECTADY, NY

OWNER:

PROJECT NO. 20036

DATE:


**CONSTRUCTION PLAN** 


9/17/2020


SHEET NUMBER:

DOOR SCHEDULE											
DOOR					SIZE		HARDWARE	NOTES			
NUMBER	TYPE	MATERIAL	FINISH	WIDTH	HEIGHT	THICKNESS	GROUP	NOTES			
1	1	METAL	FFP	3'-0"	6'-8"	1¾"	STORAGE	FRONT DOOR			
2	1	METAL	FFS	3'-0"	6'-8"	1¾"	STORAGE	CLOSET DOOR			
3	1	METAL	FFS	3'-0"	6'-8"	1¾"	STORAGE	BEDROOM DOOR	DOOR TYPE 1		

 $\longleftarrow$  REAR YARD AREA  $\longrightarrow$ 

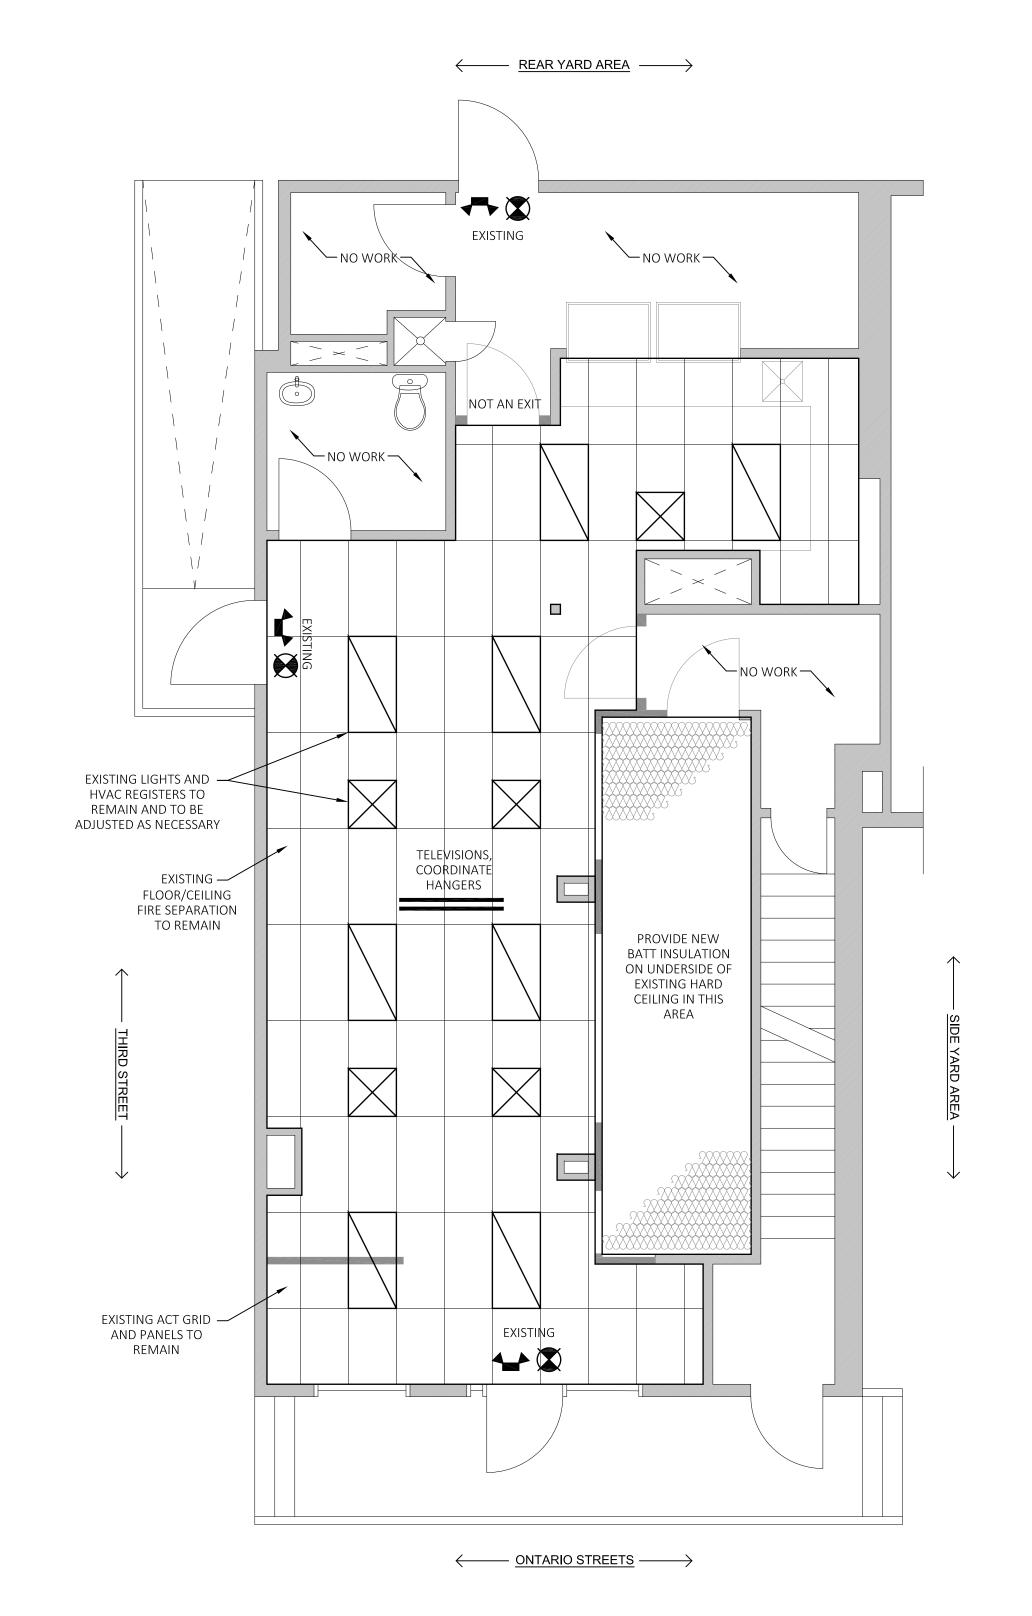

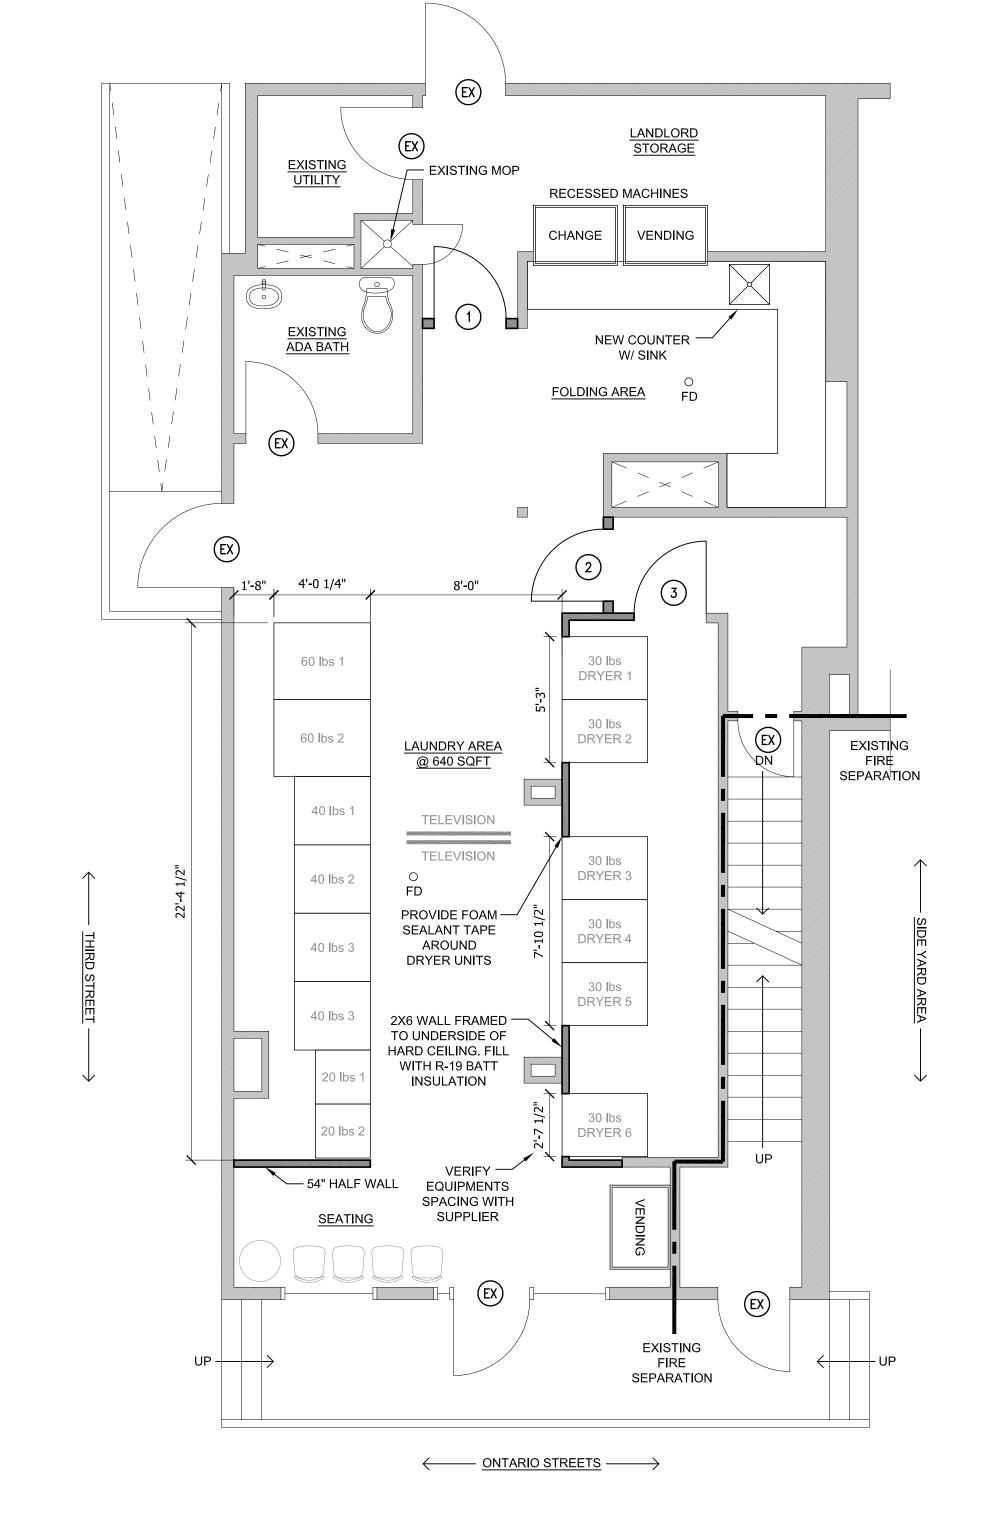

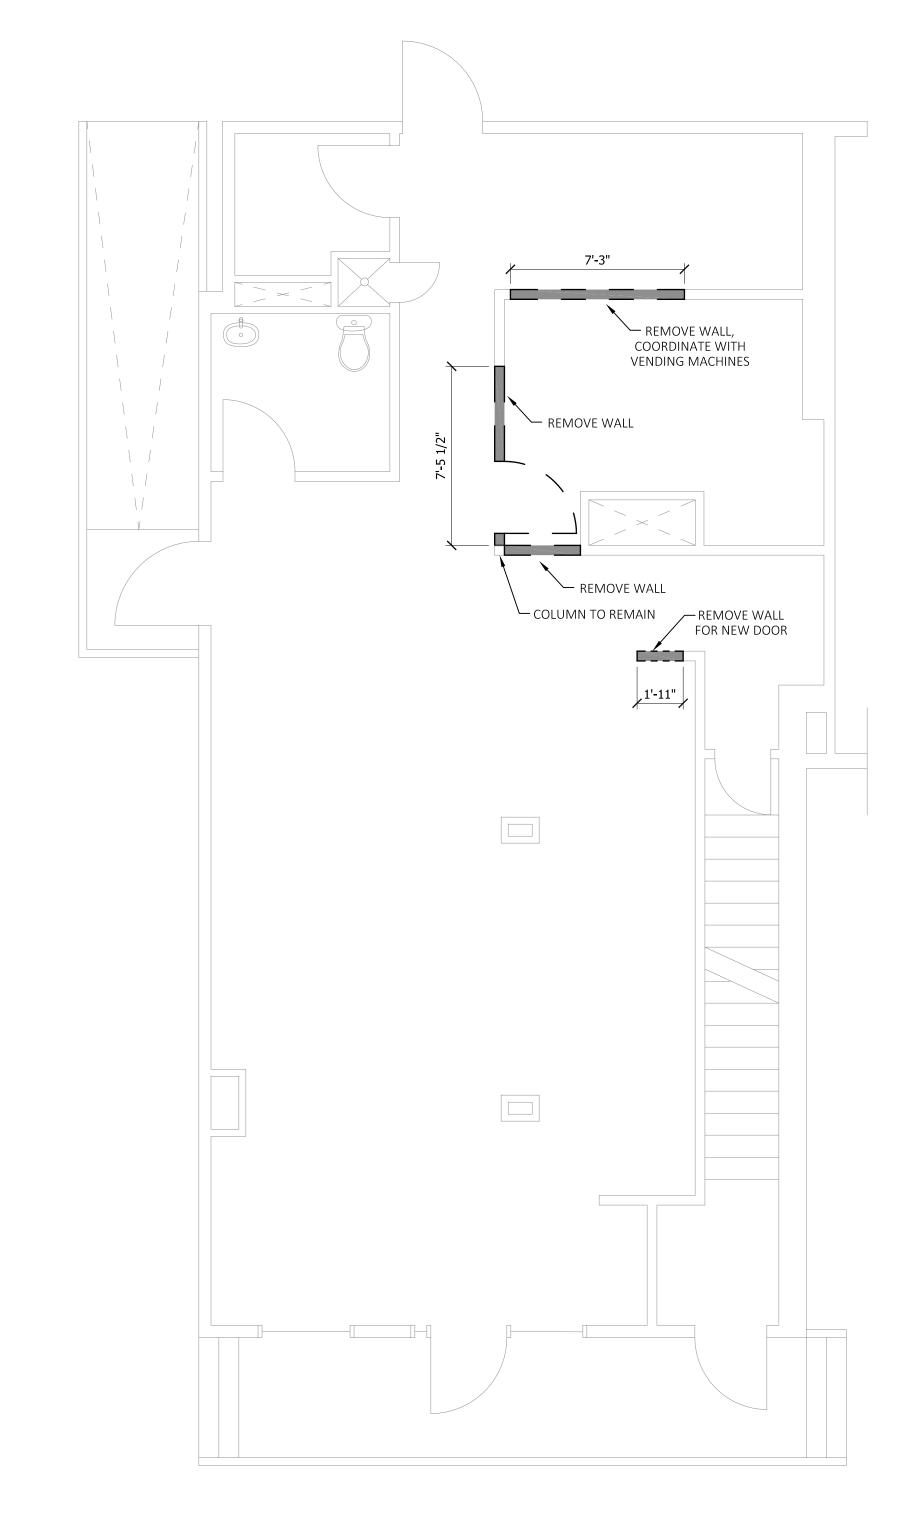









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SEAL:



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PROTECTION ACT AND ANY
REVISIONS THEREOF

PROJECT:

LAUNDROMAT FIT UP

67 ONTARIO STREET ALBANY, NY

OWNER:

PROJECT NO.

\_\_\_\_


**DATE:** 10/7/2020


20025


CONSTRUCTION DRAWINGS

SHEET NUMBER:

A101

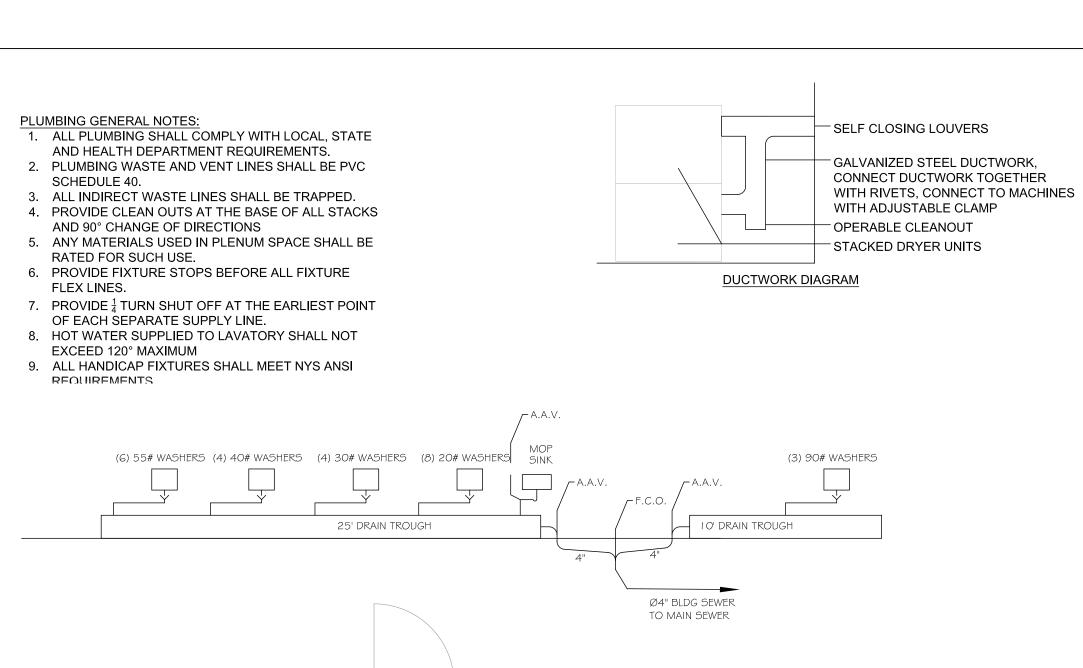

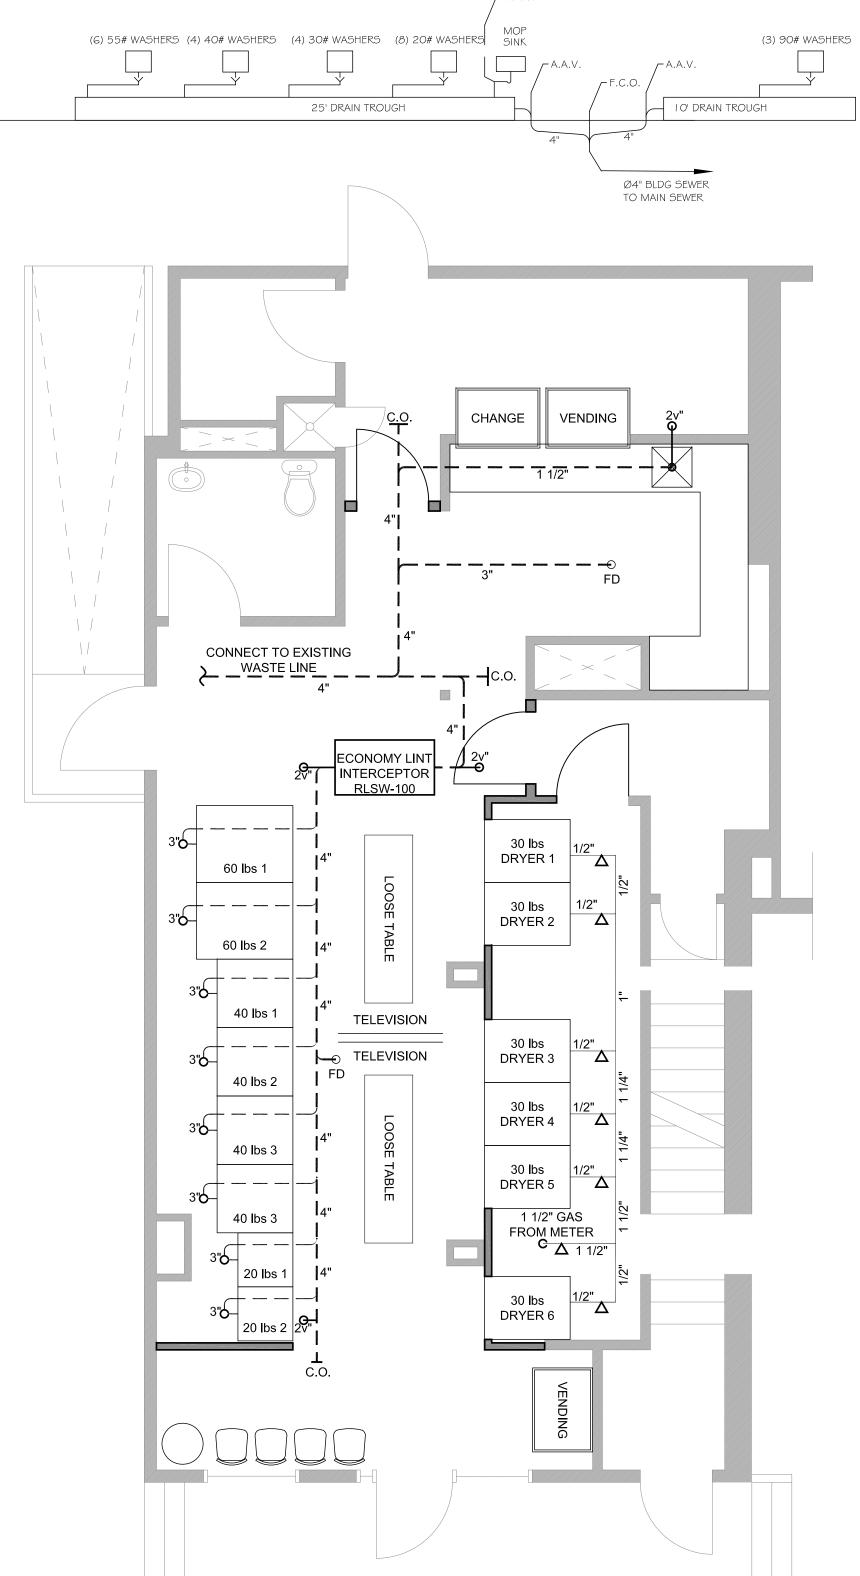

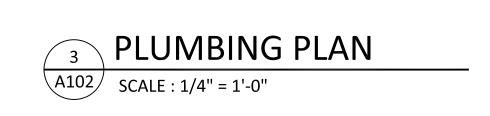



EH 060 DRYERS

**DUCTWORK NOTES:** 

1. ALL DUCTWORK SHALL BE CONNECTED WITH RIVETS AND SEALED WITH DUCT SEAL 2. ALL DUCTWORK SHALL BE 20 GA. MINIMUM.

AREAS BEHIND MACHINES.


4. ALL DUCTWORK SHALL BE SUPPORTED

3. ALL DRYER MACHINES SHALL BE SEALED TIGHT TO

HORIZONTALLY IF ARMS ARE LONGER THAN 48"

INSULATED WALLS TO CREATE UNTEMPERED

TOTAL BTUs

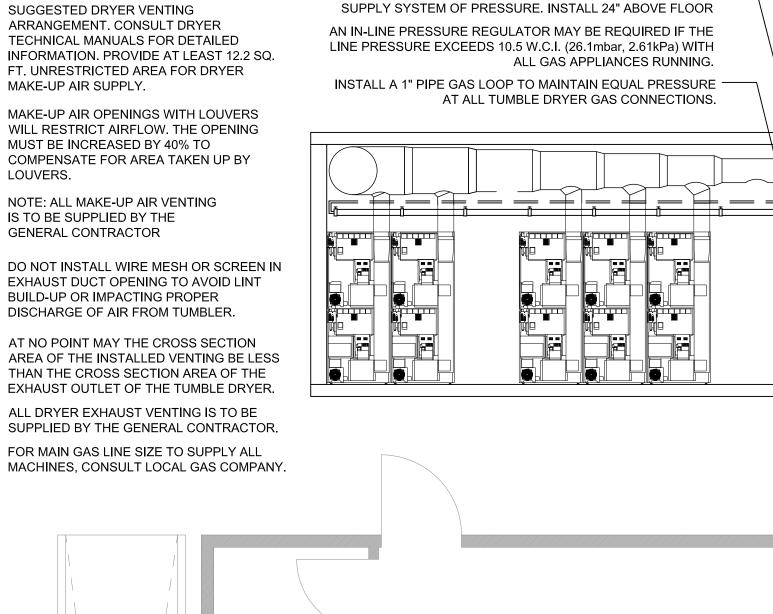

1 1/2" MAIN GAS LINE TO SUPPLY ALL MACHINES. LINE SIZED —

BASED ON RUN OF LESS THAN 100' (30.48m) AND USING A 1/2lb.

TUMBLE DRYERS TO BE VENTED


MAKE-UP AIR SUPPLY.


IS TO BE SUPPLIED BY THE


GENERAL CONTRACTOR

LOUVERS.


INDIVIDUALLY THROUGH THE ROOF.

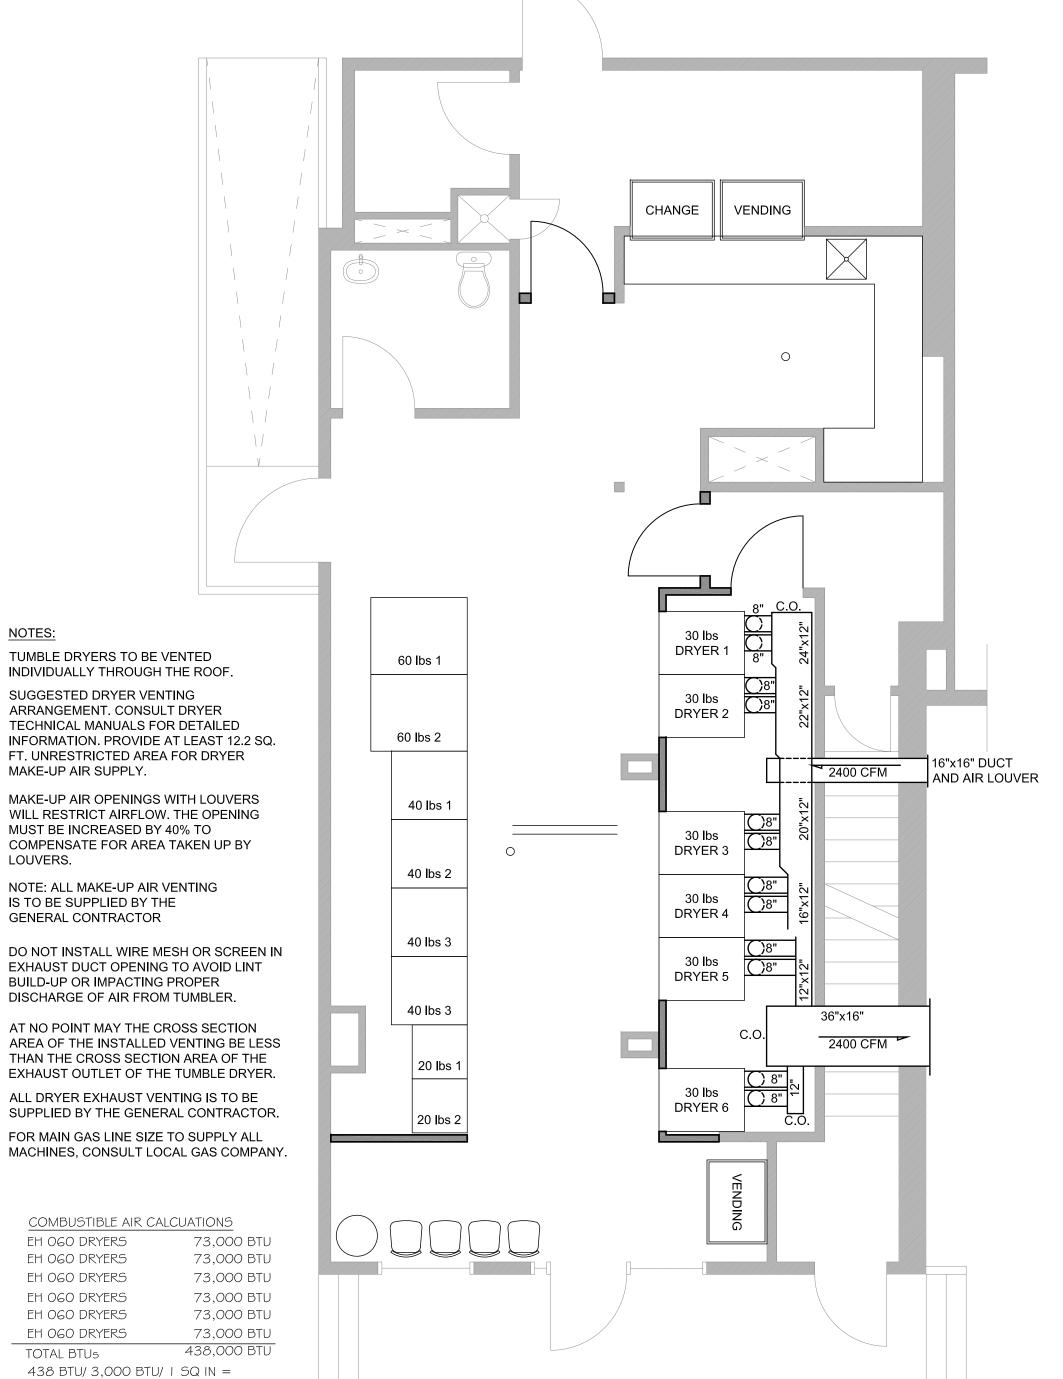

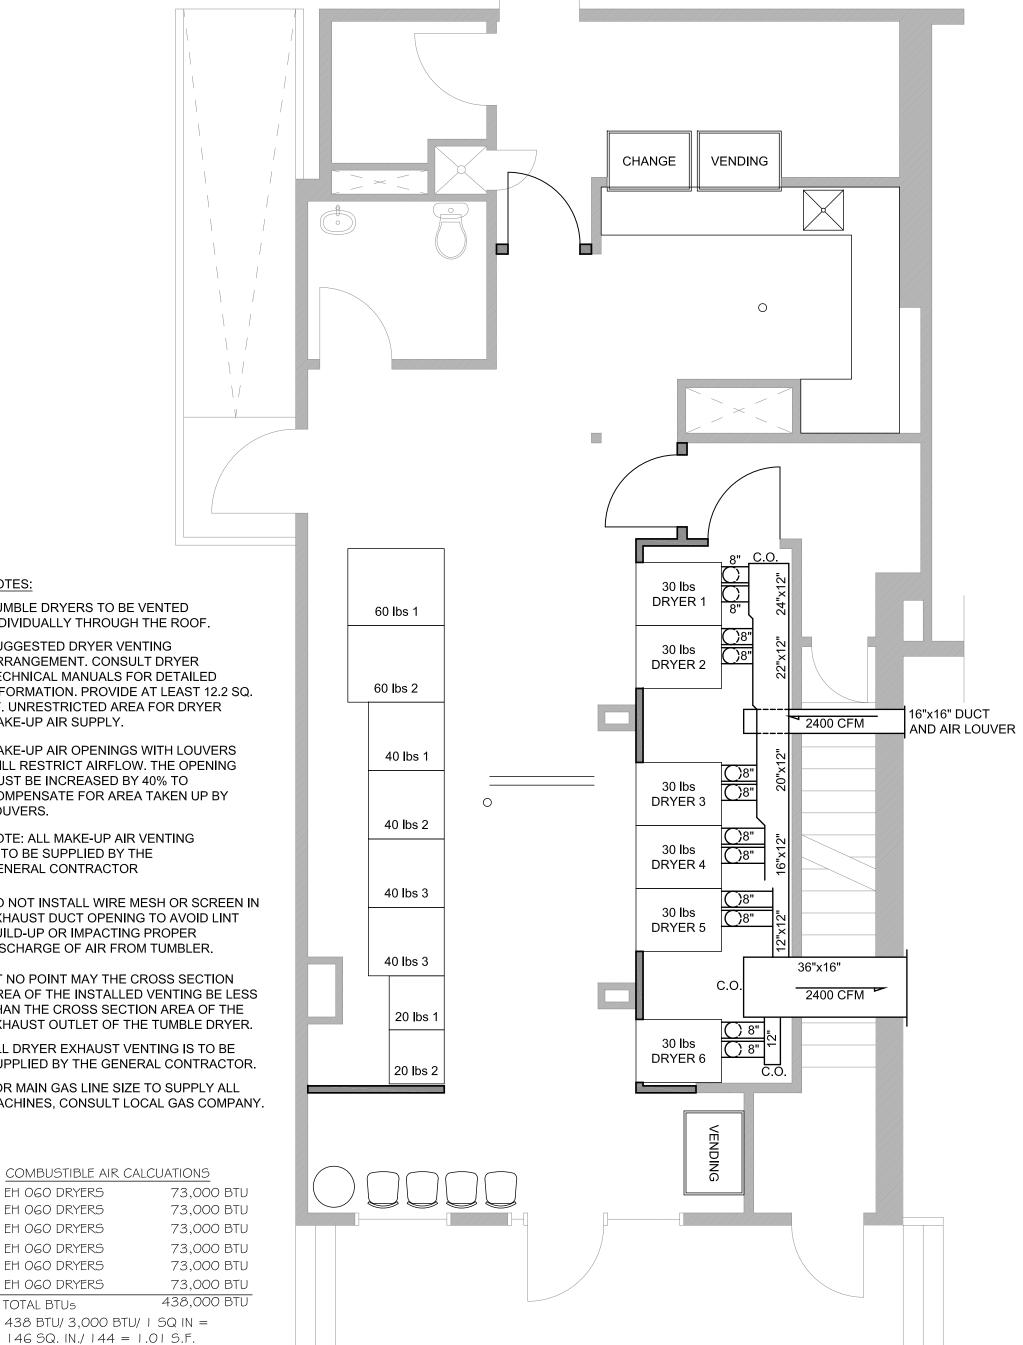

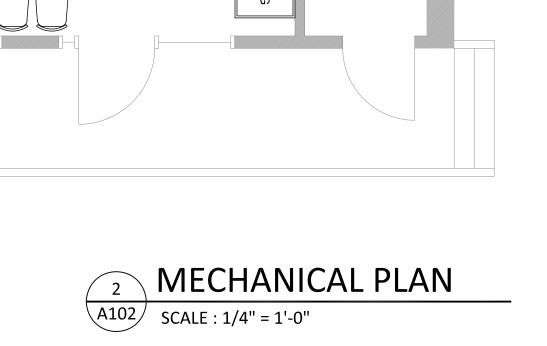

NO. DEM. V.A.	TRIP POLE	WIRE	DESCRIPTION	C K T	C K T	DESCRIPTION	WIRE	TRIP POLE	NO. DEM. V.A.		NO. DEM. V.A.	TRIP POLE	WIRE	DESCRIPTION	C K T	C K T	DESCRIPTION	WIRE	TRIP POLE	N Di V
375	20/1		WASHER	_	2	WASHER	12	20/1	375		375	15/1		WASHER	- 1	2	WASHER		15/1	37
375	20/1		WASHER	3	4	WASHER	12	20/1	375		375	15/1		WASHER	3	4	WASHER		15/1	37
375	20/1		WASHER	5	6	WASHER	12	20/1	375		375	15/1		VENDING	5	6	TV		15/1	37
375	20/1		DRYER	7	8	DRYER	12	20/1	375		375	15/1		VENDING	7	8			15/1	37
375	20/1		DRYER	9	10	DRYER	12	20/1	375						31	32				
375	20/1		DRYER	1.1	12	DRYER	12	20/1	375						33	34				
															35	36				
															37	38				
															39	40				
										İ					41	42				·

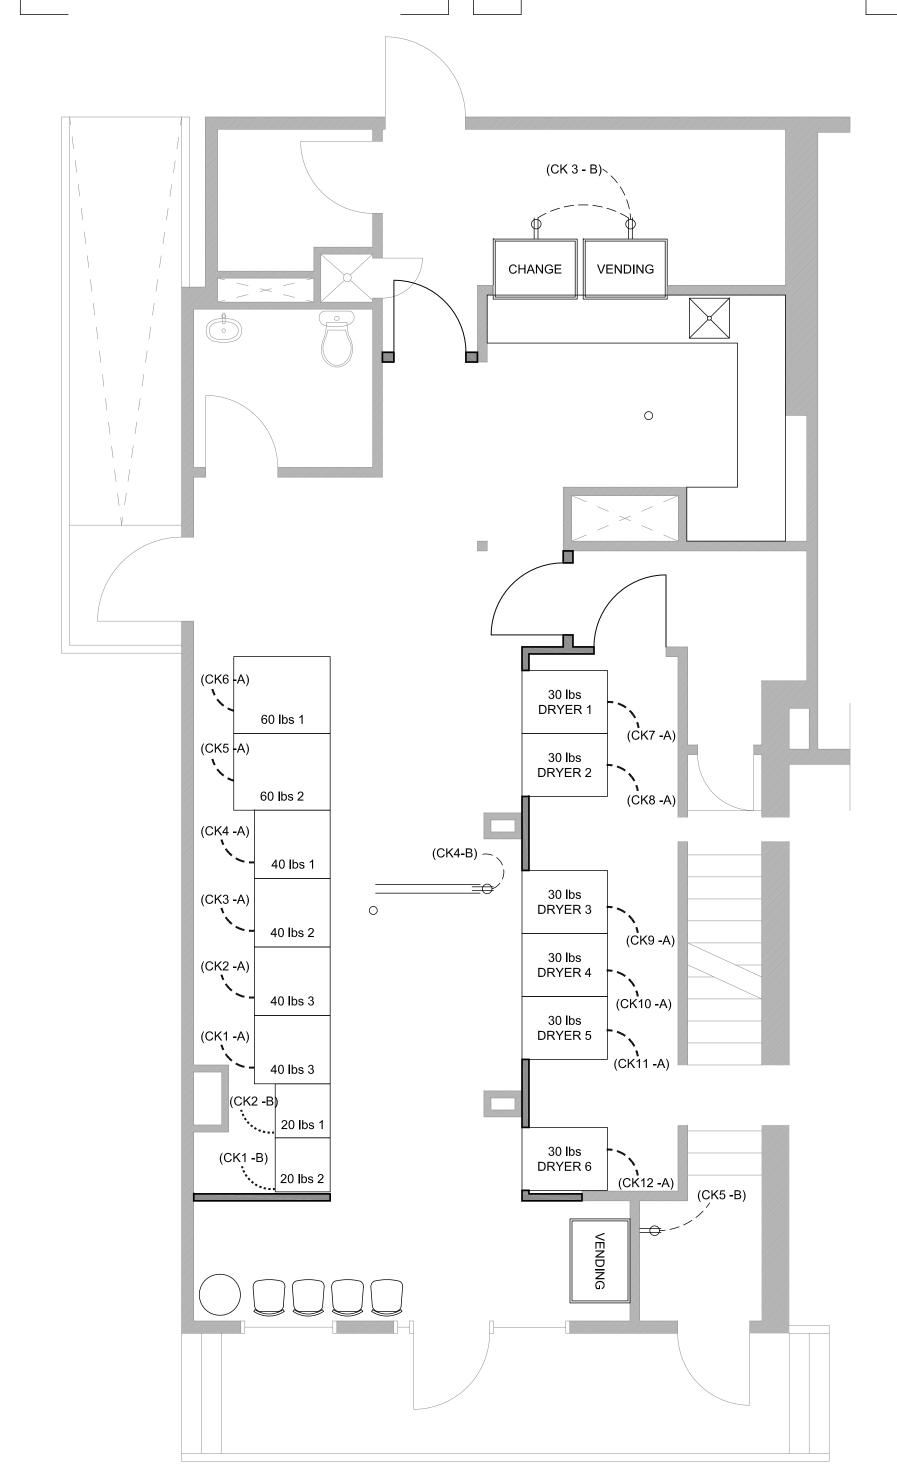

ELECTRICAL PLAN

A102 | SCALE : 1/4" = 1'-0"



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**SEAL:** 

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PROJECT:

**LAUNDROMAT FIT UP** 

**67 ONTARIO STREET** ALBANY, NY

**OWNER:** 

PROJECT NO.

10/7/2020 DATE:

20025

**CONSTRUCTION DRAWINGS** 

SHEET NUMBER: