

#### **SITE PLAN NOTES:**

**GENERAL CONSTRUCTION NOTES:** 

- THE CONTRACTOR SHALL PROTECT EXISTING PROPERTY LINE MONUMENTATION. ANY MONUMENTATION DISTURBED OR DESTROYED, AS JUDGED BY THE CITY OF ALBANY, THE ENGINEER OF RECORD OR THE OWNER, SHALL BE REPLACED AT THE CONTRACTOR'S
- EXPENSE AND UNDER THE SUPERVISION OF A NEW YORK STATE LICENSED LAND SURVEYOR. 2. RIGHT OF WAY ACCESS APPLICATIONS AND STREET OPENING PERMITS ARE REQUIRED FROM THE CITY OF ALBANY'S DEPARTMENT OF GENERAL SERVICES. 3. ALL PAVEMENT RESTORATION SHALL MEET AND MATCH EXISTING GRADES. NO POOLING OF
- STORMWATER WILL BE ACCEPTED BY THE CITY OF ALBANY. 4. ALL SAWCUT LINES SHALL BE PARALLEL, PERPENDICULAR, AND CURVILINEAR TO EXISTING OR PROPOSED CURBING AND SHALL BE A CONSTANT DISTANCE OF 18" MIN AWAY. SAWCUTS TO BE IN ACCORDANCE WITH CITY STANDARD DETAILS.
- ALL ARCHITECTURE IS SUBJECT TO PLANNING BOARD REVIEW. 6. NOTIFY ENGINEER 48 HOURS PRIOR TO INITIALIZATION OF ANY WORK ON SITE. 7. THE ENGINEER SHALL BE NOTIFIED IN WRITING OF ANY CONDITIONS THAT VARY FROM THOSE SHOWN ON THE PLANS. THE CONTRACTOR'S WORK SHALL NOT VARY FROM THE
- PLANS WITHOUT PRIOR REVIEW FROM THE ENGINEER. 8. CONTRACTOR IS RESPONSIBLE FOR EMPLOYING AND MAINTAINING ALL TRAFFIC CONTROL AND SAFETY MEASURES DURING CONSTRUCTION.
- 9. CONTRACTOR IS RESPONSIBLE FOR PROPERLY & SAFELY MAINTAINING AREA BETWEEN ALL ADJOINING PROPERTIES. 10. NO WORK, STORAGE OR TRESPASS SHALL BE PERMITTED BEYOND THE SITE PROPERTY
- LINES OR PUBLIC RIGHT-OF-WAY. 11. ALL EXISTING LAWN AREA, CURBING, PAVING, SIDEWALKS, CULVERTS OR OTHER PUBLIC OR PRIVATE PROPERTY DAMAGED BY TRENCHING OR EXCAVATION OPERATIONS SHALL BE REPLACED OR REPAIRED TO A CONDITION EQUAL TO EXISTING, AS DESCRIBED IN CONTRACT DOCUMENTS OR AS ORDERED BY ENGINEER (AOBE). MAILBOXES, SIGN POSTS, ETC SHALL BE PROTECTED OR REMOVED AND REPLACED EXACTLY AS THEY WERE BEFORE BEING DISTURBED. REMOVE AND REPLACE AFFECTED CURBING AND SIDEWALK TO NEAREST JOINT. REMOVE PAVEMENT AND REPLACE TO SAW CUT LINE, SAW CUT IN STRAIGHT LINE TO POINT

1. BUILDING DIMENSIONS TO BE TAKEN FROM ARCHITECTURAL BUILDING PLANS. NOTIFY THE ENGINEER OF ANY DEVIATION FROM CONDITIONS SHOWN ON THIS PLAN. 2. THE CONTRACTOR SHALL BE RESPONSIBLE FOR COORDINATING ALL FIELD LAYOUT. THE CONTRACTOR SHALL TAKE TIES TO ALL UTILITY CONNECTIONS AND PROVIDE MARKED-UP AS BUILT PLANS FOR ALL UTILITIES SHOWING TIES TO CONNECTIONS, BENDS, VALVES. LENGTHS OF LINES AND INVERTS. AS-BUILT PLANS SHALL BE REVIEWED BY THE OWNER AND THE ENGINEER AND THE CONTRACTOR SHALL PROVIDE ANY CORRECTION OR ADDITIONS TO THE SATISFACTION OF THE OWNER AND THE ENGINEER BEFORE UTILITIES WILL BE

NEEDED TO BLEND GRADE, REMOVE LAWN AND REPLACE TO MINIMUM LIMIT OF EXCAVATION.

#### PAVING:

NO VEHICULAR TRAFFIC OF ANY SORT SHALL BE PERMITTED ON THE SURFACE OF SUBBASE COURSE MATERIAL ONCE IT HAS BEEN FINE GRADED, COMPACTED, AND IS READY FOR PAVING. SUBBASE MATERIAL SO PREPARED FOR PAVING SHALL BE PAVED WITHIN THREE

- DAYS OF PREPARATION. 2. SUBBASE MATERIAL AND THE VARIOUS ASPHALT CONCRETE MATERIALS CALLED FOR IN THESE DRAWINGS SHALL CONFORM WITH THE REFERENCED SECTION OF THE NEW YORK STATE DEPARTMENT OF TRANSPORTATION STANDARD SPECIFICATIONS FOR CONSTRUCTION AND MATERIALS, CURRENT EDITION, CONSTRUCTION SHALL BE AS FURTHER SET FORTH IN
- THOSE SPECIFICATIONS AND AS OTHERWISE PROVIDED FOR IN THESE DRAWINGS. 3. PLACE ASPHALT CONCRETE MIXTURE ON PREPARED SURFACE, SPREAD AND STRIKE-OFF USING A SELF-PROPELLED PAVING MACHINE, WITH VIBRATING SCREED. PLACEMENT IN INACCESSIBLE AND SMALL AREAS MAY BE BY HAND.
- 4. PROVIDE JOINTS BETWEEN OLD AND NEW PAVEMENTS OR BETWEEN SUCCESSIVE DAY'S
- 5. TACK COAT WHEN SPECIFIED OR CALLED OUT ON THE DRAWINGS OR REQUIRED BY THE REFERENCED SPECIFICATION SHALL CONFORM WITH THE FOLLOWING:
- A. TACK COAT SHALL MEET THE MATERIAL REQUIREMENTS OF 702-90 ASPHALT EMULSION FOR TACK COAT OF THE NEW YORK STATE DEPARTMENT OF TRANSPORTATION STANDARD SPECIFICATIONS FOR CONSTRUCTION AND MATERIALS, CURRENT EDITION, SHALL BE APPLIED IN ACCORDANCE WITH SECTION 407 — TACK COAT SHALL BE IN ACCORDANCE WITH THOSE SPECIFICATIONS AND AS OTHERWISE
- PROVIDED FOR IN THESE DRAWINGS. B. REMOVE LOOSE AND FOREIGN MATERIAL FROM ASPHALT SURFACE BEFORE PAVING
- NEXT COURSE. USE POWER BROOMS, BLOWERS OR HAND BROOM. C. APPLY TACK COAT TO ASPHALT PAVEMENT SURFACES & AND SURFACES OF CURBS, GUTTERS, MANHOLES, AND OTHER STRUCTURES PROJECTING INTO OR ABUTTING
- PAVEMENT. DRY TO A "TACKY" CONSISTENCY BEFORE PAVING. D. TACK COAT ENTIRE VERTICAL SURFACE OF ABUTTING EXISTING
- 6. AFTER COMPLETION OF PAVING AND SURFACING OPERATIONS, CLEAN SURFACES OF EXCESS OR SPILLED ASPHALT, GRAVEL OR STONE MATERIALS TO THE SATISFACTION OF THE
- 7. RESTORATIONS SHALL BE IN ACCORDANCE WITH NYSDOT AND CITY STANDARD DETAILS.

1. STRIPE PAVEMENT AS INDICATED ON THE PLANS AND/OR IN ACCORDANCE WITH ALL

2. COLOR: DRIVE LANE DIVIDERS - WHITE OR AOBE NO PARKING ZONE WARNINGS - WHITE OR AOBE PARKING DIVIDERS - WHITE OR AOBE WALKING LINES - WHITE OR AOBE HANDICAP PARKING LINES & SYMBOL - BLUE

### **GRADING NOTES:**

- GRADING PERMIT REQUIRED. CONTACT PATRICK MCCUTCHEON, ENGINEERING DIVISION, CITY OF ALBANY AT 518-434-2387 OR PMCCUTCHEON@ALBANYNY.GOV FOR PERMIT APPLICATION.
- PRIOR TO SITE DISTURBANCE. CONTRACTOR TO INSTALL EROSION & SEDIMENT CONTROL 3. IF ROCK IS ENCOUNTERED DURING CONSTRUCTION & REMOVAL BY BLASTING IS REQUIRED.
- THE CONTRACTOR SHALL OBTAIN ALL NECESSARY APPROVALS AND PERMITS REQUIRED BY THE AUTHORITY HAVING JURISDICTION.
- 4. ALL BLASTING OPERATIONS WILL ADHERE TO NEW YORK STATE AND LOCAL AUTHORITY ORDINANCES GOVERNING THE USE OF EXPLOSIVES. THE STATE REGULATIONS ARE
- CONTAINED IN 12 NYCRR 39 AND INDUSTRIAL CODE RULE 753. 5. STRIP ALL TOPSOIL PRIOR TO COMMENCING EARTHWORK OPERATIONS. TOPSOIL MAY BE
- STORED AND REUSED IN LAWN AND PLANTING AREAS ONLY. TOPSOIL AND SEED ALL AREAS DISTURBED BY CONSTRUCTION THAT ARE TO REMAIN GREEN. 6. BOX ALL TREES AND HOUSE ALL SHRUBS AND HEDGES BEFORE PLACING EARTH AGAINST OR NEAR THEM. ORNAMENTAL TREES, SHRUBS AND HEDGES WHICH MUST BE REMOVED DURING CONSTRUCTION SHALL BE HEALED IN AND RE-PLANTED IN AS GOOD A CONDITION
- AS THEY WERE BEFORE THEIR REMOVAL. ANY DAMAGED TREES, SHRUBS, AND/OR HEDGES SHALL BE REPLACED AT THE CONTRACTOR'S EXPENSE. 7. ALL EARTHWORK SHALL BE SMOOTHLY AND EVENLY BLENDED INTO EXISTING CONDITIONS. NO WORK, STORAGE OR TRESPASS SHALL BE PERMITTED BEYOND THE BOUNDARIES OF ANY
- EASEMENT OR PROPERTY LINE.
- 8. REMOVE ALL VEGETATION, TREES, STUMPS, GRASSES, ORGANIC SOILS, DEBRIS AND DELETERIOUS MATERIALS WITHIN THE AREAS SLATED FOR CONSTRUCTION.
- 9. IF PREVIOUSLY UNKNOWN CULTURAL, ARCHEOLOGICAL, OR HISTORIC REMAINS OR ARTIFACTS ARE DISCOVERED IN THE COURSE OF CONSTRUCTION OF THIS PROJECT, THE PROJECT SPONSORS SHALL SUSPEND CONSTRUCTION OPERATIONS IN THE PERTINENT AREA AND SHALL NOTIFY THE PROJECT ENGINEER. CONSTRUCTION IN THAT AREA SHALL RESUME ONLY AFTER COMPLETION OF FEDERAL, TRIBAL, AND STATE COORDINATION TO DETERMINE WHETHER PROTECTION OR RECOVERY OF THE REMAINS IS WARRANTED, OR WHETHER THE SITE IS ELIGIBLE FOR LISTING IN THE NATIONAL REGISTER OF HISTORIC PLACES.

### **CITY OF ALBANY STANDARD NOTES:**

- PRIOR TO THE START OF CONSTRUCTION, OBTAIN WATER/SEWER SERVICE PERMITS FOR ALL PROPOSED UTILITY CONNECTIONS. PARTICIPATE IN A PRECONSTRUCTION MEETING WITH THE
- CITY OF ALBANY WATER DEPARTMENT. 2. CONTACT THE CITY OF ALBANY WATER DEPARTMENT A MINIMUM OF 48 HOURS PRIOR TO ANY WORK ON THE WATER/SEWER/STORM SYSTEMS FOR INSPECTION PURPOSES.
- PRIOR TO USE ALL WATER LINES MUST BE CHLORINATED AND HAVE A BACTERIOLOGICAL TEST PERFORMED IN ACCORDANCE WITH CITY OF ALBANY STANDARDS.
- 4. PRESSURE AND LEAKAGE TESTING OF THE WATER MAIN SHALL BE WITNESSED BY CITY OF ALBANY WATER DEPARTMENT STAFF AND ACCEPTABLE BACTERIOLOGICAL TEST MUST BE SUBMITTED AND ACCEPTED BY THE DEPARTMENT PRIOR TO FINAL APPROVAL OF THE NEW
- 5. PRIOR TO ISSUANCE OF A CERTIFICATE OF OCCUPANCY, CONTRACTOR SHALL PROVIDE THE CITY OF ALBANY WATER DEPARTMENT WITH BOTH AUTOCAD AND PAPER AS-BUILTS. COORDINATE SYSTEM TO BE NAD83 HORIZONTAL AND NAVD88 VERTICAL.

#### **UTILITY PLAN NOTES:**

- 1. STREET OPENING PERMITS AND RIGHT-OF-WAY ACCESS APPLICATIONS ARE REQUIRED. CONTACT GARY BOHL, DEPARTMENT OF GENERAL SERVICES, CITY OF ALBANY AT 518-462-3519 OR GBOHL@ALBANYNY.GOV FOR PERMITS AND APPLICATIONS.
- 2. ALL UNDERGROUND UTILITIES ARE SHOWN IN THEIR RELATIVE POSITION AND ARE FOR INFORMATIONAL PURPOSES ONLY. CONTRACTOR TO VERIFY THEIR ACTUAL LOCATION IN THE FIELD PRIOR TO THE COMMENCEMENT OF CONSTRUCTION.
- 3. ANY CONDITION ENCOUNTERED IN THE FIELD DIFFERING FROM THOSE SHOWN HEREON, SHALL BE REPORTED TO THE DESIGN ENGINEER BEFORE CONSTRUCTION IS TO PROCEED.
- 4. SEWER MAINS IN RELATION TO WATER MAINS: WHERE POSSIBLE, SEWERS SHALL BE LAID AT LEAST 10 (TEN) FEET HORIZONTALLY FROM ANY EXISTING OR PROPOSED WATER MAIN. VERTICAL SEPARATION SHALL BE MAINTAINED TO PROVIDE 18 (EIGHTEEN) INCHES BETWEEN TOP OF SEWER AND BOTTOM OF THE WATER MAIN AT UTILITY CROSSINGS. WHEN NOT POSSIBLE TO OBTAIN THE PROPER VERTICAL SEPARATION, SEWER PIPE SHALL BE PRESSURE RATED AND TESTED @ 150psi, 10 (TEN) FEET ON EACH SIDE OF THE WATER MAIN BEING
- 5. ALL PROPOSED UTILITIES SHALL TERMINATE 5 FEET FROM ANY PROPOSED BUILDING FACE. CONTRACTOR TO COORDINATE WITH BUILDING PLANS FOR ANY CONNECTIONS.
- 6. ALL STORM SEWER SHALL BE SMOOTH INTERIOR HDPE UNLESS OTHERWISE SPECIFIED. 7. ALL GRAVITY SANITARY SEWER SHALL BE SDR 26 PVC UNLESS OTHERWISE SPECIFIED. 8. ALL WATER PIPE SHALL BE CL52 DUCTILE IRON PIPE UNLESS OTHERWISE SPECIFIED.
- . CONTRACTOR TO VERIFY STATUS OF ALL UTILITY SERVICES PRIOR TO INTERRUPTION. 10. EXPLORATORY EXCAVATIONS SHALL BE PERFORMED BY THE CONTRACTOR AT ALL UTILITY
- CONNECTION LOCATIONS AND AS NEEDED TO VERIFY EXISTING CONDITIONS PRIOR TO PERFORMING WORK. 11. BEFORE CONSTRUCTING LINES TO CONNECT TO EXISTING UTILITIES, VERIFY EXISTING UTILITY
- INVERTS AND NOTIFY THE ENGINEER IF ANY VARIATION FROM THE PLAN IS REQUIRED. 12. THE CONTRACTOR SHALL MAINTAIN ALL EXISTING UTILITIES IN SERVICE FOR THE DURATION
- 13. THE CONTRACTOR SHALL COMPLY WITH ALL REQUIRED PERMITS AND ASSOCIATED CONDITIONS
- 14. CONTRACTOR SHALL BE RESPONSIBLE FOR DEWATERING UTILITY TRENCHES AND EXCAVATIONS AND FOR THE MAINTENANCE OF SURFACE DRAINAGE DURING THE COURSE OF
- 15. IF ROCK REMOVAL BY BLASTING IS REQUIRED, THE CONTRACTOR SHALL OBTAIN ALL NECESSARY APPROVALS AND PERMITS REQUIRED BY THE AUTHORITY HAVING JURISDICTION.

#### **DEMOLITION NOTES:**

- REFER TO REQUIREMENTS OUTLINED IN THE EROSION & SEDIMENTS CONTROL PLANS, DETAILS, & NOTES PRIOR TO COMMENCEMENT OF WORK.
- 2. BUILDING/STRUCTURE TO BE DEMOLISHED ARE SHOWN FOR REFERENCE PURPOSES ONLY AND ARE NOT TO BE DEMOLISHED AS PART OF THIS WORK. PRIOR TO DEMOLISHING ANY BUILDINGS/STRUCTURES. THE CONTRACTOR SHALL PERFORM A PRE-DEMOLITION SURVEY IN ACCORDANCE WITH STATE AND FEDERAL REGULATIONS GOVERNING THE DISPOSAL OF SOLID WASTE. THE CONTRACTOR SHALL OBTAIN ALL NECESSARY PERMITS AND APPROVALS BY THE AUTHORITY HAVING JURISDICTION.
- 3. CONFORM TO APPLICABLE CODE FOR DEMOLITION OF STRUCTURES, SAFETY OF ADJACENT STRUCTURES, DUST CONTROL, RUNOFF CONTROL, AND HAULING, DISPOSAL AND STORAGE OF
- 4. PROVIDE, FRECT, AND MAINTAIN TEMPORARY BARRIERS AND SECURITY DEVICES. 5. MAINTAIN EXISTING UTILITIES TO REMAIN IN SERVICE AND PROTECT THEM AGAINST DAMAGE DURING SELECTIVE DEMOLITION OPERATIONS. DO NOT INTERRUPT EXISTING UTILITIES SERVING OPERATING FACILITIES, EXCEPT WHEN AUTHORIZED IN WRITING BY OWNER AND AUTHORITIES HAVING JURISDICTION.
- 6. CONTACT THE CITY OF ALBANY WATER DEPARTMENT A MINIMUM OF 48 HOURS PRIOR TO ANY WORK ON THE WATER/SEWER/STORM SYSTEMS FOR INSPECTION PURPOSES.
- NOTIFY ADJACENT OWNERS OF WORK THAT MAY AFFECT THEIR PROPERTY, POTENTIAL NOISE, UTILITY OUTAGE, OR DISRUPTION. COORDINATE WITH OWNER.
- 8. PREVENT MOVEMENT OR SETTLEMENT OF ADJACENT STRUCTURES. PROVIDE BRACING AND SHORING. CEASE OPERATIONS IMMEDIATELY IF ADJACENT STRUCTURES APPEAR TO BE IN
- DANGER. NOTIFY AUTHORITY HAVING JURISDICTION. 9. LOCATE AND IDENTIFY ALL EXISTING UTILITIES WITHIN THE CONSTRUCTION AREA. DISCONNECT AND SEAL OR CAP OFF UTILITY SERVICES THAT WILL BE AFFECTED BY THIS PROJECT. NOTIFY
- AFFECTED UTILITY COMPANIES BEFORE STARTING WORK AND COMPLY WITH THEIR REQUIREMENTS. VERIFY THAT UTILITIES HAVE BEEN DISCONNECTED AND CAPPED. 10. DEMOLISH AND REMOVE COMPONENTS IN AN ORDERLY AND CAREFUL MANNER.
- 11. PROTECT EXISTING FEATURES THAT ARE NOT TO BE DEMOLISHED. 12. CONDUCT OPERATIONS WITH MINIMUM INTERFERENCE TO PUBLIC OR PRIVATE ACCESSES. 13. MAINTAIN EGRESS AND ACCESS AT ALL TIMES. DO NOT CLOSE OR OBSTRUCT ROADWAYS, OR
- SIDEWALKS WITHOUT PERMITS. COORDINATE W/ AUTHORITY HAVING JURISDICTION. 14. ROUGH GRADE AND COMPACT AREAS AFFECTED BY DEMOLITION TO MAINTAIN SITE GRADES
- AND CONTOURS. 15. FIELD VERIFY EXISTING CONDITIONS AND CORRELATE WITH REQUIREMENTS INDICATED ON
- DEMOLITION PLAN TO DETERMINE EXTENT OF SELECTIVE DEMOLITION REQUIRED. 16. CONDUCT DEMOLITION OPERATIONS AND REMOVE DEBRIS TO ENSURE MINIMUM INTERFERENCE
- WITH SELECTIVE DEMOLITION OPERATIONS. 17. CONDUCT DEMOLITION OPERATIONS TO PREVENT INJURY TO PEOPLE AND DAMAGE TO
- ADJACENT BUILDINGS AND FACILITIES TO REMAIN. ENSURE SAFE PASSAGE OF PEOPLE AROUND SELECTIVE DEMOLITION AREA. 18. USE WATER MIST, TEMPORARY ENCLOSURES AND OTHER SUITABLE METHODS TO LIMIT THE
- SPREAD OF DUST AND DIRT. COMPLY WITH GOVERNING ENVIRONMENTAL PROTECTION REGULATIONS. DO NOT USE WATER WHEN IT MAY DAMAGE EXISTING CONSTRUCTION, SUCH AS CAUSING ICING, FLOODING, AND TRANSPORTING POLLUTANTS.
- 19. REMOVE AND TRANSPORT DEBRIS IN A MANNER THAT WILL PREVENT SPILLAGE ON ADJACENT SURFACES AND AREAS. 20. CLEAN ADJACENT STRUCTURES AND IMPROVEMENTS OF DUST, DIRT AND DEBRIS CAUSED BY
- SELECTIVE DEMOLITION OPERATIONS. RETURN ADJACENT AREAS TO CONDITION EXISTING BEFORE START OF SELECTIVE DEMOLITION.
- 21. PROMPTLY DISPOSE OF DEMOLISHED MATERIALS. ALL DEBRIS RESULTING FROM DEMOLITION ACTIVITIES SHALL BE DISPOSED OF OFF-SITE AT A FACILITY APPROVED TO RECEIVE THE DEBRIS. DO NOT ALLOW DEMOLISHED MATERIALS TO ACCUMULATE ON-SITE. DO NOT BURN
- DEMOLISHED MATERIALS ON-SITE. 22. AS REQUIRED BY CITY OF ALBANY, ALL WATER AND SEWER SERVICES TO BE DEMOLISHED SHALL BE REMOVED BACK TO THE MAIN.

### MAINTENANCE OF EROSION AND SEDIMENT CONTROL MEASURES:

PERMANENT AND TEMPORARY VEGETATION:
INSPECT ALL AREAS THAT HAVE RECEIVED VEGETATION EVERY SEVEN DAYS & AFTER EVERY RAIN EVENT. ALL AREAS DAMAGED BY EROSION OR WHERE SEED HAS NOT ESTABLISHED SHALL BE REPAIRED AND RESTABILIZED IMMEDIATELY.

STABILIZED CONSTRUCTION ENTRANCE:
INSPECT THE ENTRANCE PAD EVERY SEVEN DAYS & AFTER EVERY RAIN EVENT. CHECK FOR MUD,
SEDIMENT BUILD—UP AND PAD INTEGRITY. MAKE DAILY INSPECTIONS DURING WET WEATHER. RESHAPE PAD AS NEEDED FOR DRAINAGE AND RUNOFF CONTROL. WASH AND REPLACE STONE AS NEEDED. THE STONE IN THE ENTRANCE SHOULD BE WASHED OR REPLACED WHENEVER THE ENTRANCE FAILS TO REDUCE MUD BEING CARRIED OFF-SITE BY VEHICLES. IMMEDIATELY REMOVE MUD AND SEDIMENT TRACKED OR WASHED ONTO PUBLIC ROADS BY BRUSHING OR SWEEPING REMOVE TEMPORARY CONSTRUCTION ENTRANCE AS SOON AS THEY ARE NO LONGER NEEDED TO PROVIDE ACCESS TO THE SITE.

SILT FENCE:
INSPECT FOR DAMAGE EVERY SEVEN DAYS & AFTER EVERY RAIN EVENT. MAKE ALL REPAIRS IMMEDIATELY. REMOVE SEDIMENT FROM THE UP-SLOPE FACE OF THE FENCE BEFORE IT ACCUMULATES TO A HEIGHT EQUAL TO 1/3 THE HEIGHT OF THE FENCE. IF FENCE FABRIC TEARS, BEGINS TO DECOMPOSE, OR IN ANY WAY BECOMES INEFFECTIVE, REPLACE THE AFFECTED SECTION OF FENCE IMMEDIATELY.

SOIL STOCKPILE:
INSPECT SEDIMENT CONTROL BARRIERS (SILT FENCE OR HAY BALE) AND VEGETATION FOR DAMAGE EVERY SEVEN DAYS & AFTER EVERY RAIN EVENT. MAKE ALL REPAIRS IMMEDIATELY. REMOVE SEDIMENT FROM THE UP-SLOPE FACE OF THE SEDIMENT CONTROL BARRIER BEFORE I ACCUMULATES TO A HEIGHT EQUAL TO 1/3 THE HEIGHT OF THE SEDIMENT CONTROL BARRIER. IF SEDIMENT CONTROL BARRIER TEARS, BEGINS TO DECOMPOSE, OR IN ANYWAY BECOMES INEFFECTIVE, REPLACE THE AFFECTED SECTION OF SEDIMENT CONTROL BARRIER IMMEDIATELY. REVEGETATE DISTURBED AREA TO STABILIZE SOIL STOCK PILE. REMOVE THE SEDIMENT CONTROL BARRIER WHEN THE SOIL STOCKPILE HAS BEEN REMOVED.

<u>DUST CONTROL:</u>
SCHEDULE CONSTRUCTION OPERATIONS TO MINIMIZE THE AMOUNT OF DISTURBED AREAS AT ANY ONE TIME DURING THE COURSE OF WORK. APPLY TEMPORARY SOIL STABILIZATION PRACTICES SUCH AS MULCHING, SEEDING, AND SPRAYING (WATER). STRUCTURAL MEASURES (MULCH, SEEDING) SHALL BE INSTALLED IN DISTURBED ÀREAS BEFORE SIGNIFICANT BLOWING PROBLEMS DEVELOP. WATER SHALL BE SPRAYED AS NEEDED. REPEAT AS NEEDED, BUT AVOID EXCESSIVE SPRAYING, WHICH COULD CREATE RUNOFF AND EROSION PROBLEMS.

INSPECT ALL SEDIMENT TRAPS EVERY SEVEN DAYS & AFTER EVERY RAIN EVENT. REPAIRS SHALL BE MADE AS NEEDED. SEDIMENT SHALL BE REMOVED AND THE TRAP RESTORED TO THE ORIGINAL DIMENSIONS WHEN SEDIMENT HAS ACCUMULATED TO 1/2 OF THE DESIGN DEPTH OF THE TRAP.

STORM DRAIN INLET PROTECTION:
INSPECT ALL STORM DRAIN INLET PROTECTION DEVICES EVERY SEVEN DAYS & AFTER EVERY RAIN EVENT. MAKE REPAIRS AS NEEDED, REMOVE SEDIMENT FROM THE POOL AREA AS NECESSARY.

DEWATERING PITS:
(IF REQUIRED) — INSPECT DAILY DURING OPERATION FOR CLOGGING OR OVERFLOW. CLEAR INLET AND DISCHARGE PIPES OF OBSTRUCTIONS. IF A FILTER MATERIAL BECOMES CLOGGED WITH SEDIMENT, PIT SHALL BE DISMANTLED AND CONSTRUCT NEW PITS AS NEEDED.

SNOW AND ICE CONTROL:
PARKING LOTS, ROADWAYS, AND DRIVEWAYS ADJACENT TO WATER QUALITY FILTERS SHALL NOT BE SANDED DURING SNOW EVENTS DUE TO HIGH POTENTIAL FOR CLOGGING FROM SAND IN SURFACE WATER RUNOFF. USE SALT ONLY FOR SNOW AND ICE CONTROL.

#### SPDES GENERAL PERMIT GP-0-20-001 COMPLIANCE NOTES:

THE PROJECT DISCHARGES TO THE CITY OF ALBANY COMBINED SEWER SYSTEM, WHICH IS COVERED UNDER NYSDEC SPDES DISCHARGE PERMIT NY0025747. AS SUCH. THE PROJECT IS NOT SUBJECT TO THE NYSDEC SPDES GENERAL PERMIT FOR STORMWATER DISCHARGES FROM CONSTRUCTION ACTIVITY (GP-0-20-001). IN ACCORDANCE WITH CITY OF ALBANY REQUIREMENTS, A SWPPP HAS BEEN PREPARED AND A NOTICE OF INTENT AND SWPPP ACCEPTANCE FORM WILL BE SUBMITTED FOR ISSUANCE OF A STORMWATER PERMIT BY THE CITY. UPON COMPLETION OF CONSTRUCTION, A NOTICE OF TERMINATION MUST BE FILED WITH THE CITY.

THIS PLAN SET AND THE ACCOMPANYING SWPPP ENTITLED "THE SEVENTY-SIX" HAVE BEEN SUBMITTED AS A SET. THESE ENGINEERING DRAWINGS ARE CONSIDERED AN INTEGRAL PART OF THE SWPPP, THEREFORE THE PLAN SET IS NOT CONSIDERED COMPLETE WITHOUT THE SWPPP.

#### CONSTRUCTION SEQUENCING NOTES:

- PRIOR TO COMMENCING ANY CLEARING, GRUBBING, EARTHWORK ACTIVITIES, ETC.AT THE SITE, THE CONTRACTOR SHALL FLAG THE WORK LIMITS AND SHALL INSTALL TEMPORARY EROSION AND SEDIMENT CONTROL MEASURES (I.E. SILT FENCES, TREE PROTECTION/BARRIER FENCES, STABILIZED CONSTRUCTION ENTRANCES, STORM DRAIN SEDIMENT FILTERS, DRAINAGE DITCH SEDIMENT FILTERS, ETC.) INDICATED ON THE PROJECT DRAWINGS. TEMPORARY EROSION AND SEDIMENT CONTROL MEASURES MUST BE CONSTRUCTED, STABILIZED, AND FUNCTIONAL BEFORE SITE DISTURBANCE BEGINS WITHIN THEIR TRIBUTARY AREAS
- 2. THE CONTRACTOR SHALL CLEAR AND GRUB THE AREA OF THE STORMWATER MANAGEMENT FACILITIES. THIS AREA SHALL NOT EXCEED FIVE (5) ACRES IN EXTENT WITHOUT TEMPORARY STABILIZATION.
- 3. THE STORMWATER DETENTION BASIN SHALL BE UTILIZED AS A TEMPORARY SEDIMENT TRAP DURING CONSTRUCTION. THE CONTRACTOR SHALL INSTALL THE OUTLET CONTROL STRUCTURES AND THE EARTHEN BERM. THE BASIN SHALL BE GRADED TO THE TOP OF THE AQUATIC BENCH AS INDICATED IN THE TYPICAL STORMWATER MANAGEMENT BASIN SECTION PRESENTED IN THE PROJECT DRAWINGS
- 4. PRIOR TO COMMENCING CLEARING, GRUBBING AND/OR EARTHWORK ACTIVITIES IN ANY OTHER AREA OF THE SITE, THE CONTRACTOR SHALL INSTALL INLET AND OUTLET PROTECTION MEASURES (RIPRAP OVERFLOW WEIR(S), CULVERT INLET/OUTLET PROTECTION, ETC.) AND SHALL STABILIZE THE AREAS DISTURBED DURING THE CONSTRUCTION OF THE SEDIMENT BASIN.
- 5. THE CONTRACTOR SHALL INSTALL TEMPORARY DIVERSION MEASURES WITH ASSOCIATED STABILIZATION MEASURES (I.E., VEGETATIVE COVER, DRAINAGE DITCH SEDIMENT FILTERS, STORM DRAIN SEDIMENT FILTERS, ETC.)TO ASSURE THAT STORMWATER RUNOFF IS CONVEYED TO THE TEMPORARY SEDIMENT BASIN.
- 6. TEMPORARY DIVERSION MEASURES SHALL BE LOCATED IN A MANNER THAT WILL ASSURE THAT THE AREA TRIBUTARY TO EACH DIVERSION DOES NOT EXCEED FIVE (5) ACRES. THESE TEMPORARY DIVERSION MEASURES SHALL BE INSPECTED
- DAILY AND REPAIRED/STABILIZED AS NECESSARY TO MINIMIZE EROSION. 7. THE CONTRACTOR SHALL COMMENCE SITE CONSTRUCTION ACTIVITIES INCLUDING CLEARING & GRADING OF THE PROPOSED AREA OF DISTURBANCE AS REQUIRED.
- 8. INSTALL PROTECTIVE MEASURES AT THE LOCATIONS OF ALL GRATE INLETS, CURB INLETS, AND AT THE ENDS OF ALL EXPOSED STORM SEWER PIPES. 9. CONSTRUCT ALL UTILITIES, CURB AND GUTTER, GUTTER INLETS, AREA INLETS
- MAY BE REMOVED TEMPORARILY FOR THIS CONSTRUCTION. PLACE REQUIRED RIP-RAP AT LOCATIONS SHOWN ON THE PLANS. 10. FINALIZE PAVEMENT SUB-GRADE PREPARATION.

AND STORM SEWER MANHOLES, AS SHOWN ON THE PLANS. INLET PROTECTION

- 11. REMOVE PROTECTIVE MEASURES AROUND INLETS AND MANHOLES NO MORE THAN 24 HOURS PRIOR TO PLACING STABILIZED BASE COURSE.
- 12. INSTALL SUB-BASE MATERIAL AS REQUIRED FOR PAVEMENT. 13. PRIOR TO FINALIZING CONSTRUCTION OF THE STORMWATER MANAGEMENT FACILITY, ALL CATCH BASINS AND DRAINAGE LINES SHALL BE CLEANED OF ALL
- SILT AND SEDIMENT. 14. UPON COMPLETION OF SITE CONSTRUCTION ACTIVITIES, THE CONTRACTOR SHALL FINALIZE CONSTRUCTION OF THE STORMWATER MANAGEMENT FACILITY. CONTRACTOR SHALL FINISH GRADE THE FORBAY(S), AQUATIC BENCHES, AND
- WET POOL(S) AND STABILIZE AS INDICATED IN THE PROJECT DRAWINGS. 15. THE CONTRACTOR SHALL REMOVE ALL TEMPORARY EROSION AND SEDIMENT CONTROL MEASURES AND IMMEDIATELY ESTABLISH PERMANENT VEGETATION ON THE AREAS DISTURBED DURING THEIR REMOVAL.

#### **EROSION AND SEDIMENT CONTROL MEASURES:**

- DAMAGE TO SURFACE WATERS RESULTING FROM EROSION AND SEDIMENTATION SHALL BE MINIMIZED BY STABILIZING DISTURBED AREAS AND BY REMOVING SEDIMENT FROM CONSTRUCTION SITE DISCHARGES.
- 2. AS MUCH AS IS PRACTICAL, EXISTING VEGETATION SHALL BE PRESERVED. FOLLOWING THE COMPLETION OF CONSTRUCTION ACTIVITIES IN ANY PORTION OF THE SITE, PERMANENT VEGETATION SHALL BE ESTABLISHED ON ALL
- EXPOSED SOILS. 3. SITE PREPARATION ACTIVITIES SHALL BE PLANNED TO MINIMIZE THE SCOPE AND
- DURATION OF SOIL DISRUPTION. 4. PERMANENT TRAFFIC CORRIDORS SHALL BE ESTABLISHED AND "ROUTES OF CONVENIENCE" SHALL BE AVOIDED. STABILIZED CONSTRUCTION ENTRANCES SHALL BE INSTALLED AT ALL POINTS OF ENTRY ONTO THE PROJECT SITE.

#### GENERAL EROSION AND SEDIMENT CONTROL NOTES: ALL EROSION AND SEDIMENT CONTROL MEASURES ARE TO BE IN STRICT COMPLIANCE

- WITH "NEW YORK STATE STANDARDS AND SPECIFICATIONS FOR EROSION AND SEDIMENT CONTROL", NOVEMBER 2016.
- 2. EXCESS SOIL TO BE STOCKPILED WITHIN THE LIMITS OF SITE DISTURBANCE IF NOT USED IMMEDIATELY FOR GRADING PURPOSES. INSTALL SILT FENCE AROUND SOIL
- 3. APPLY SURFACE STABILIZATION AND RESTORATION MEASURES. AREAS UNDERGOING CLEARING OR GRADING AND ANY AREAS DISTURBED BY CONSTRUCTION ACTIVITIES WHERE WORK IS DELAYED, SUSPENDED, OR INCOMPLETE AND WILL NOT BE REDISTURBED FOR 21 DAYS OR MORE SHALL BE STABILIZED WITH TEMPORARY VEGETATIVE COVER WITHIN 14 DAYS AFTER CONSTRUCTION ACTIVITY IN THAT PORTION OF THE SITE HAS CEASED. (SEE SPECIFICATIONS FOR TEMPORARY VEGETATIVE COVER). AREAS UNDERGOING CLEARING OR GRADING AND ANY AREAS DISTURBED BY CONSTRUCTION ACTIVITIES WHERE WORK IS COMPLETE AND WILL NOT BE REDISTURBED SHALL BE STABILIZED AND RESTORED WITH PERMANENT VEGETATIVE COVER AS SOON AS SITE AREAS ARE AVAILABLE AND WITHIN 14 DAYS AFTER WORK IS COMPLETE. (SEE SPECIFICATIONS FOR PERMANENT VEGETATIVE COVER). SEEDING FOR PERMANENT VEGETATIVE COVER SHALL BE WITHIN THE SEASONAL LIMITATIONS. PROVIDE STABILIZATION WITH TEMPORARY VEGETATIVE
- COVER WITHIN 14 DAYS AFTER WORK IS COMPLETE, FOR SEEDING OUTSIDE PERMITTED SEEDING PERIODS. 4. SEEDED AREAS TO BE MULCHED WITH STRAW OR HAY MULCH IN ACCORDANCE WITH VEGETATIVE COVER SPECIFICATIONS.
- 5. THE CONTRACTOR IS RESPONSIBLE FOR THE INSTALLATION AND MAINTENANCE OF ALL EROSION AND SEDIMENT CONTROL MEASURES THROUGHOUT THE COURSE OF CONSTRUCTION
- 6. THE CONTRACTOR IS RESPONSIBLE FOR CONTROLLING DUST BY SPRINKLING EXPOSED SOIL AREAS PERIODICALLY WITH WATER AS REQUIRED. THE CONTRACTOR IS TO SUPPLY ALL EQUIPMENT AND WATER.
- WHEN ALL DISTURBED AREAS ARE STABLE, ALL TEMPORARY EROSION AND SEDIMENT CONTROL MEASURES SHALL BE REMOVED.

LOOMBACTION TESTING EDECUENCY

LOCATION	COMPACTION	TESTING FREQUENCY
PIPE TRENCH BACKFILL (IN PAVED AREAS)	95% ASTM D1557	1 SERIES OF TESTS FOR EACH 150 FT OR LESS OF TRENCH LENGTH. SERIES INCLUDE 3 COMPACTION TESTS SPREAD EVENLY ALONG TRENCH PROFILE.
PIPE TRENCH BACKFILL (IN UNPAVED AREAS)	90% ASTM D1557	1 SERIES OF TESTS FOR EACH 150 LF OR LESS OF TRENCH LENGTH. SERIES INCLUDE 3 COMPACTION TESTS SPREAD EVENLY ALONG TRENCH PROFILE.
PIPE BEDDING AND PIPE ZONE BACKFILL	95% ASTM D1557	1 TEST FOR EACH 150 FT OR LESS OF TRENCH LENGTH.
PAVEMENT SUBBASE AND LAST LIFT OF SELECT GRANULAR FILL (FILL BETWEEN SHEET PILES)	95% ASTM D1557	1 TEST FOR EVERY 2,000 SQ FT, OF LIFT AREA BUT NO FEWER THAN TWO TESTS PER LIFT

## THE **SEVENTY-SIX**

#### Parcel 76, 76 Second Avenue, City of Albany,

Owner: South End Development LLC

Architect: Garrison-Architects 45 Main Street Brooklyn, NY 11201

Civil Engineer: The Chazen Companies 547 River St, Troy, NY 12180 p (518) 273-0055 Chazen Project No. 32019.00

#### Revision Schedule

Revision Revision Number Description Revision

Date

### PLANNING SUBMISSION SET

Scale: AS NOTED 12/8/2020 Date: Project No: KC/SM Drawn by: Checked by:

### Seal & Signature:



DOB Stamp & Signature

DOB Scan:

Drawing Title:

Notes & Legend


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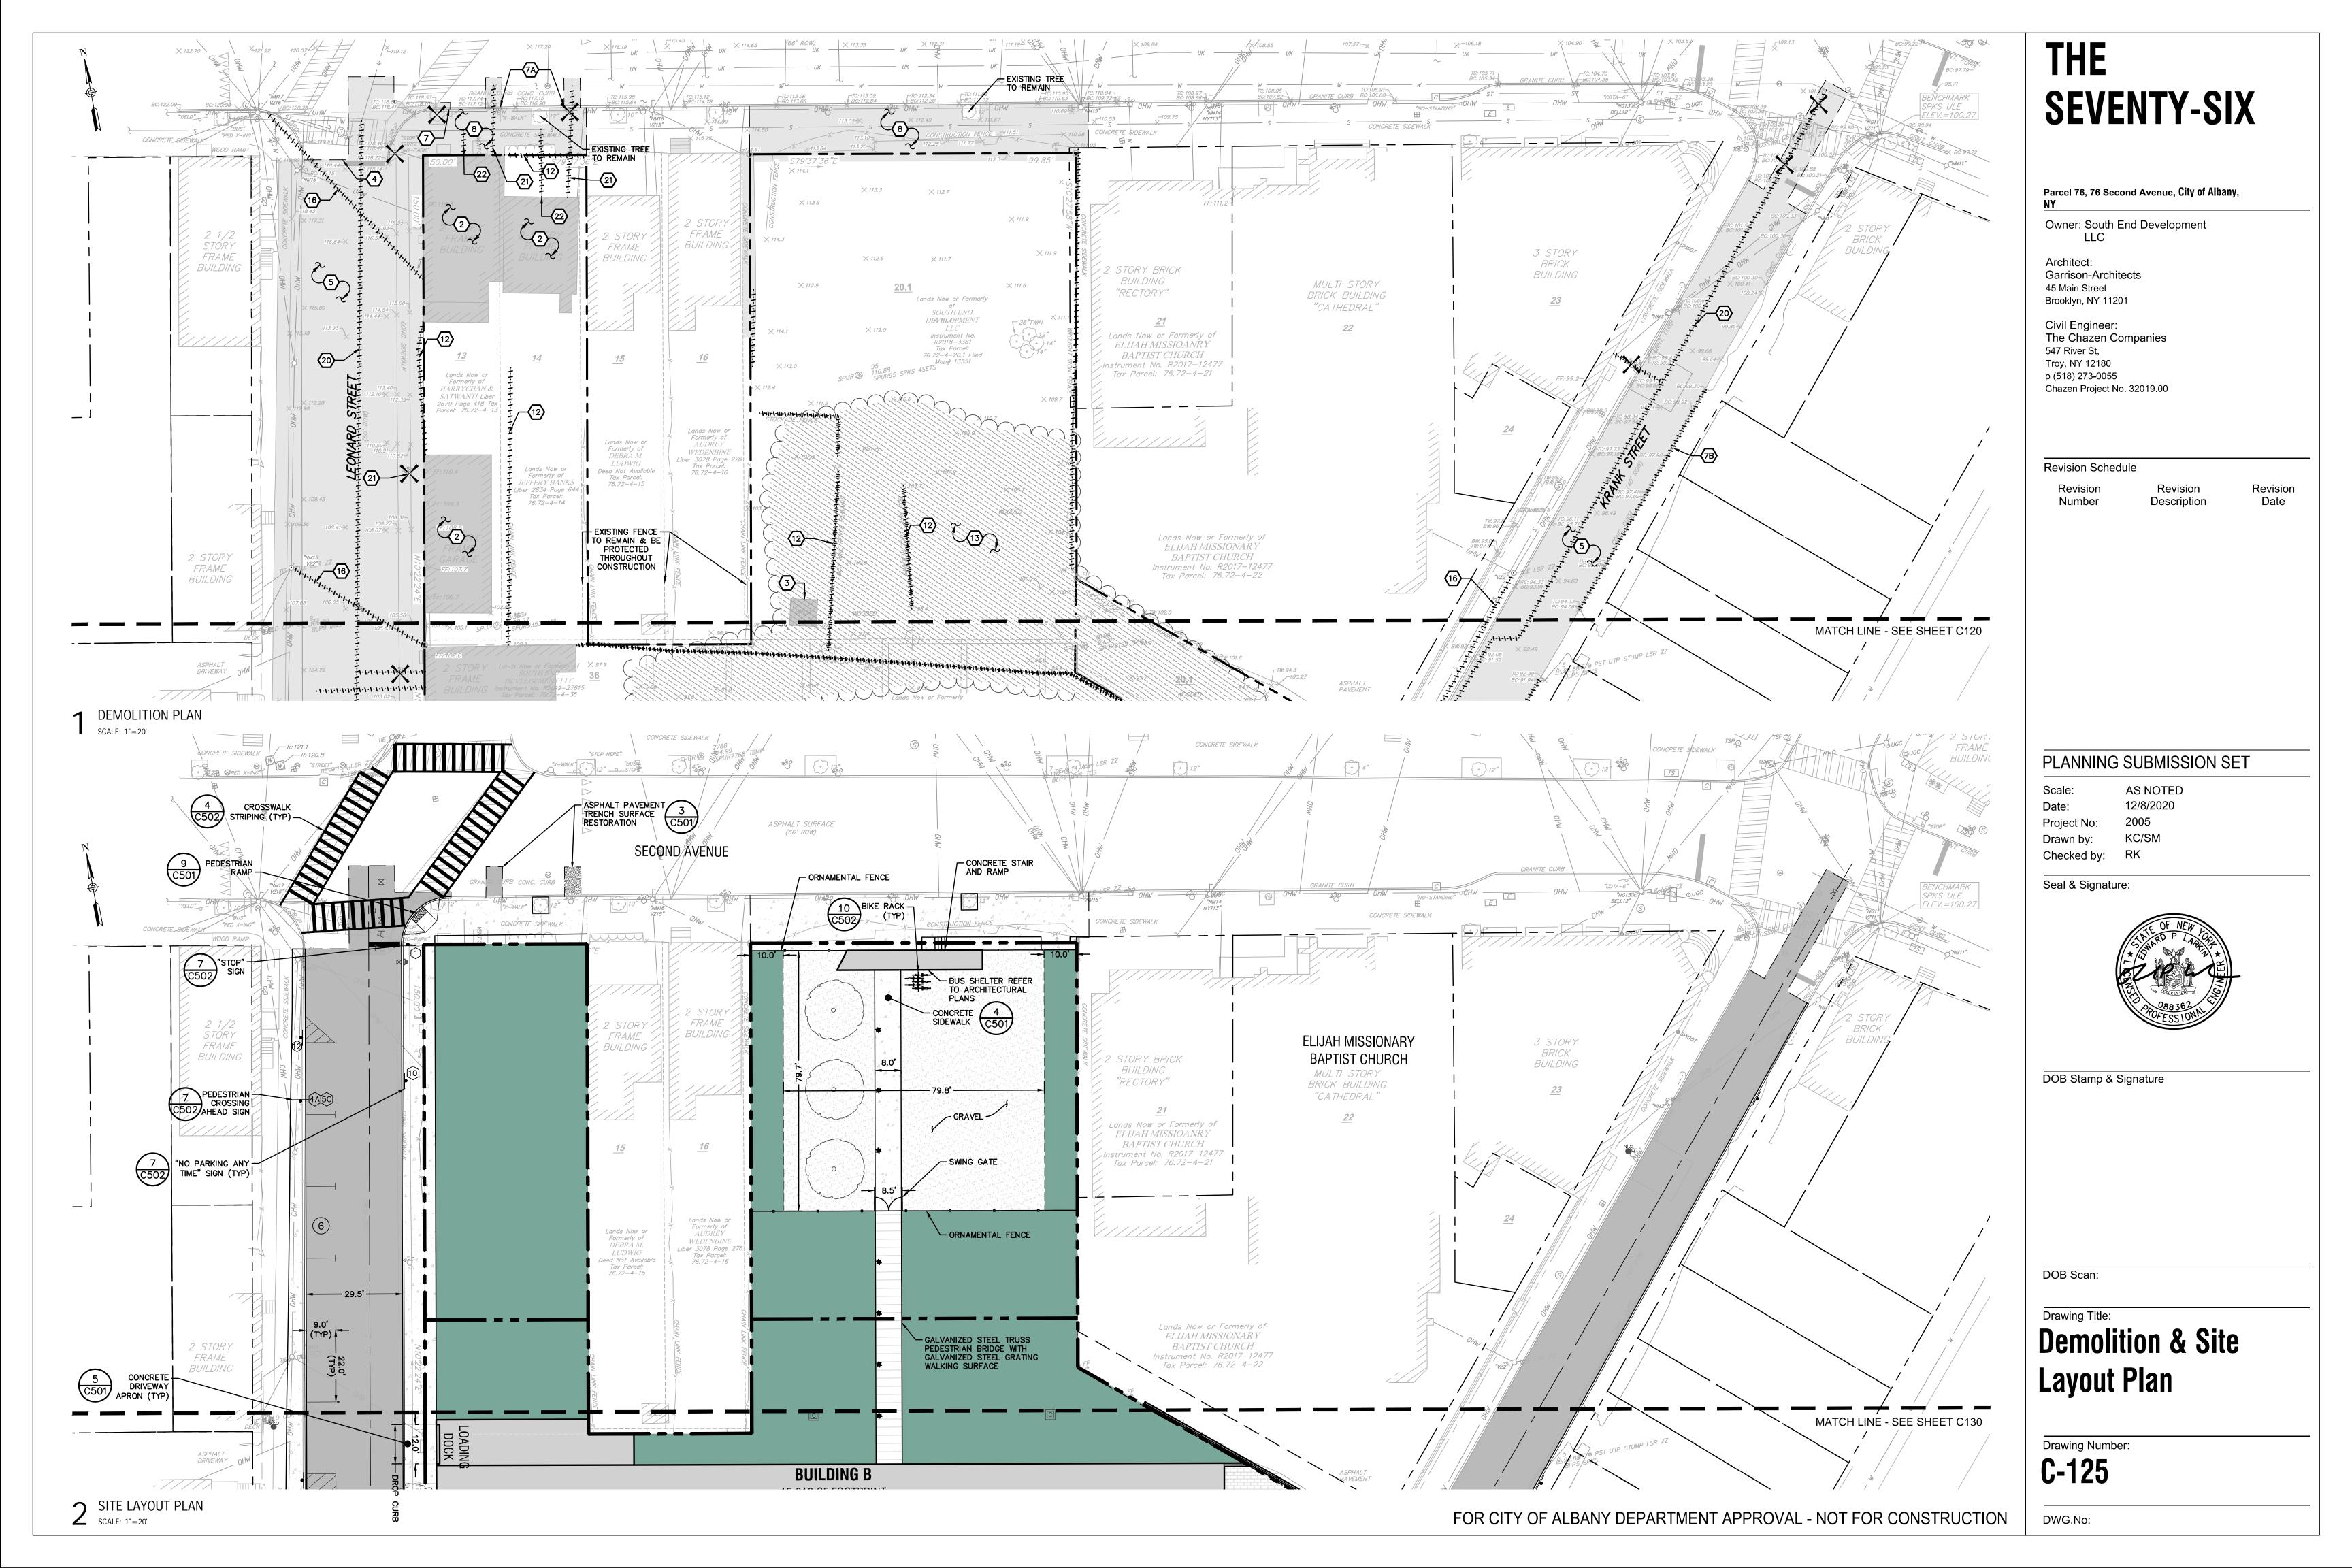
FOR CITY OF ALBANY DEPARTMENT APPROVAL - NOT FOR CONSTRUCTION












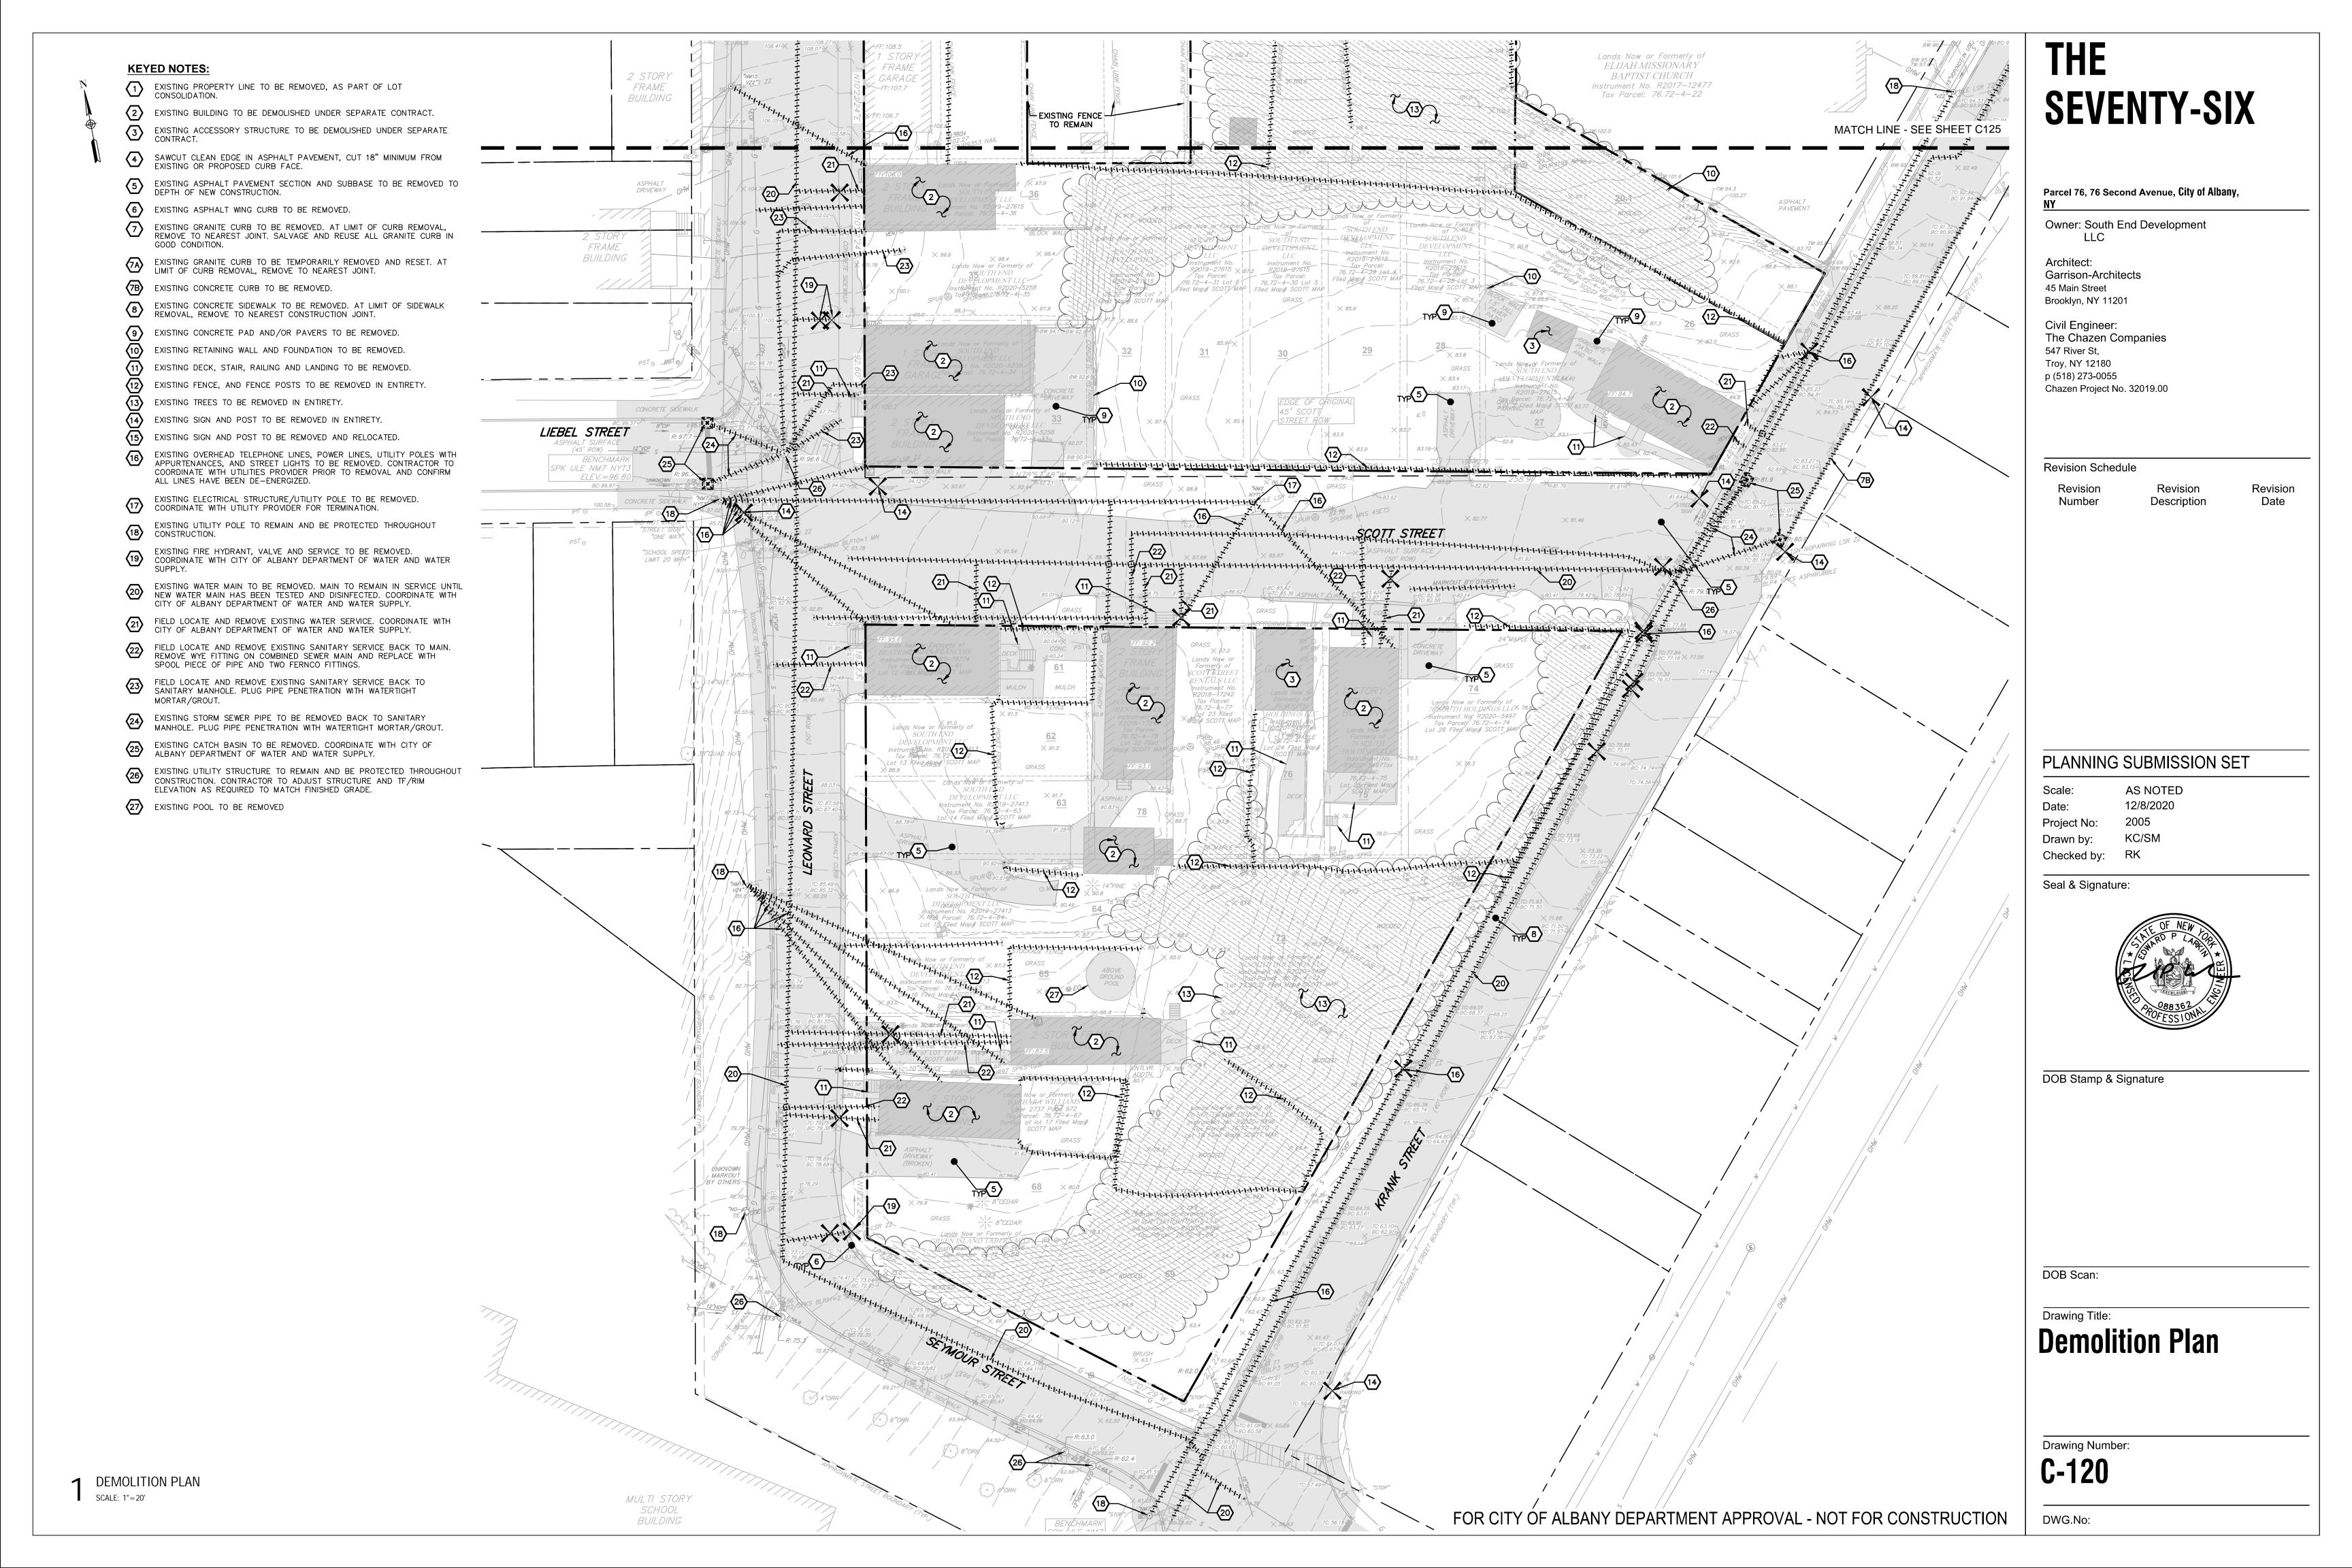

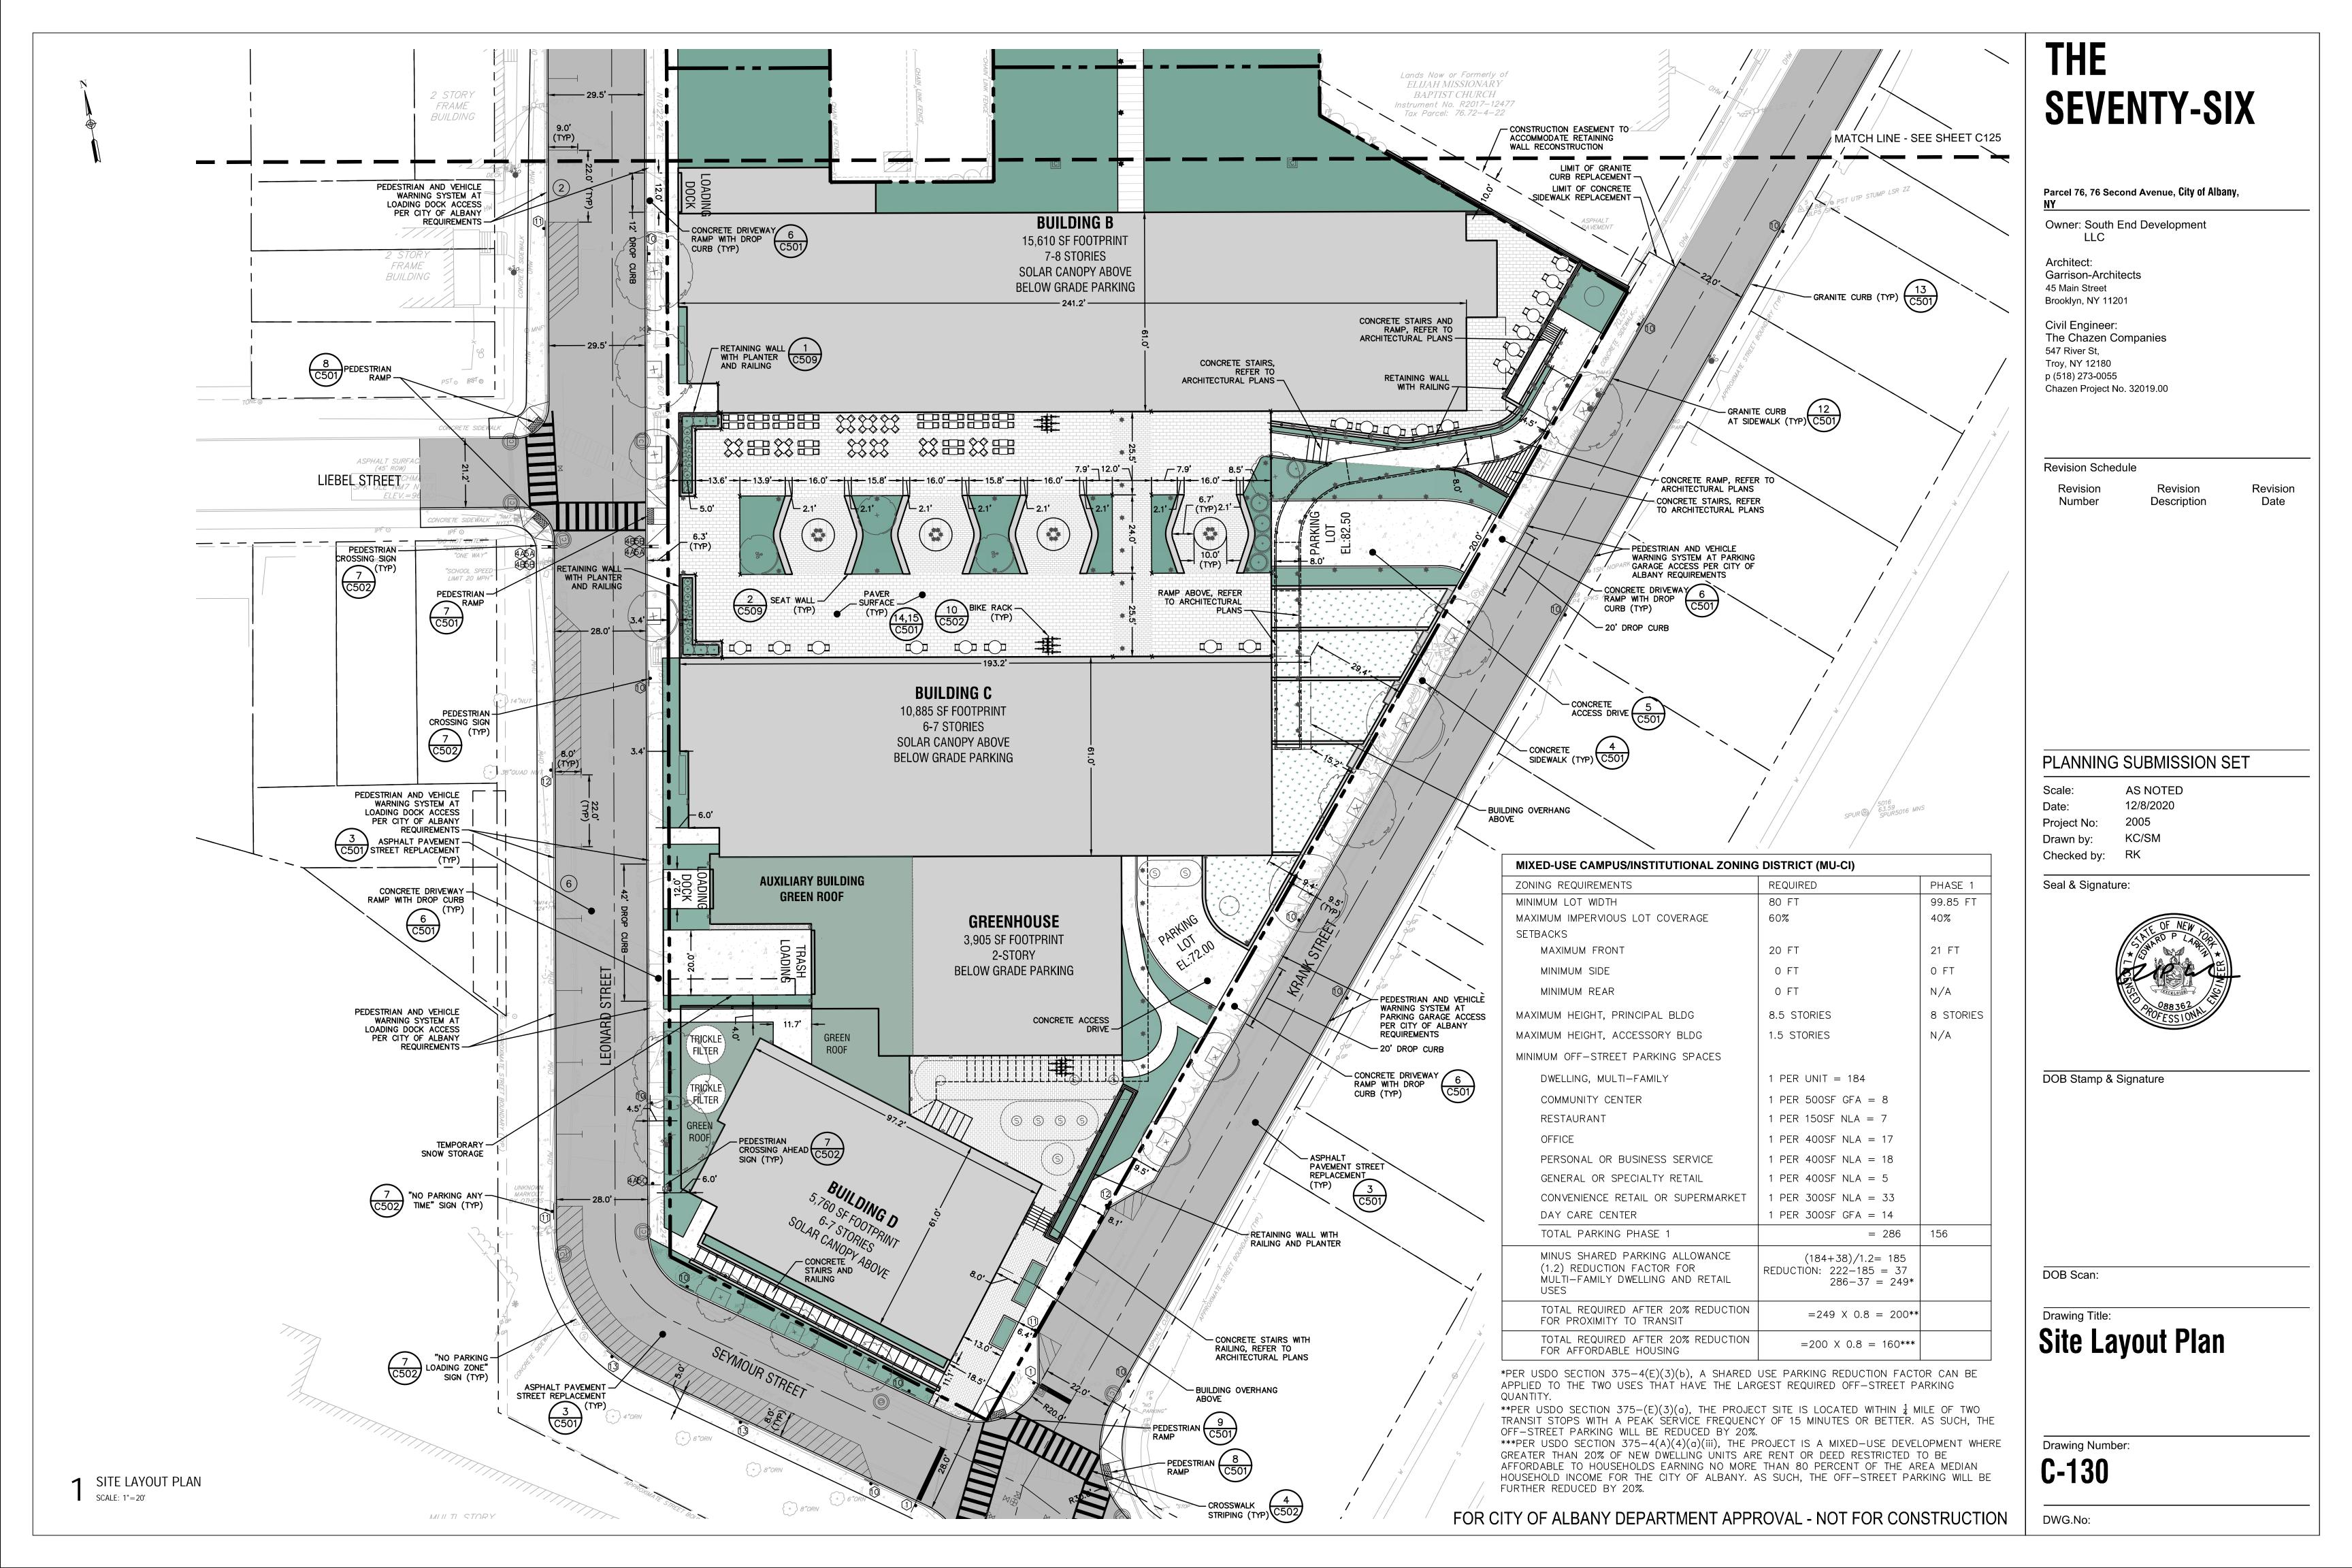


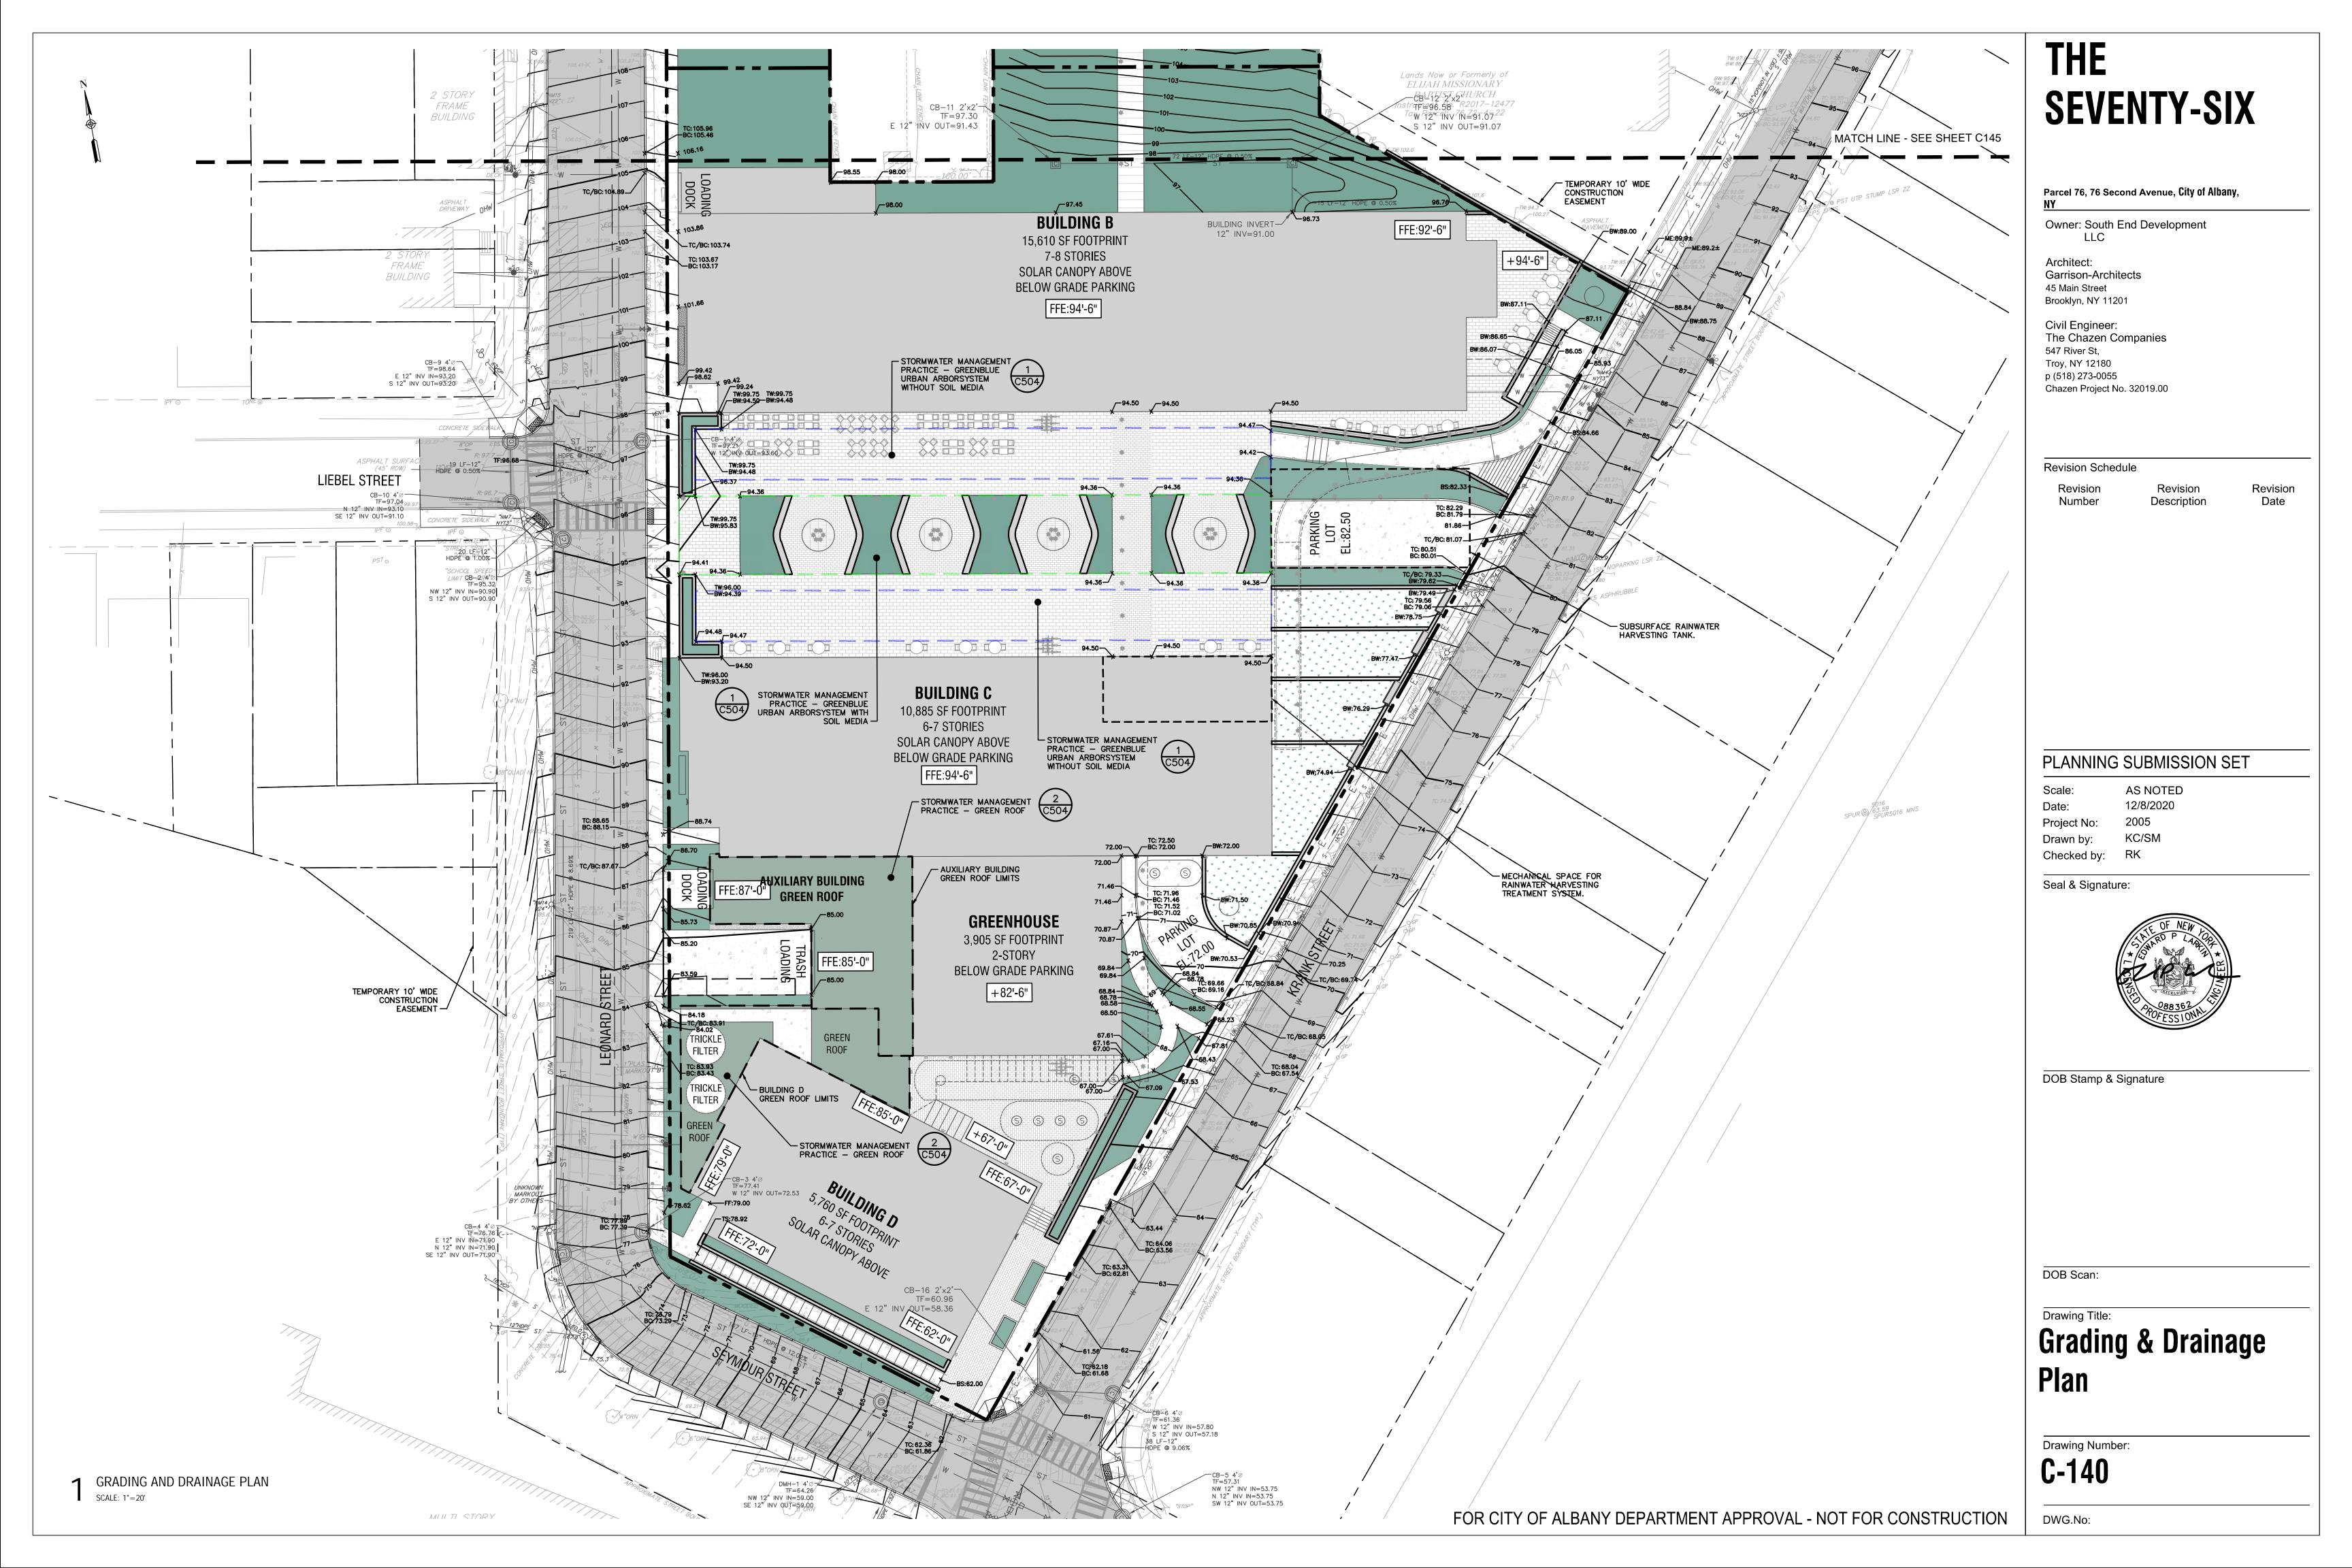

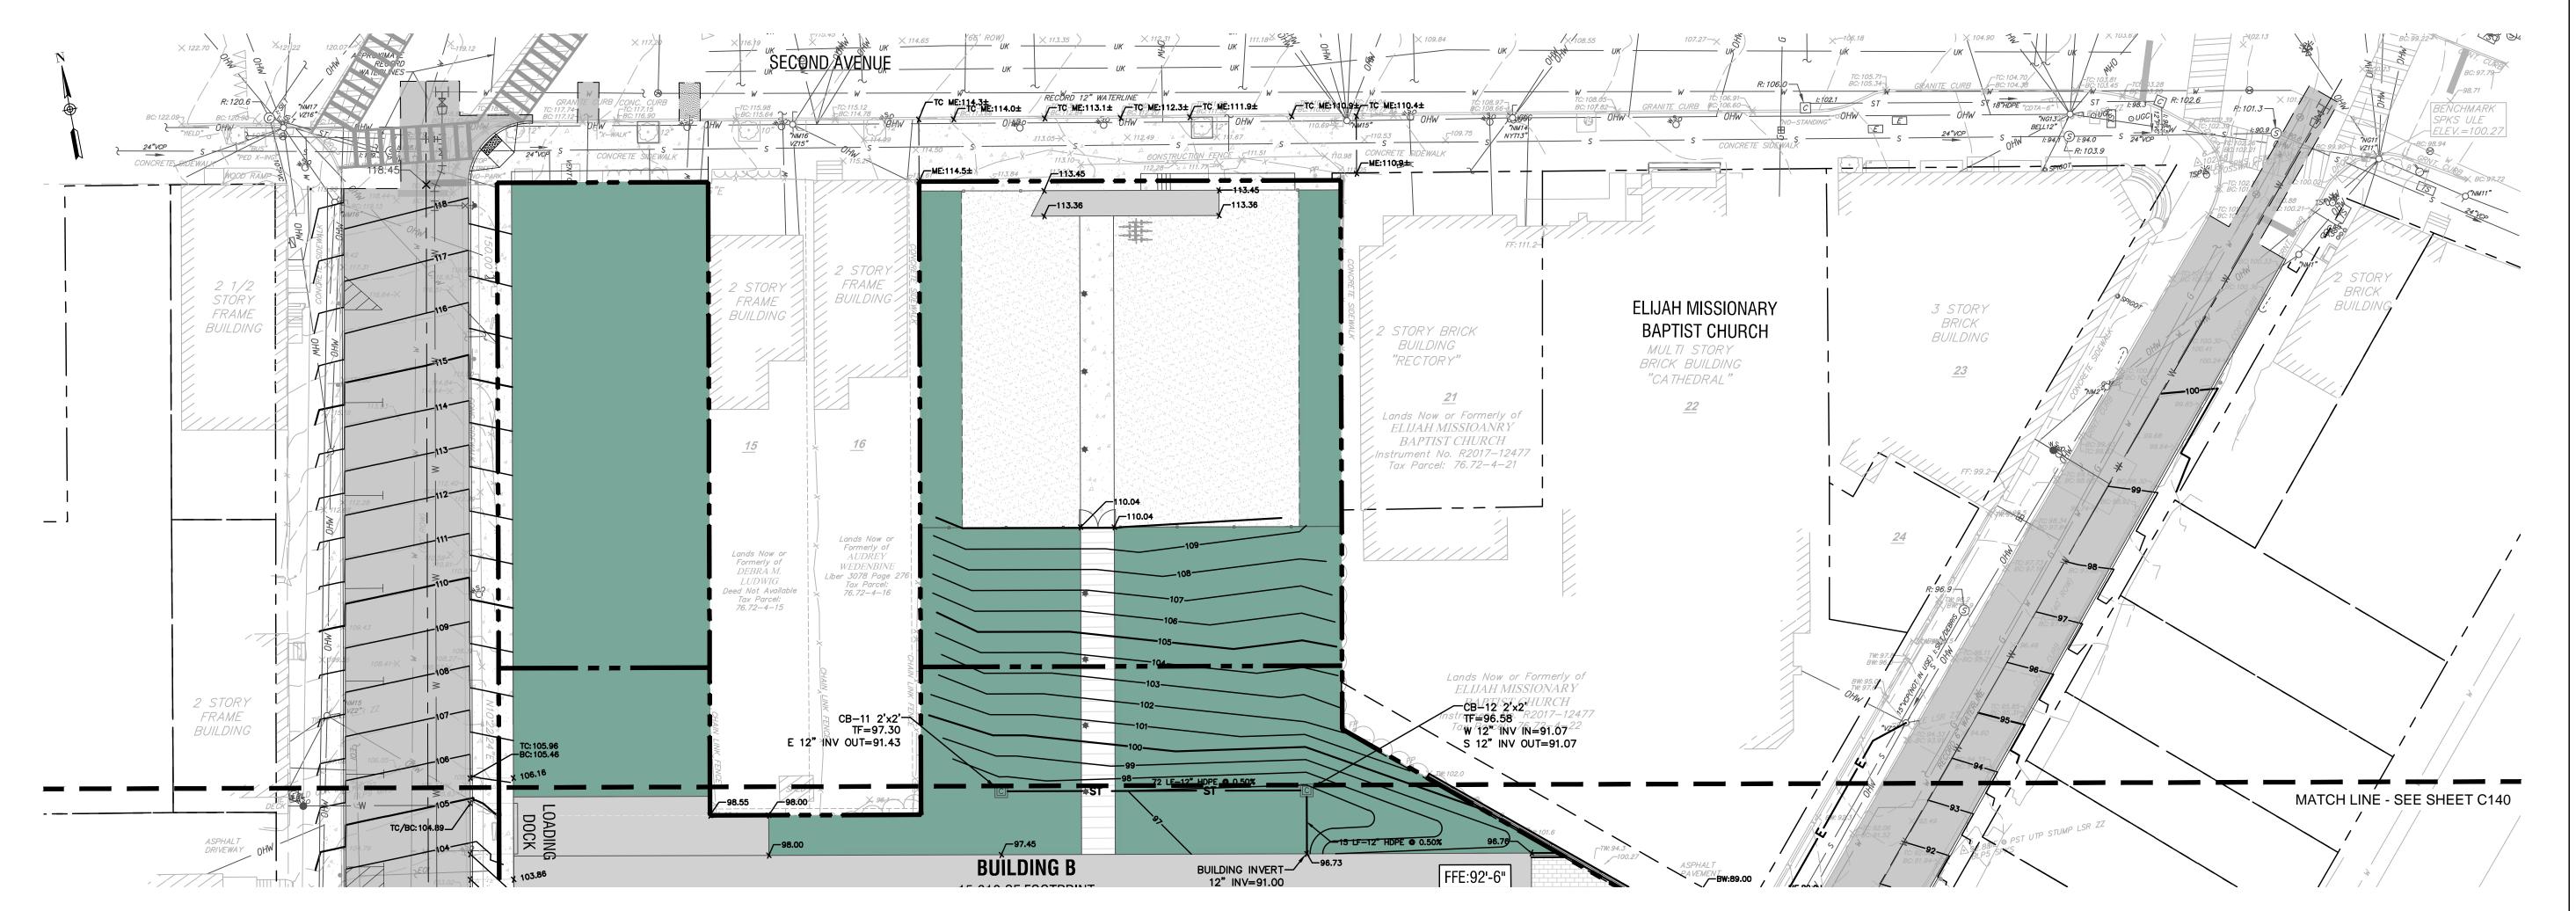

**1** GRADING & DRAINAGE PLAN

SCALE: 1"=20'

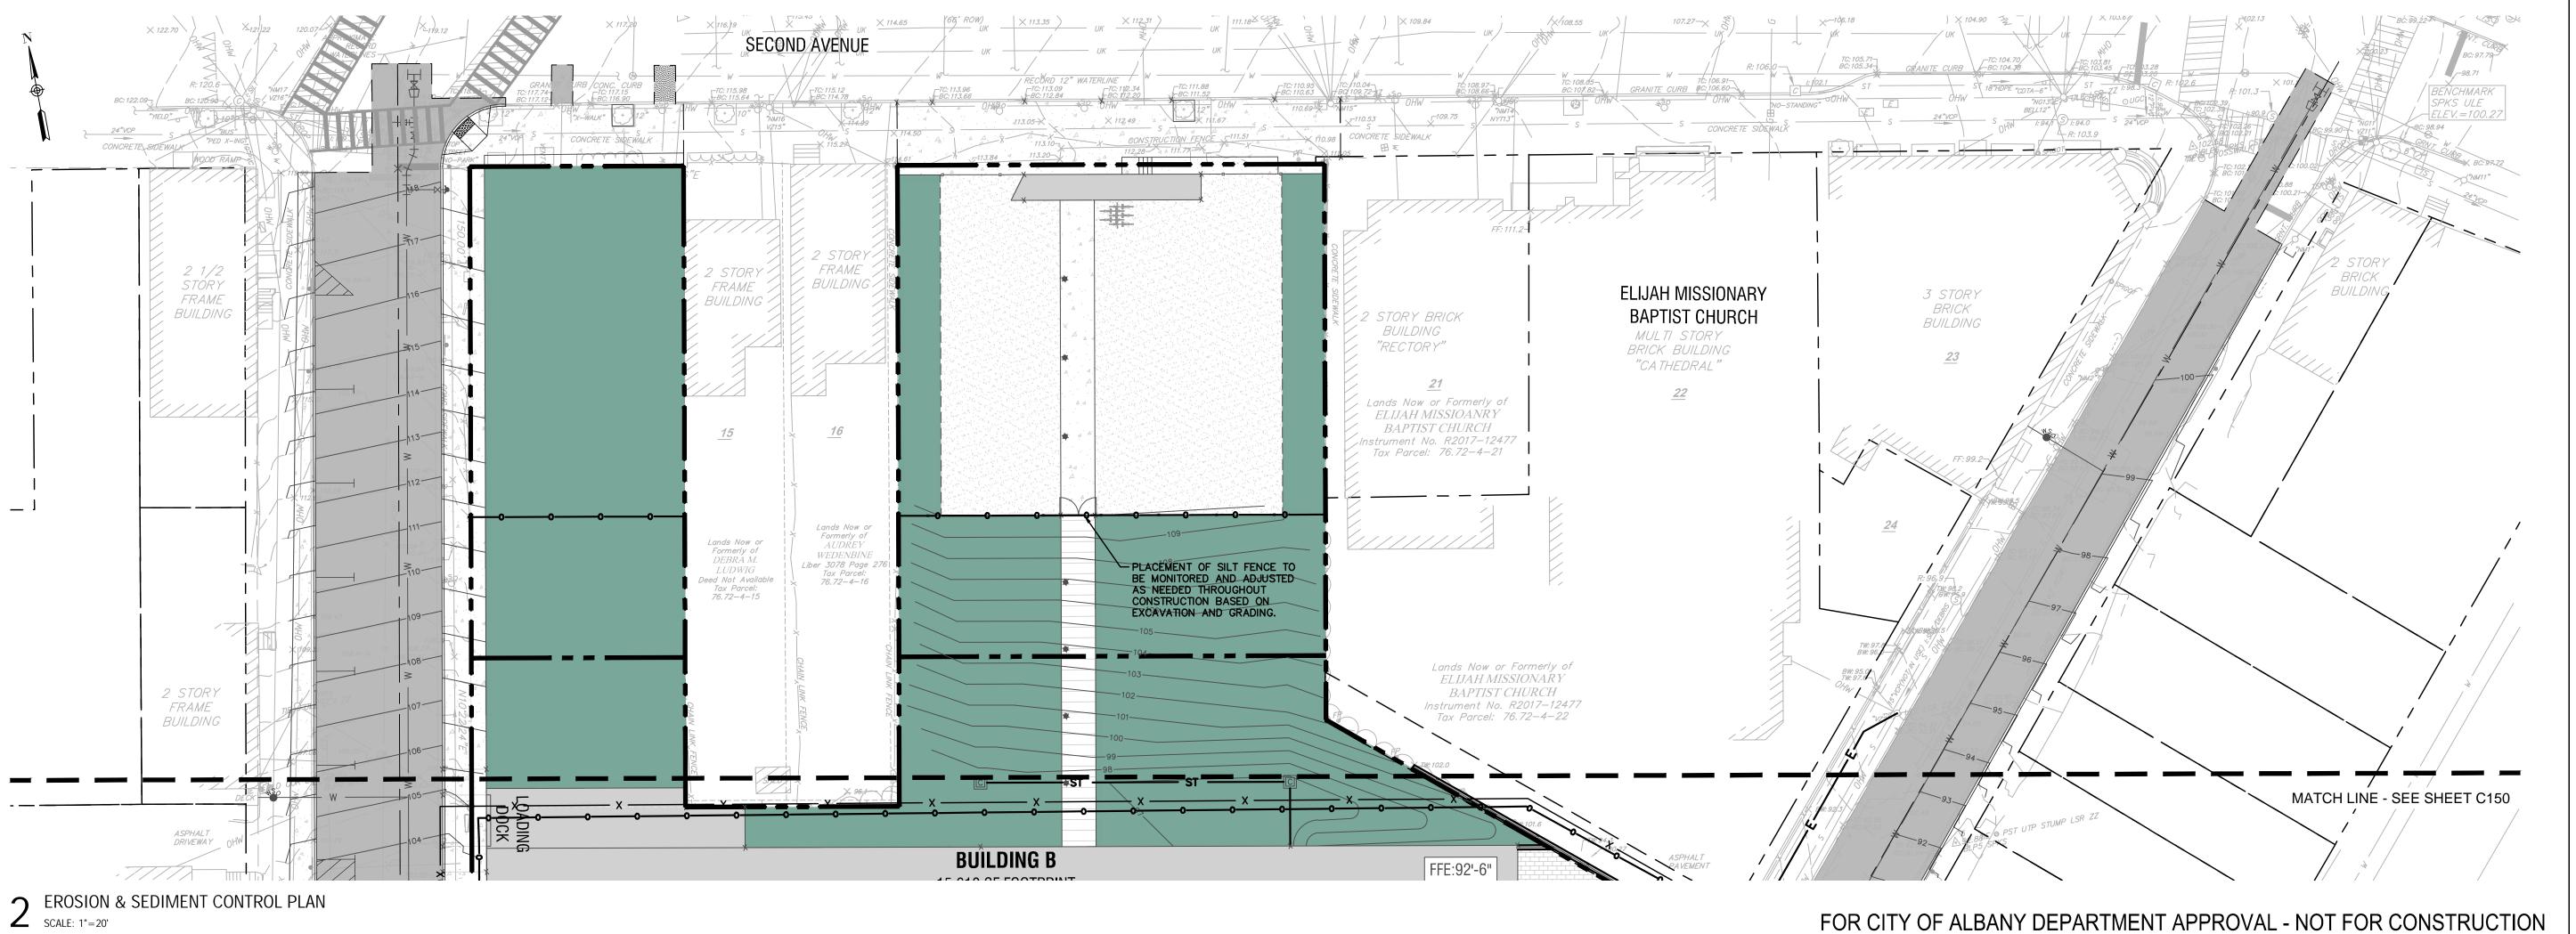

# THE SEVENTY-SIX

Parcel 76, 76 Second Avenue, City of Albany,

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Architect:
Garrison-Architects
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Brooklyn, NY 11201

Civil Engineer: The Chazen Companies 547 River St, Troy, NY 12180 p (518) 273-0055 Chazen Project No. 32019.00

Revision Schedule

Revision Number

Revision
Description

Revision

PLANNING SUBMISSION SET

Scale: AS NOTED
Date: 12/8/2020
Project No: 2005
Drawn by: KC/SM

Checked by: R

Seal & Signature:



DOB Stamp & Signature


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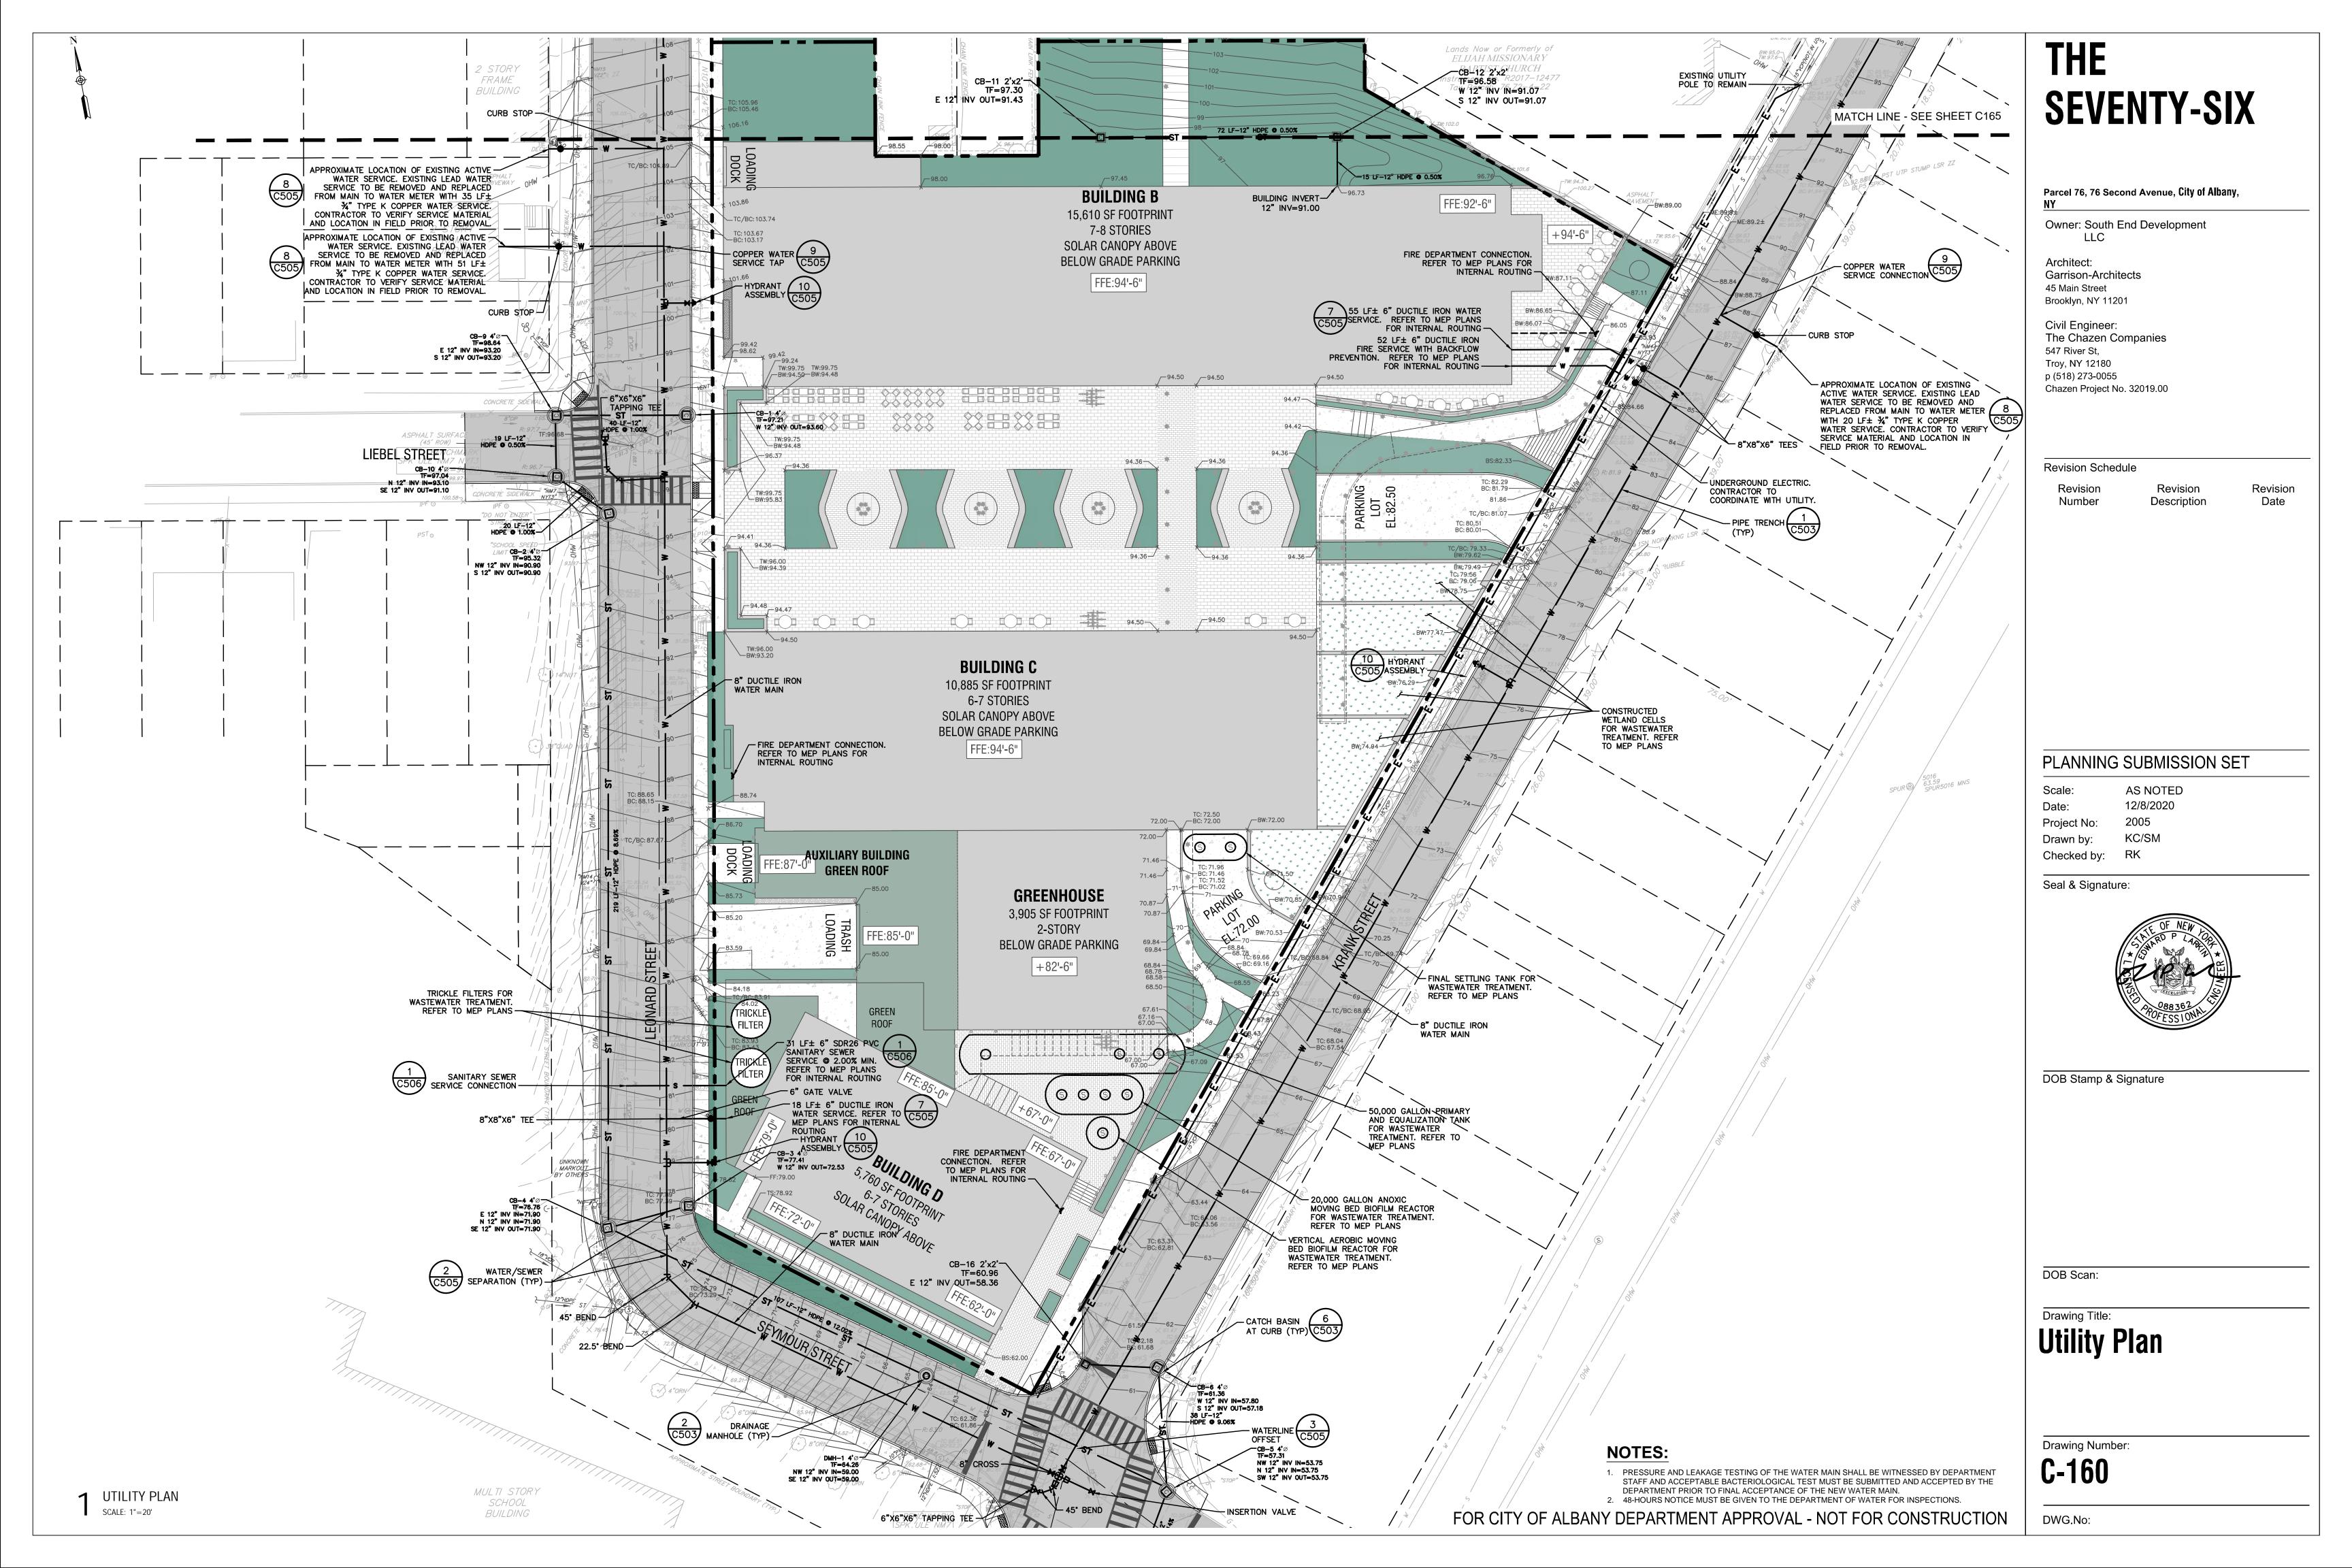
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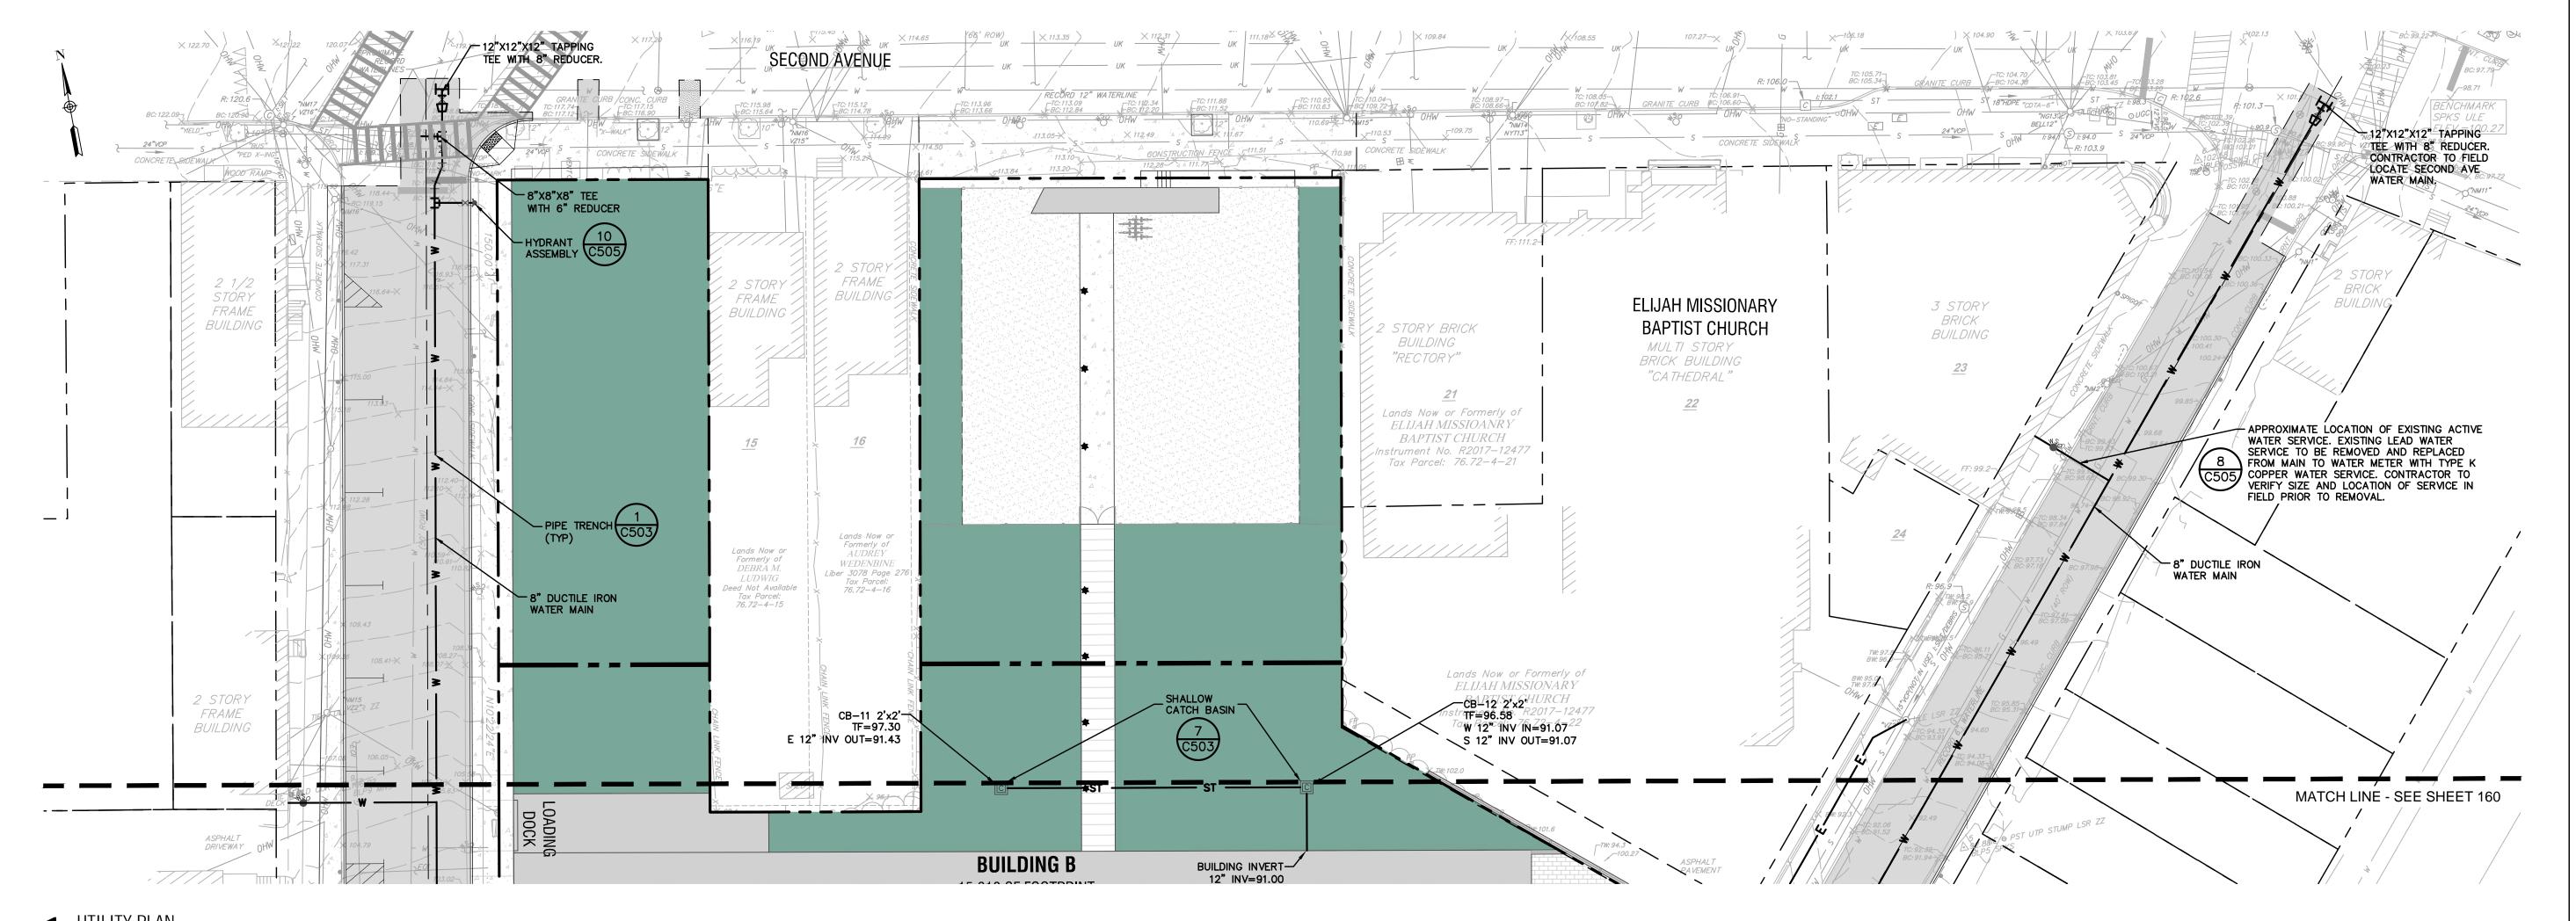
Grading, Drainage, Erosion & Sediment Control Plan

Drawing Number:


C-145





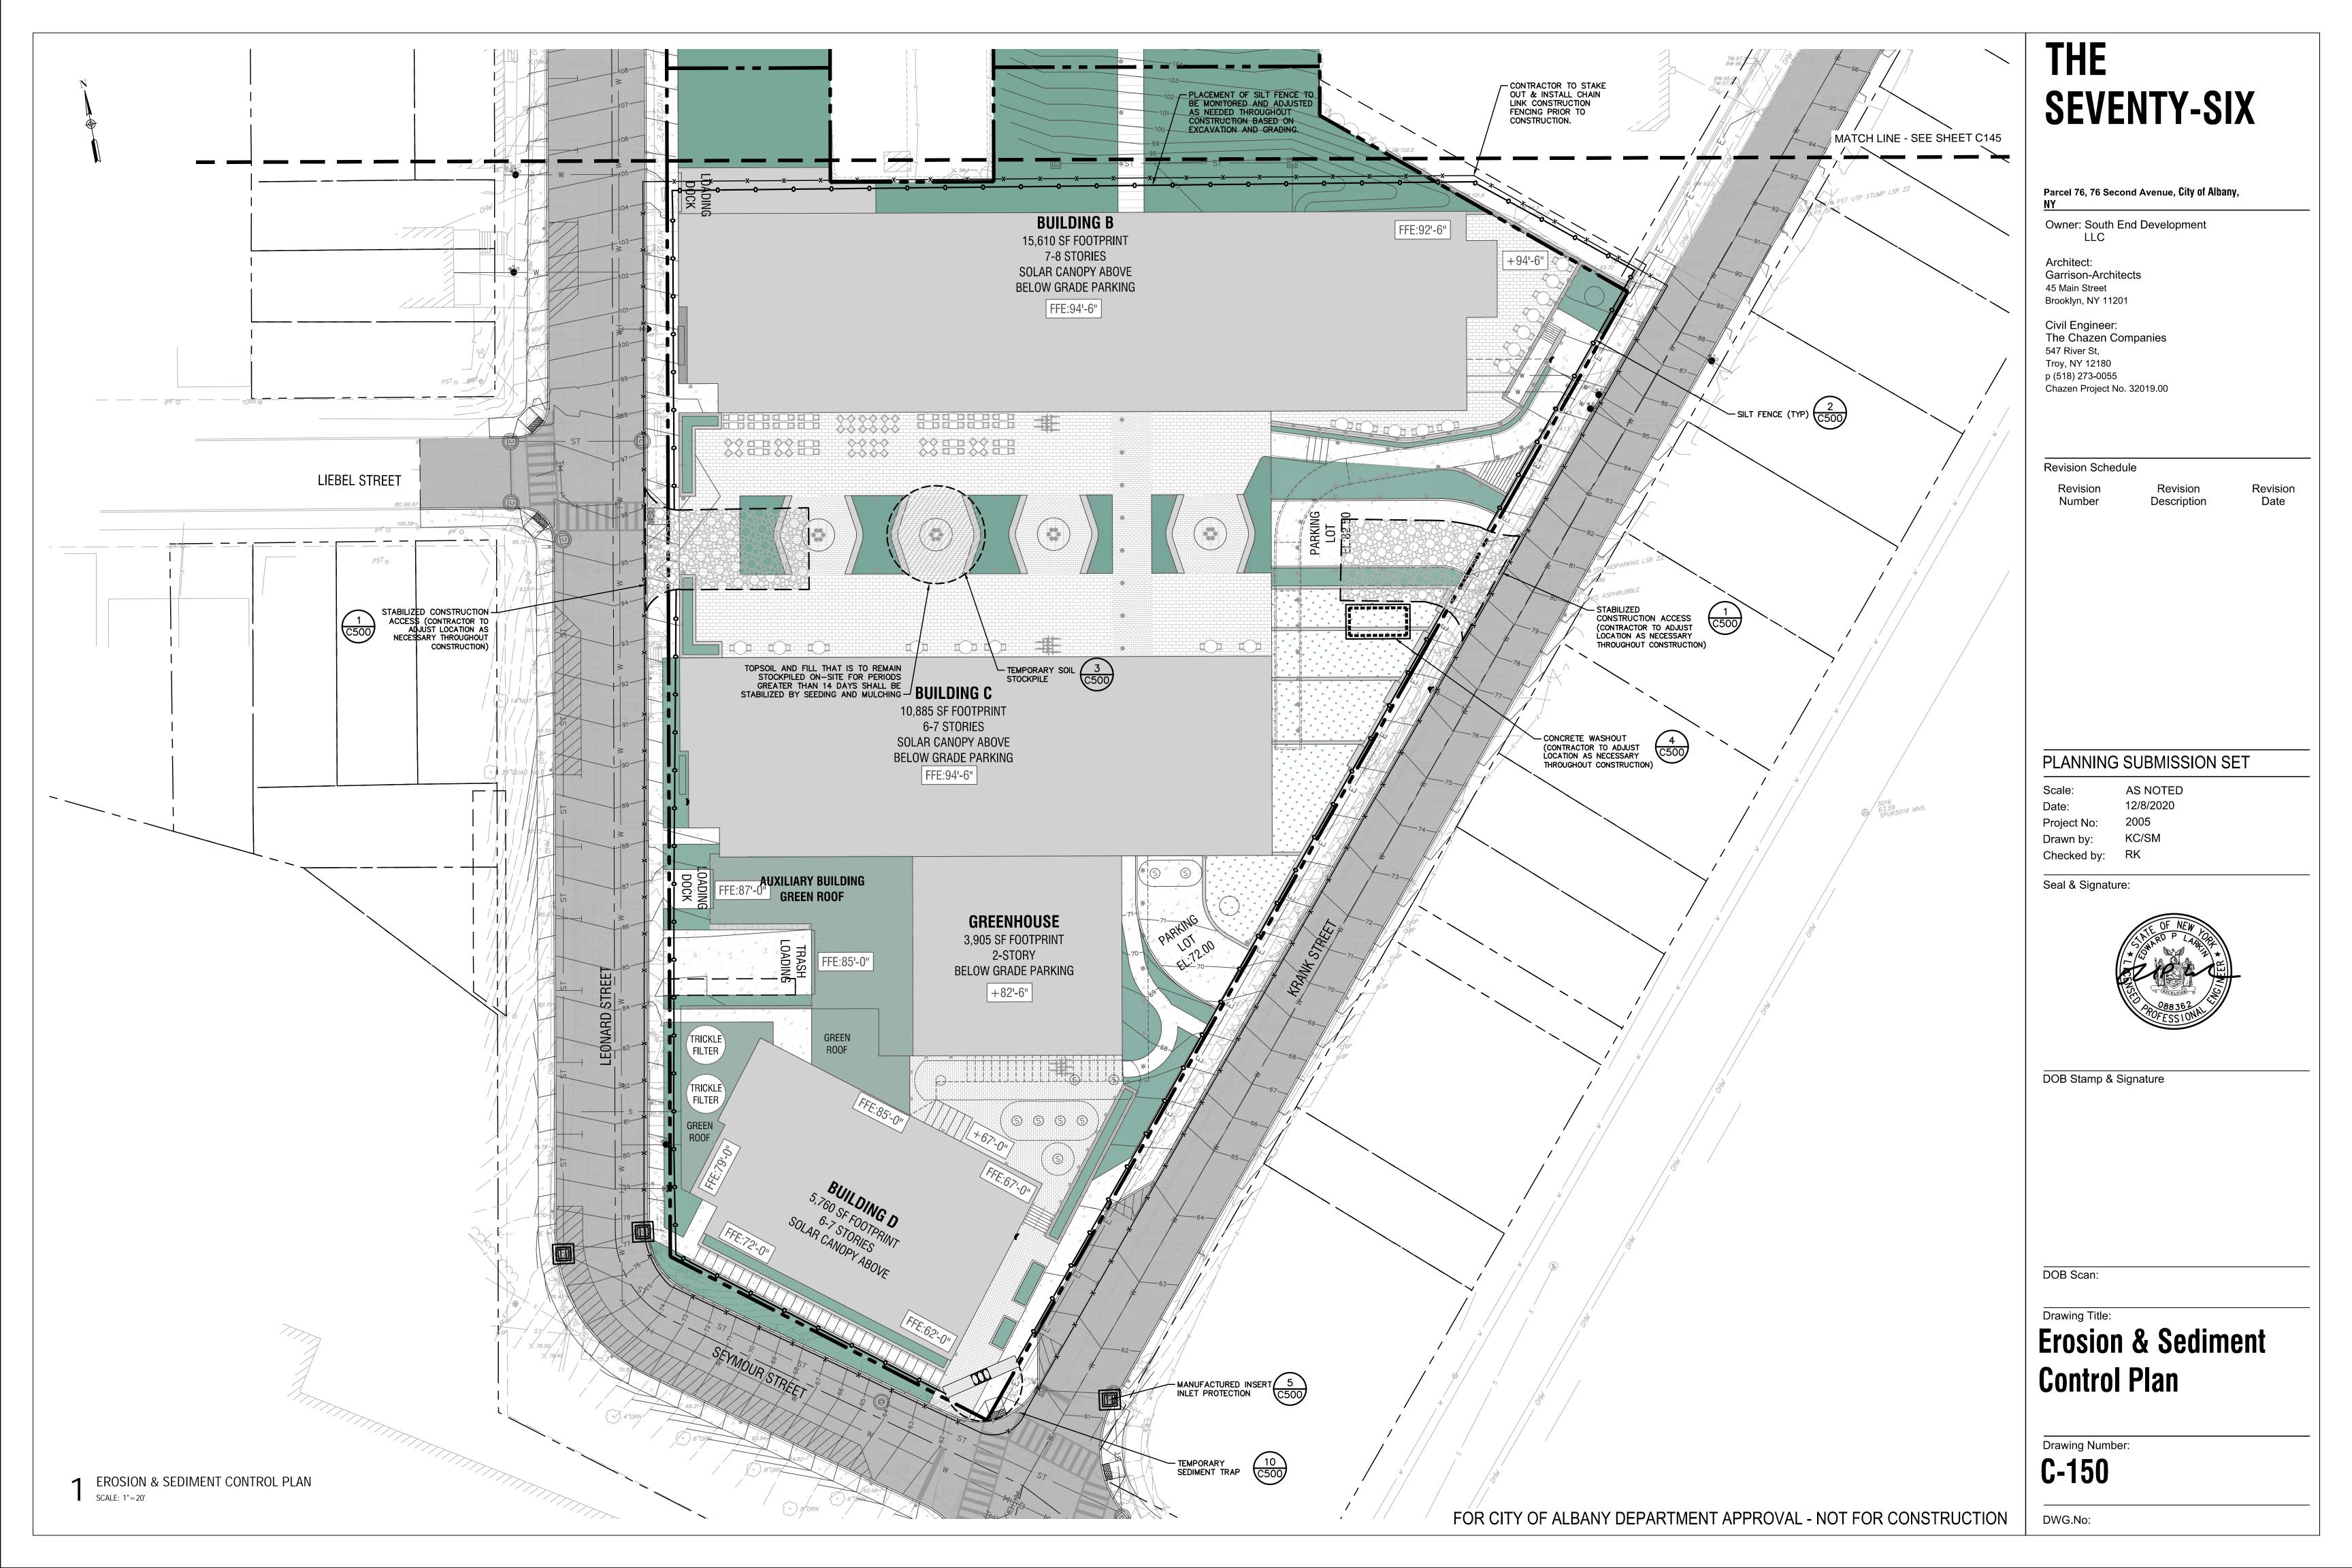

UTILITY PLAN SCALE: 1"=20'

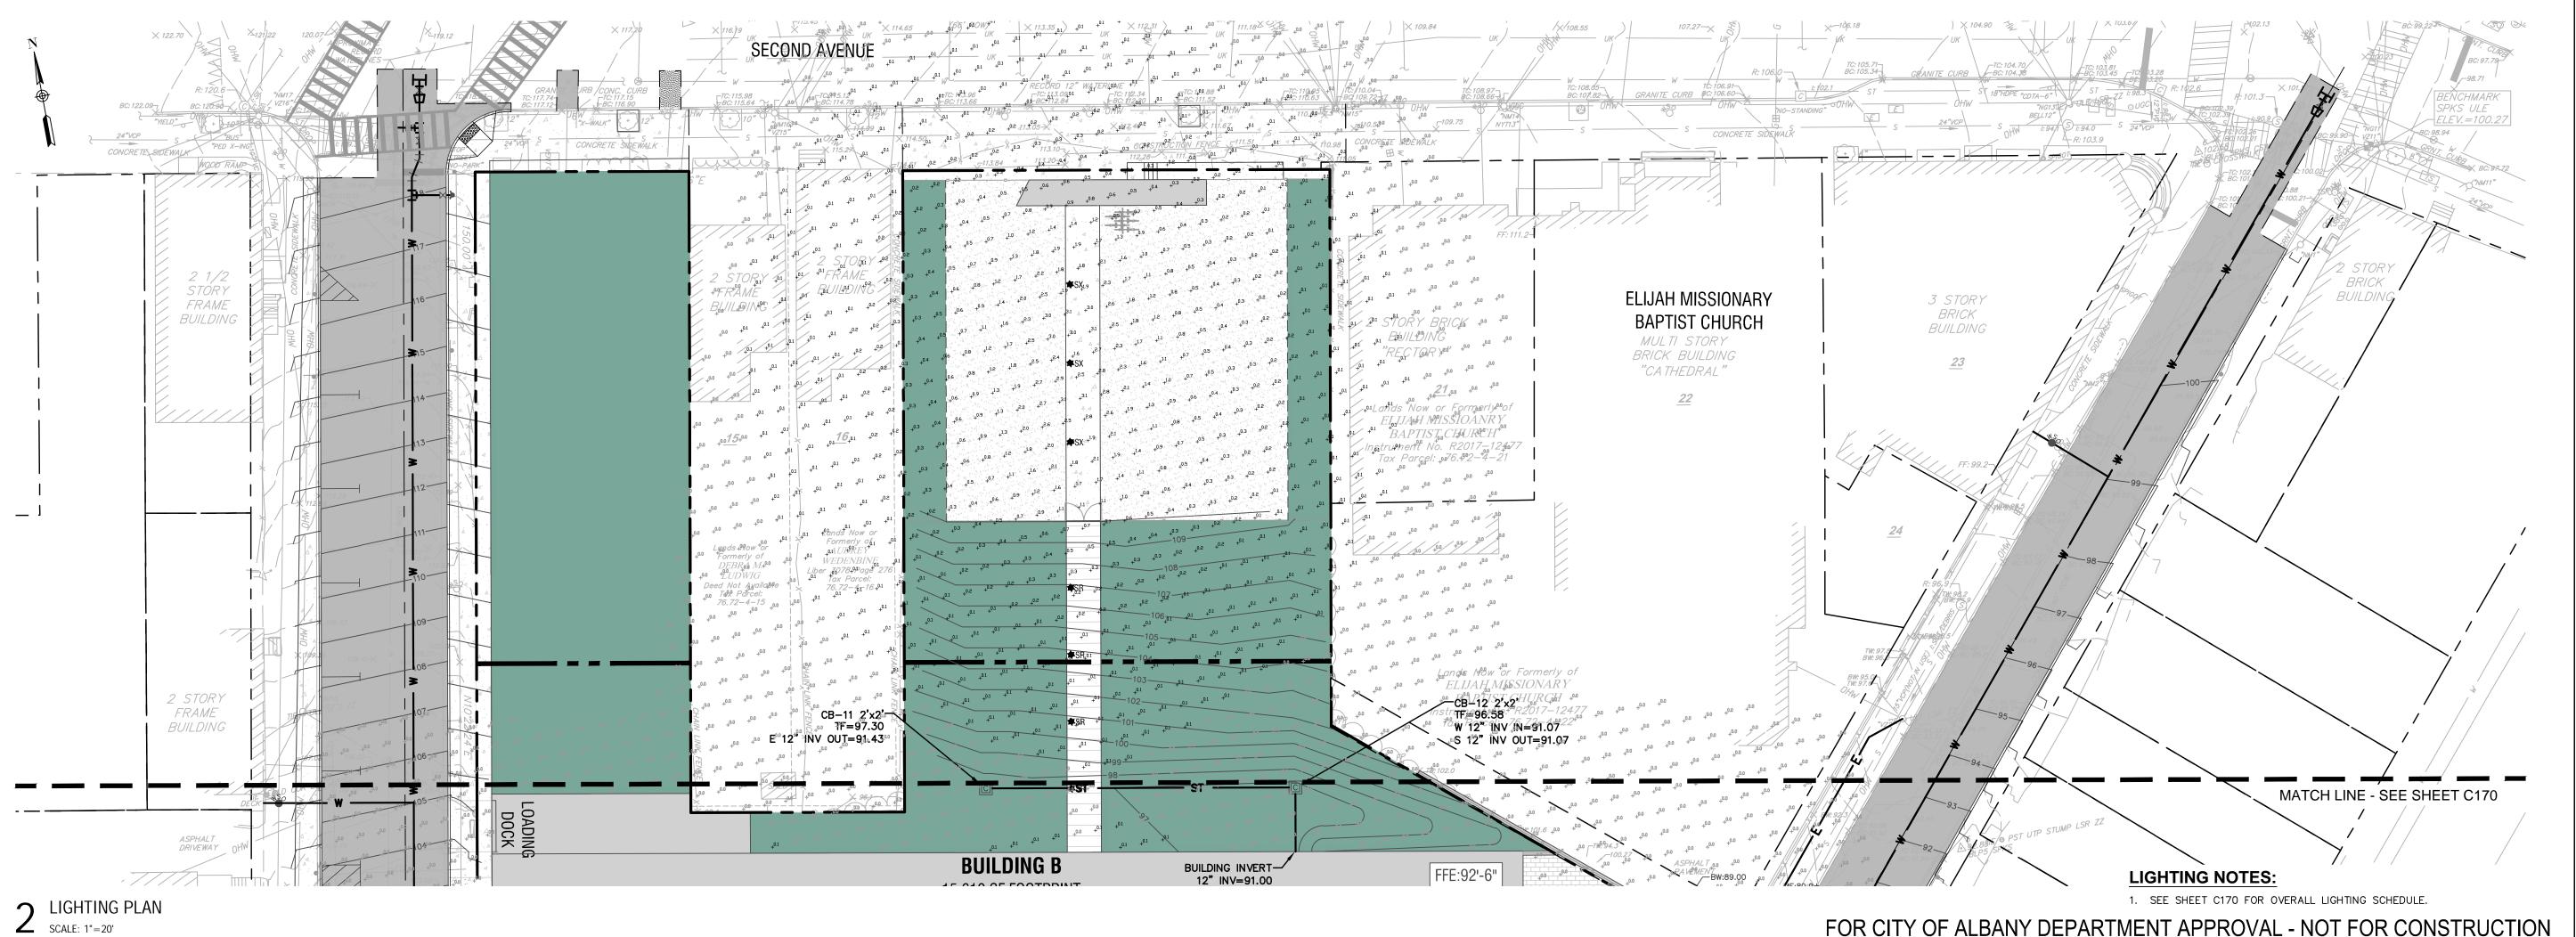

## THE SEVENTY-SIX

Parcel 76, 76 Second Avenue, City of Albany,

Owner: South End Development LLC

Architect: Garrison-Architects 45 Main Street Brooklyn, NY 11201

Civil Engineer: The Chazen Companies 547 River St, Troy, NY 12180 p (518) 273-0055 Chazen Project No. 32019.00

**Revision Schedule** 

Revision Number

Revision Description Revision

Date

PLANNING SUBMISSION SET

AS NOTED Scale: 12/8/2020 Date: Drawn by: Checked by:

Seal & Signature:



DOB Stamp & Signature


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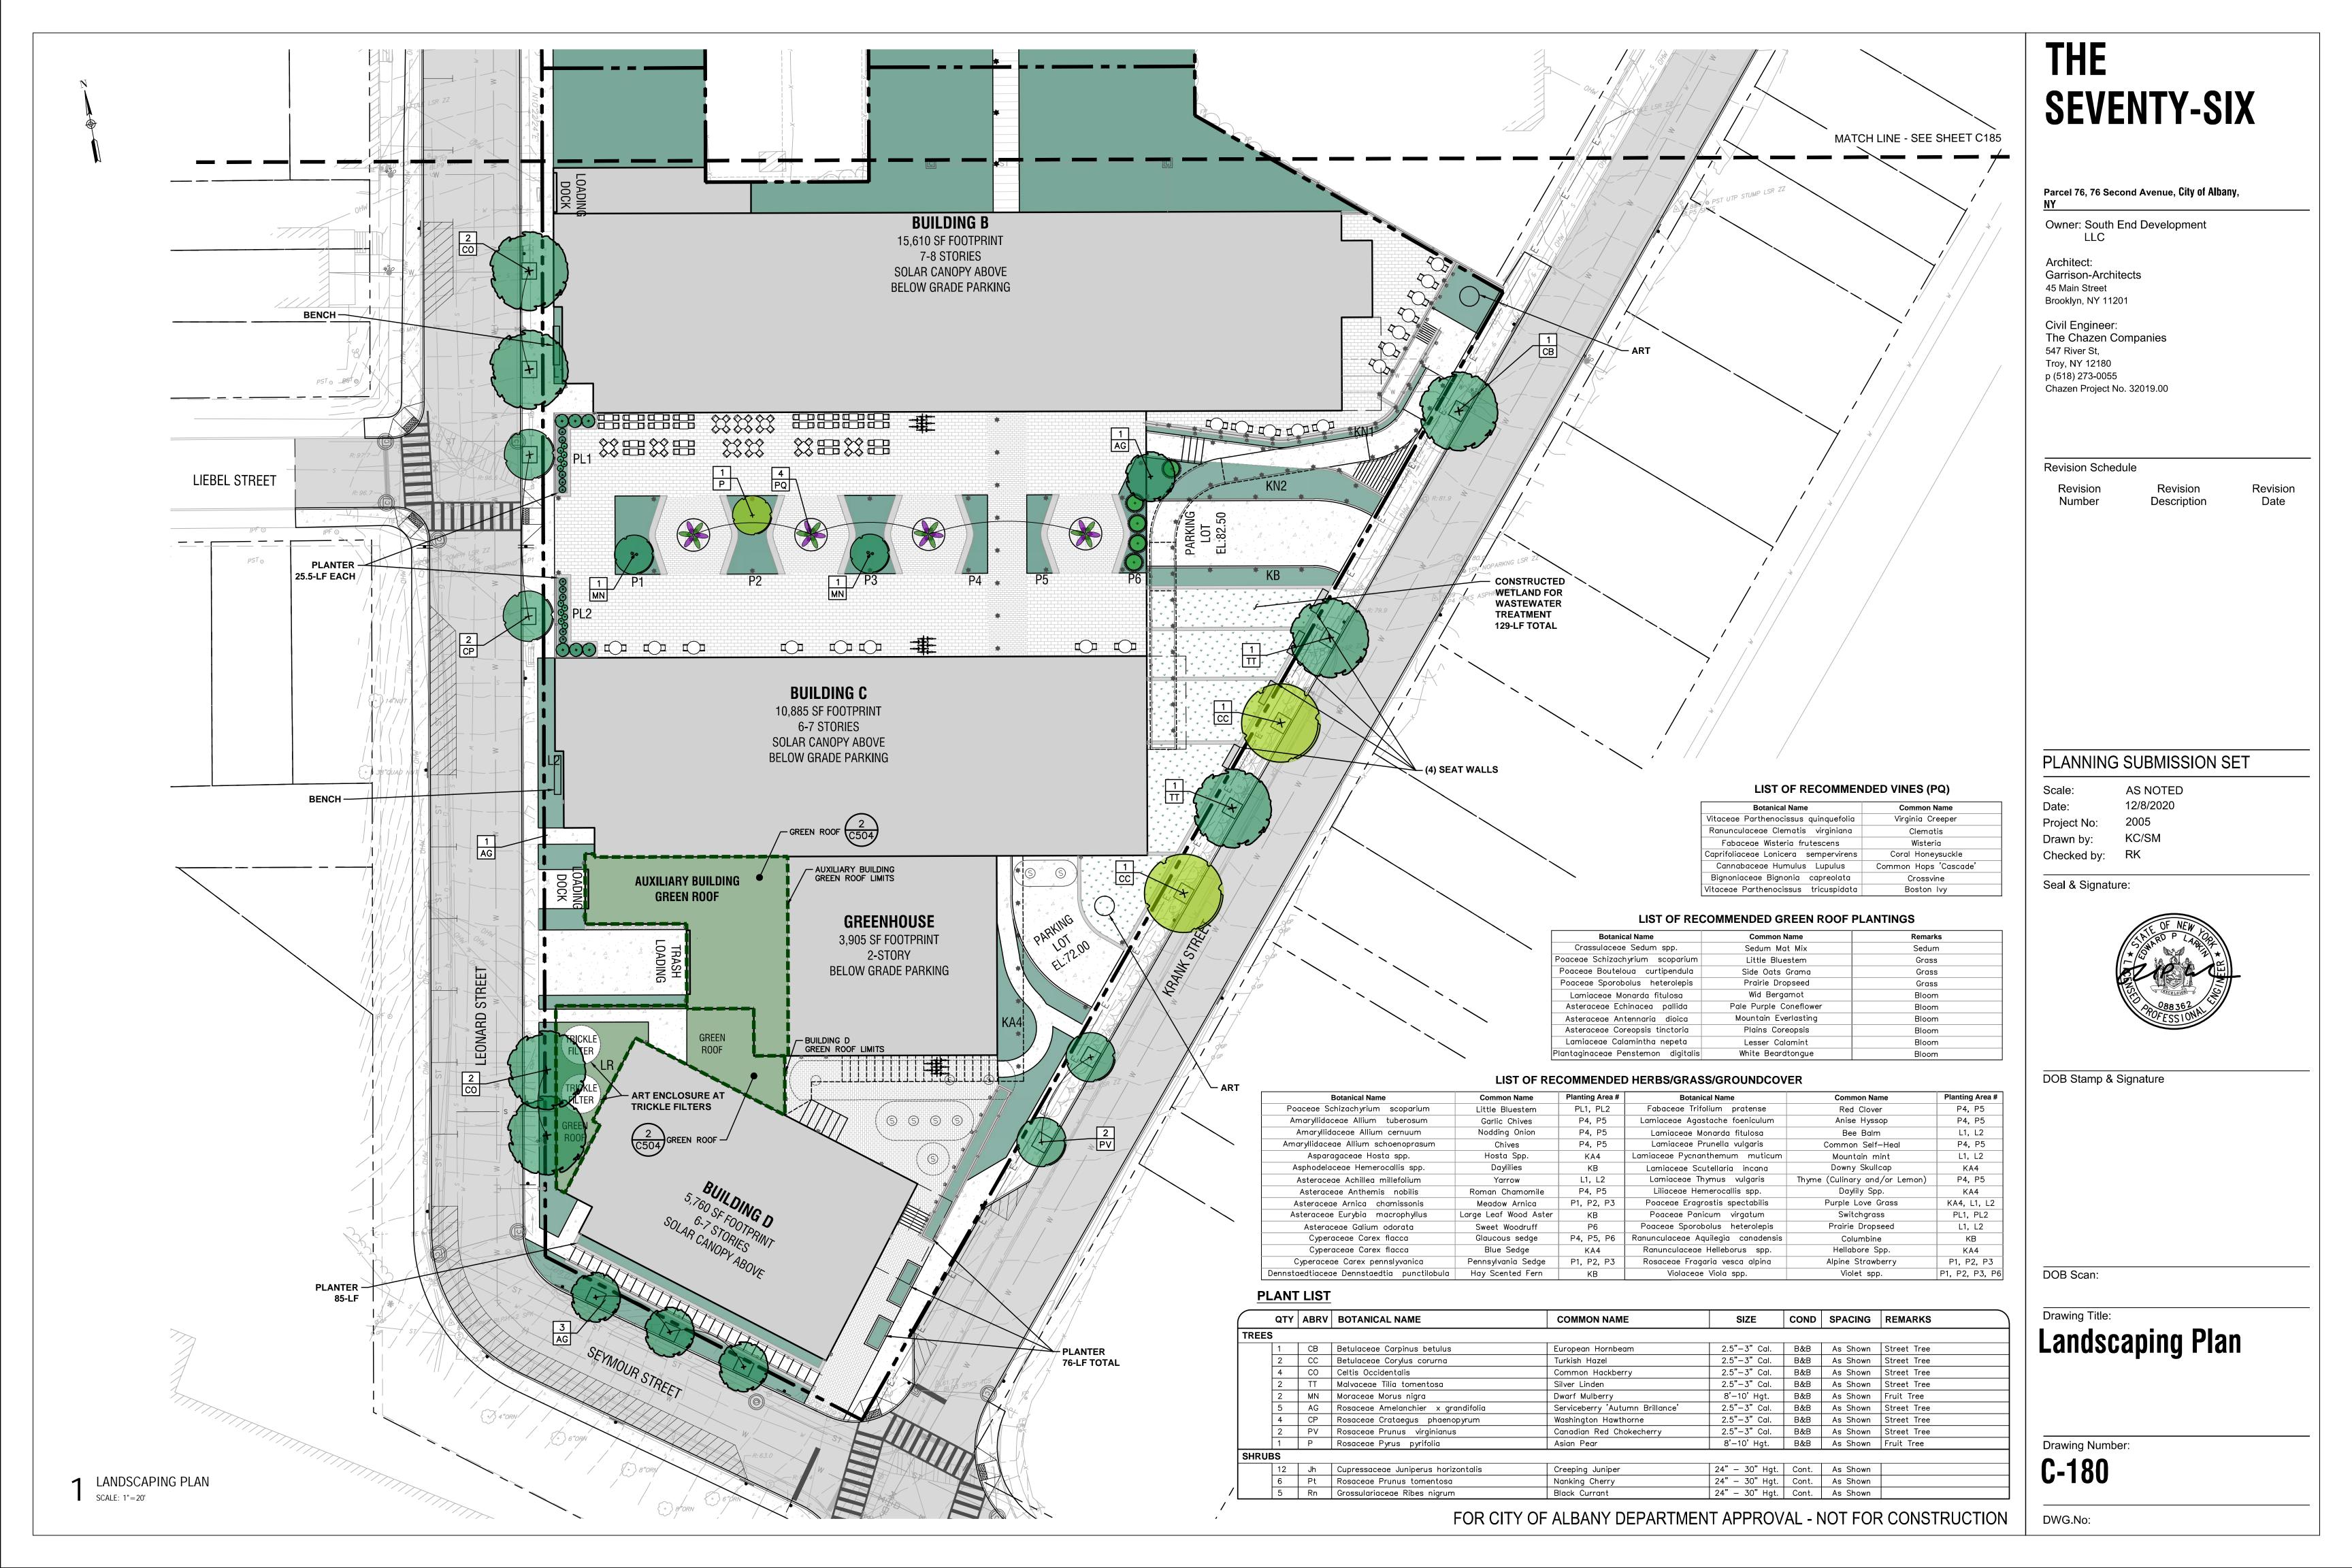
**Utility & Lighting Plan** 


Drawing Number:

C-165

FOR CITY OF ALBANY DEPARTMENT APPROVAL - NOT FOR CONSTRUCTION



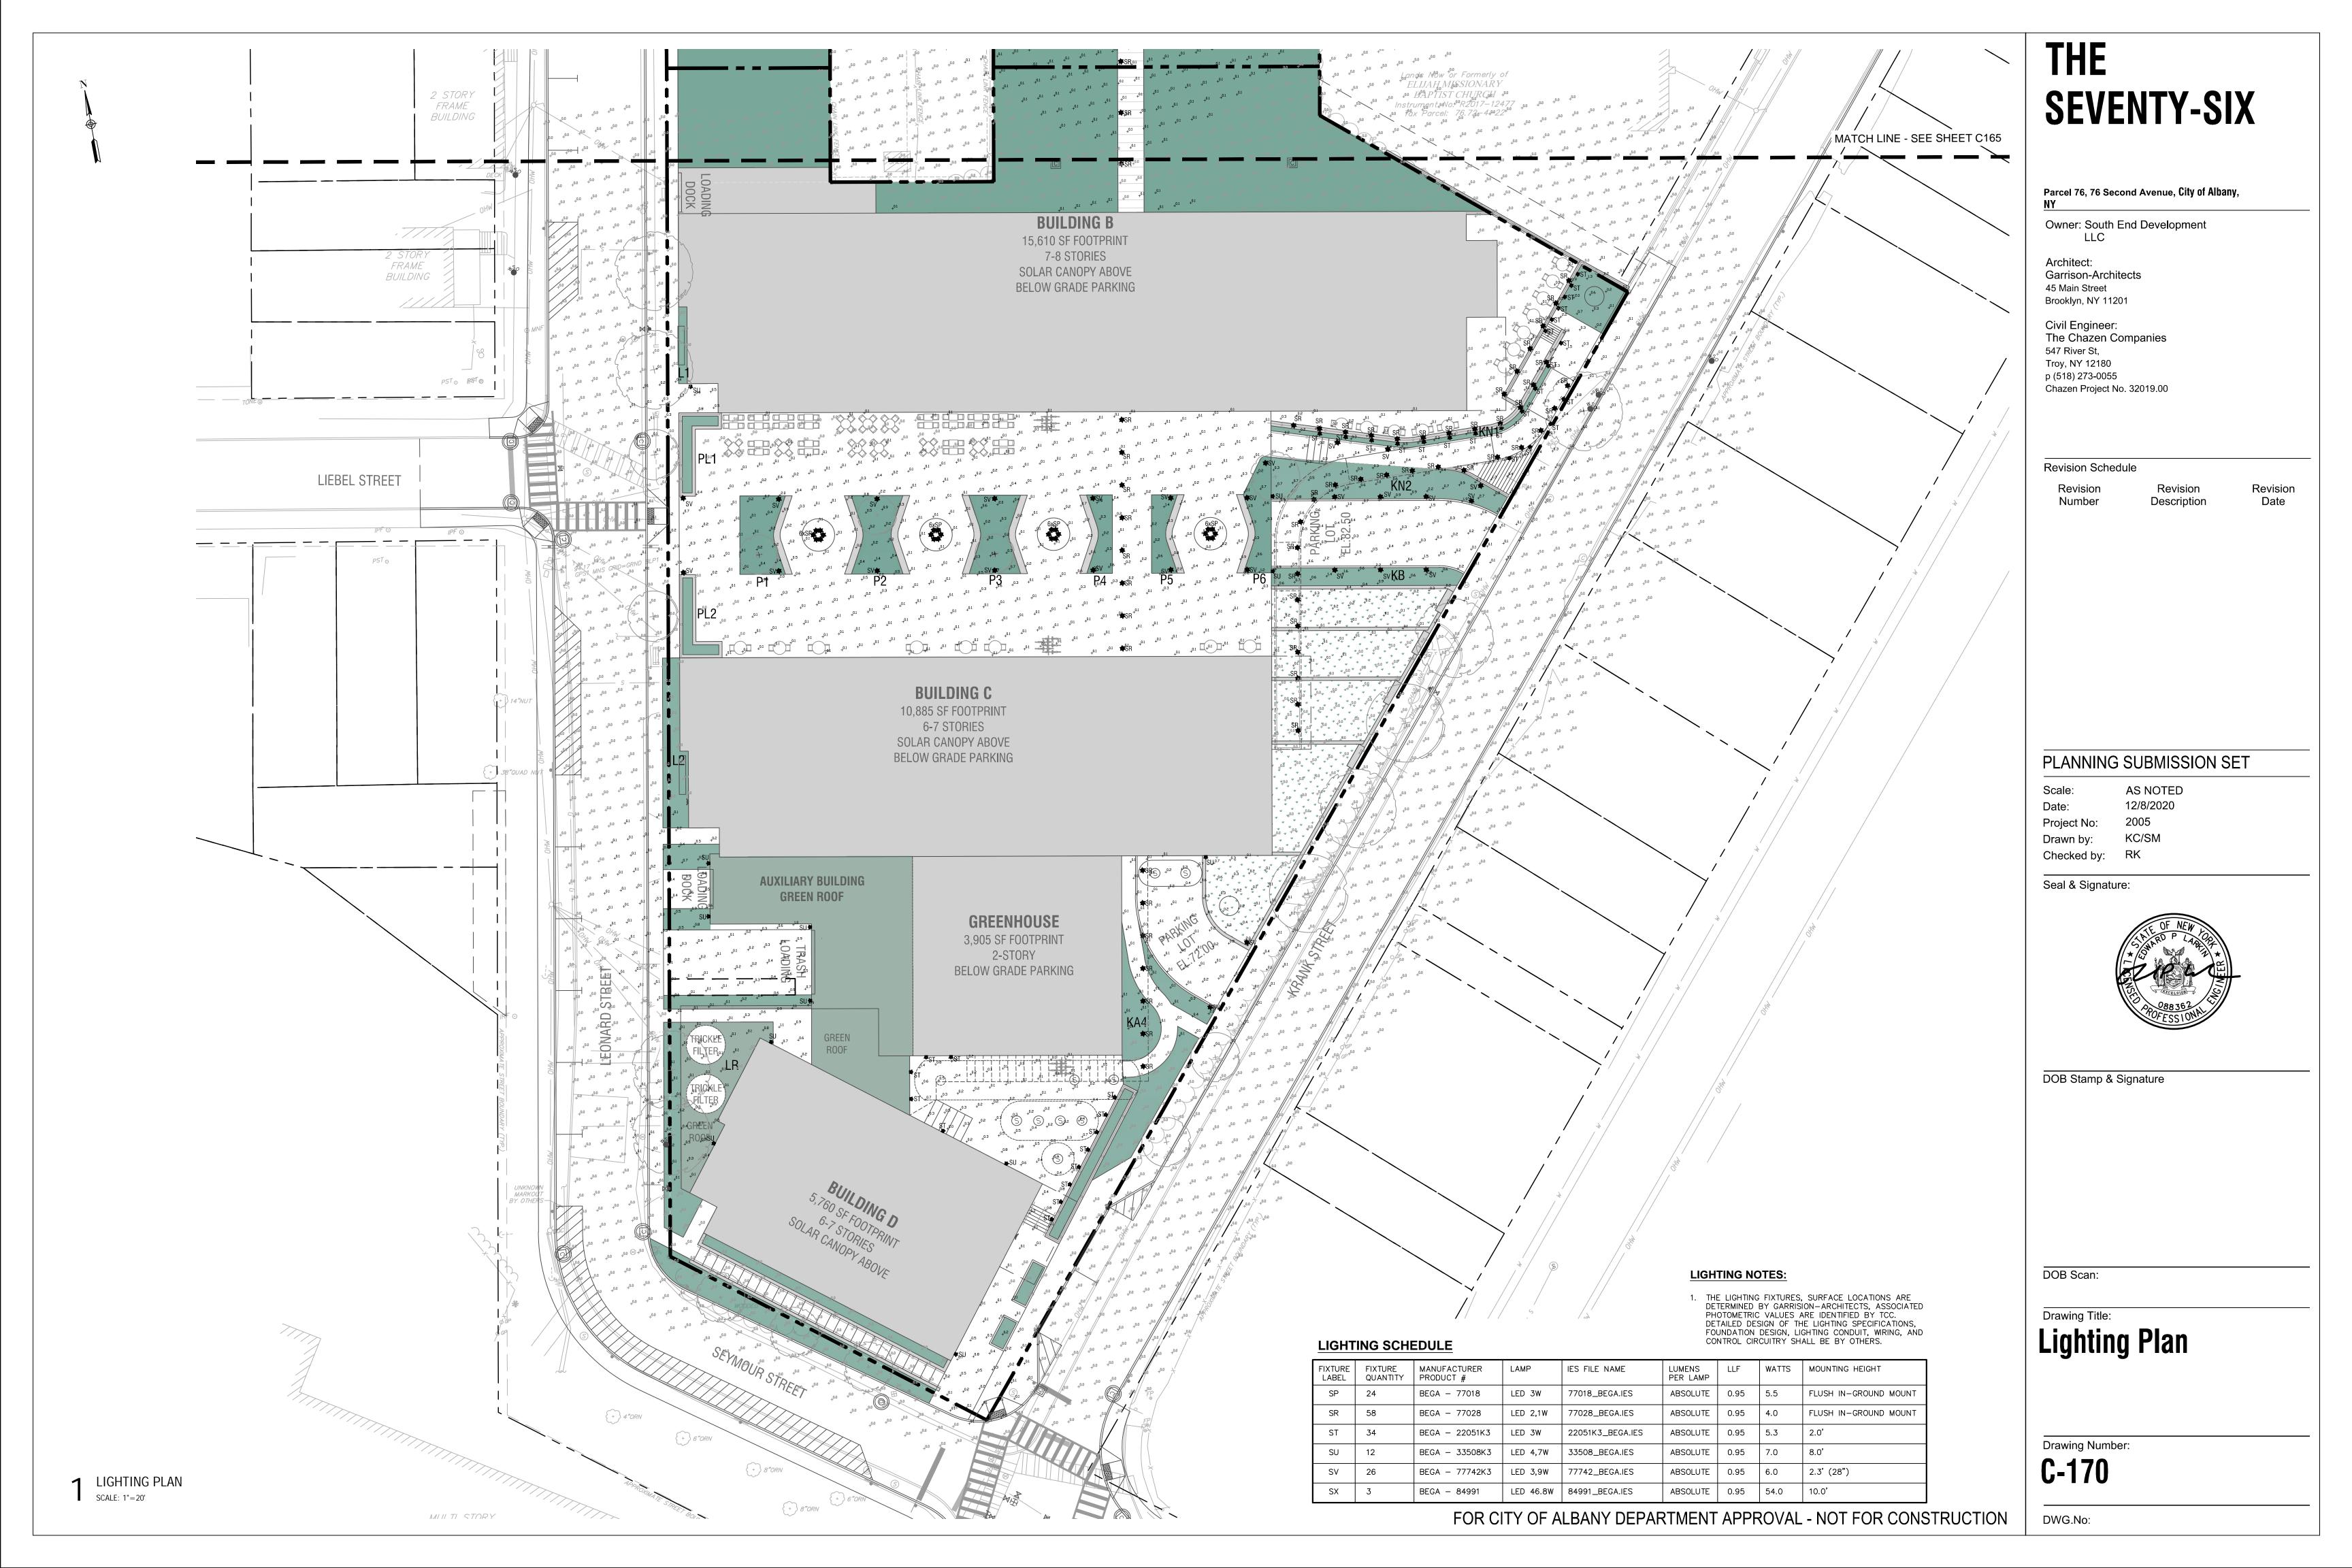

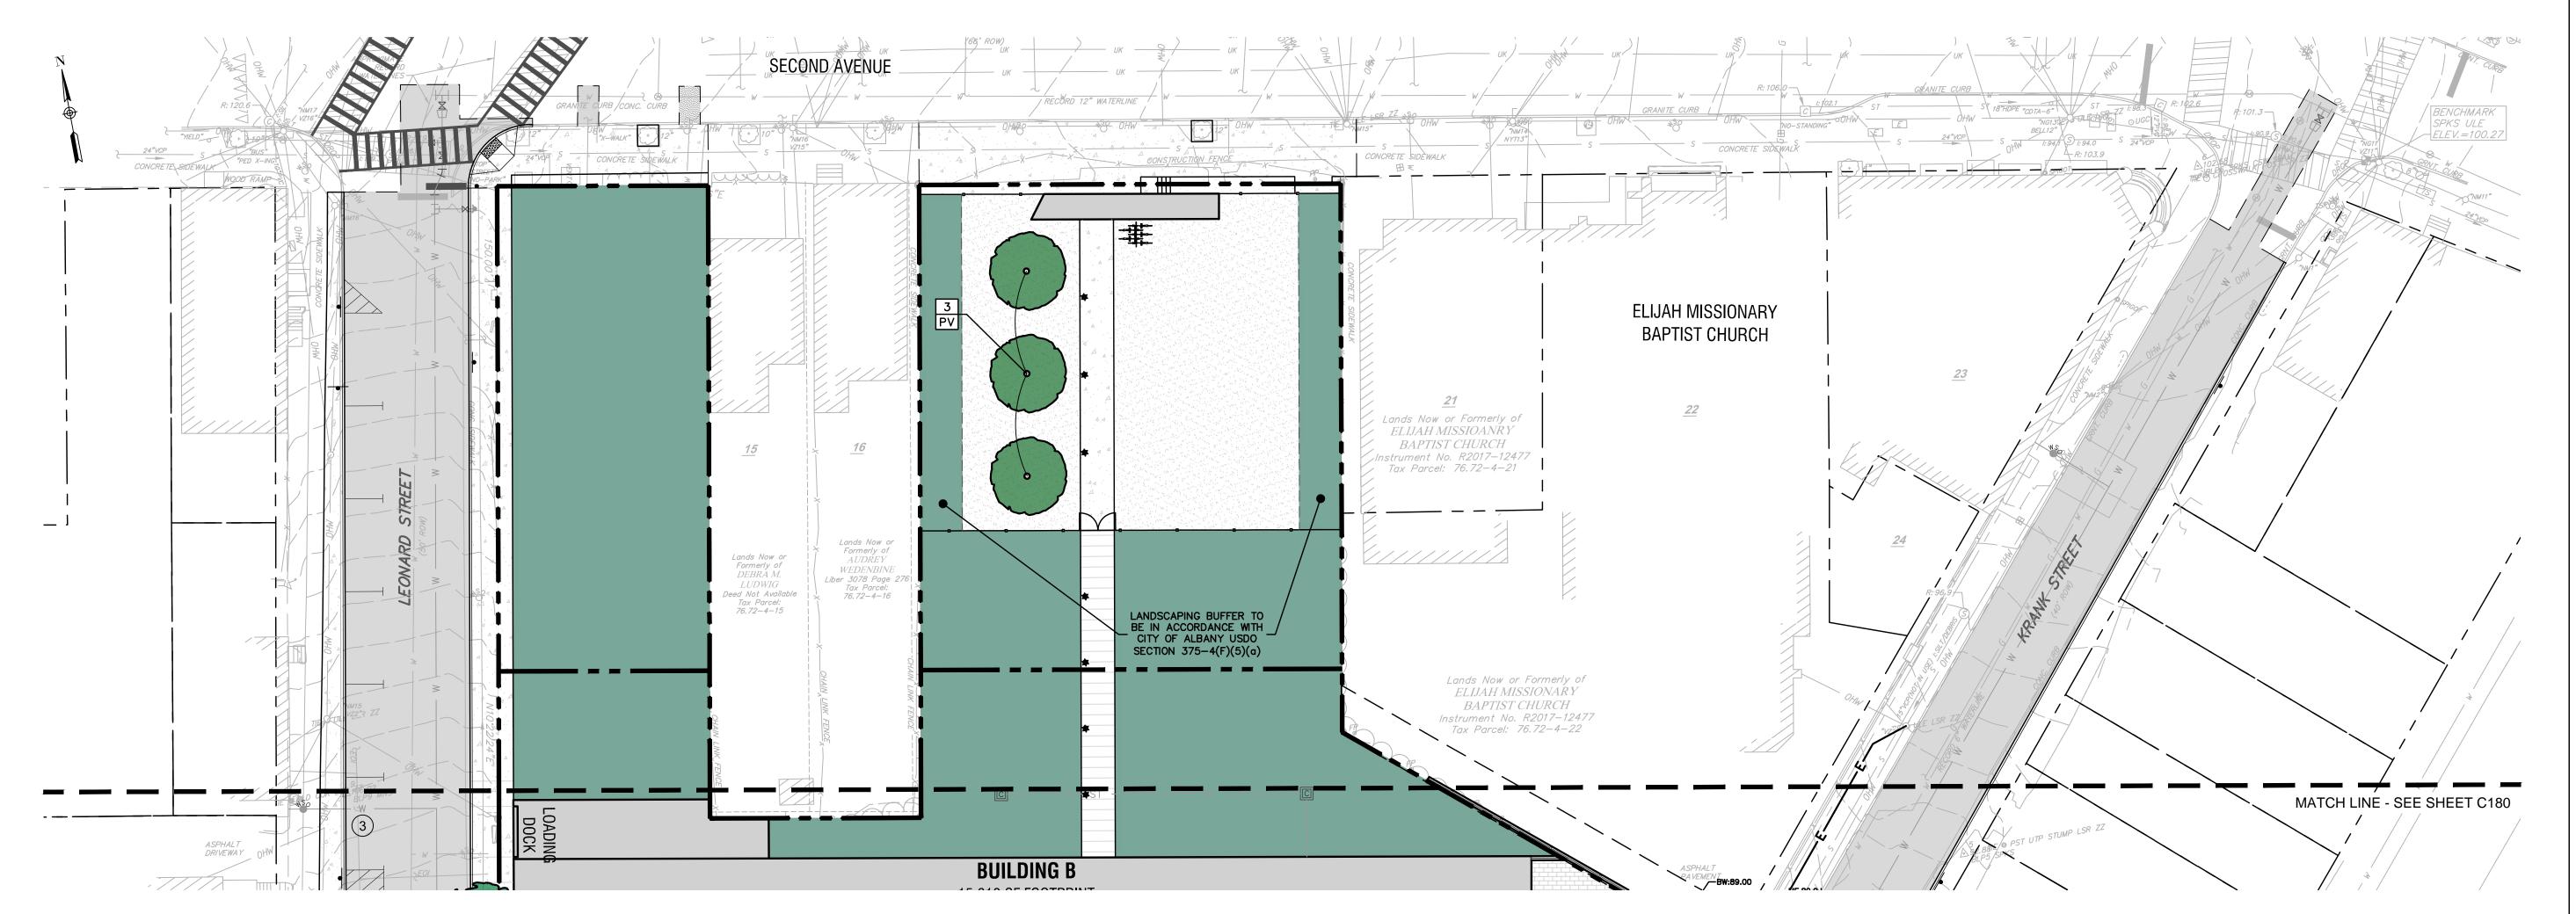

## 1 LANDSCAPING PLAN SCALE: 1"=20'

PLANT LIST

			-					
	QTY	ABRV	BOTANICAL NAME	COMMON NAME	SIZE	COND	SPACING	REMARKS
TR	EES							
	3	PV	Rosaceae Prunus virginianus	Canadian Red Chokecherry	10'-12' Hgt.	B&B	As Shown	

GROUNDCOVER MIX	OPTION FOR LAWN

Option 1	Option 2
'Tall Fescue + micro-clover seed mix'	'Creeping Red Fescue'
	'Hard Fescue'
	'White Clover'

### LIST OF RECOMMENDED GROUNDCOVER FOR BEE LAWN

Botanical Name	Common Name
Cyperaceae Carex pennslyvanica	Pennsylvania Sedge
Lamiaceae Prunella vulgaris	Common Self—Heal
Fabaceae Trifolium repens	White Clover
Asteraceae Anthemis nobilis	Roman Chamomile
Violaceae Viola spp.	Violets
Asteraceae Bellis perennis	English Daisy
Asteraceae Achillea millefolium	Yarrow

# THE SEVENTY-SIX

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Drawn by: KC/SM
Checked by: RK

Seal & Signature:



DOB Stamp & Signature

DOB Scan:

Drawing Title:


# Landscaping & Plant Schedules

Drawing Number:

C-185

DWG.No:

FOR CITY OF ALBANY DEPARTMENT APPROVAL - NOT FOR CONSTRUCTION

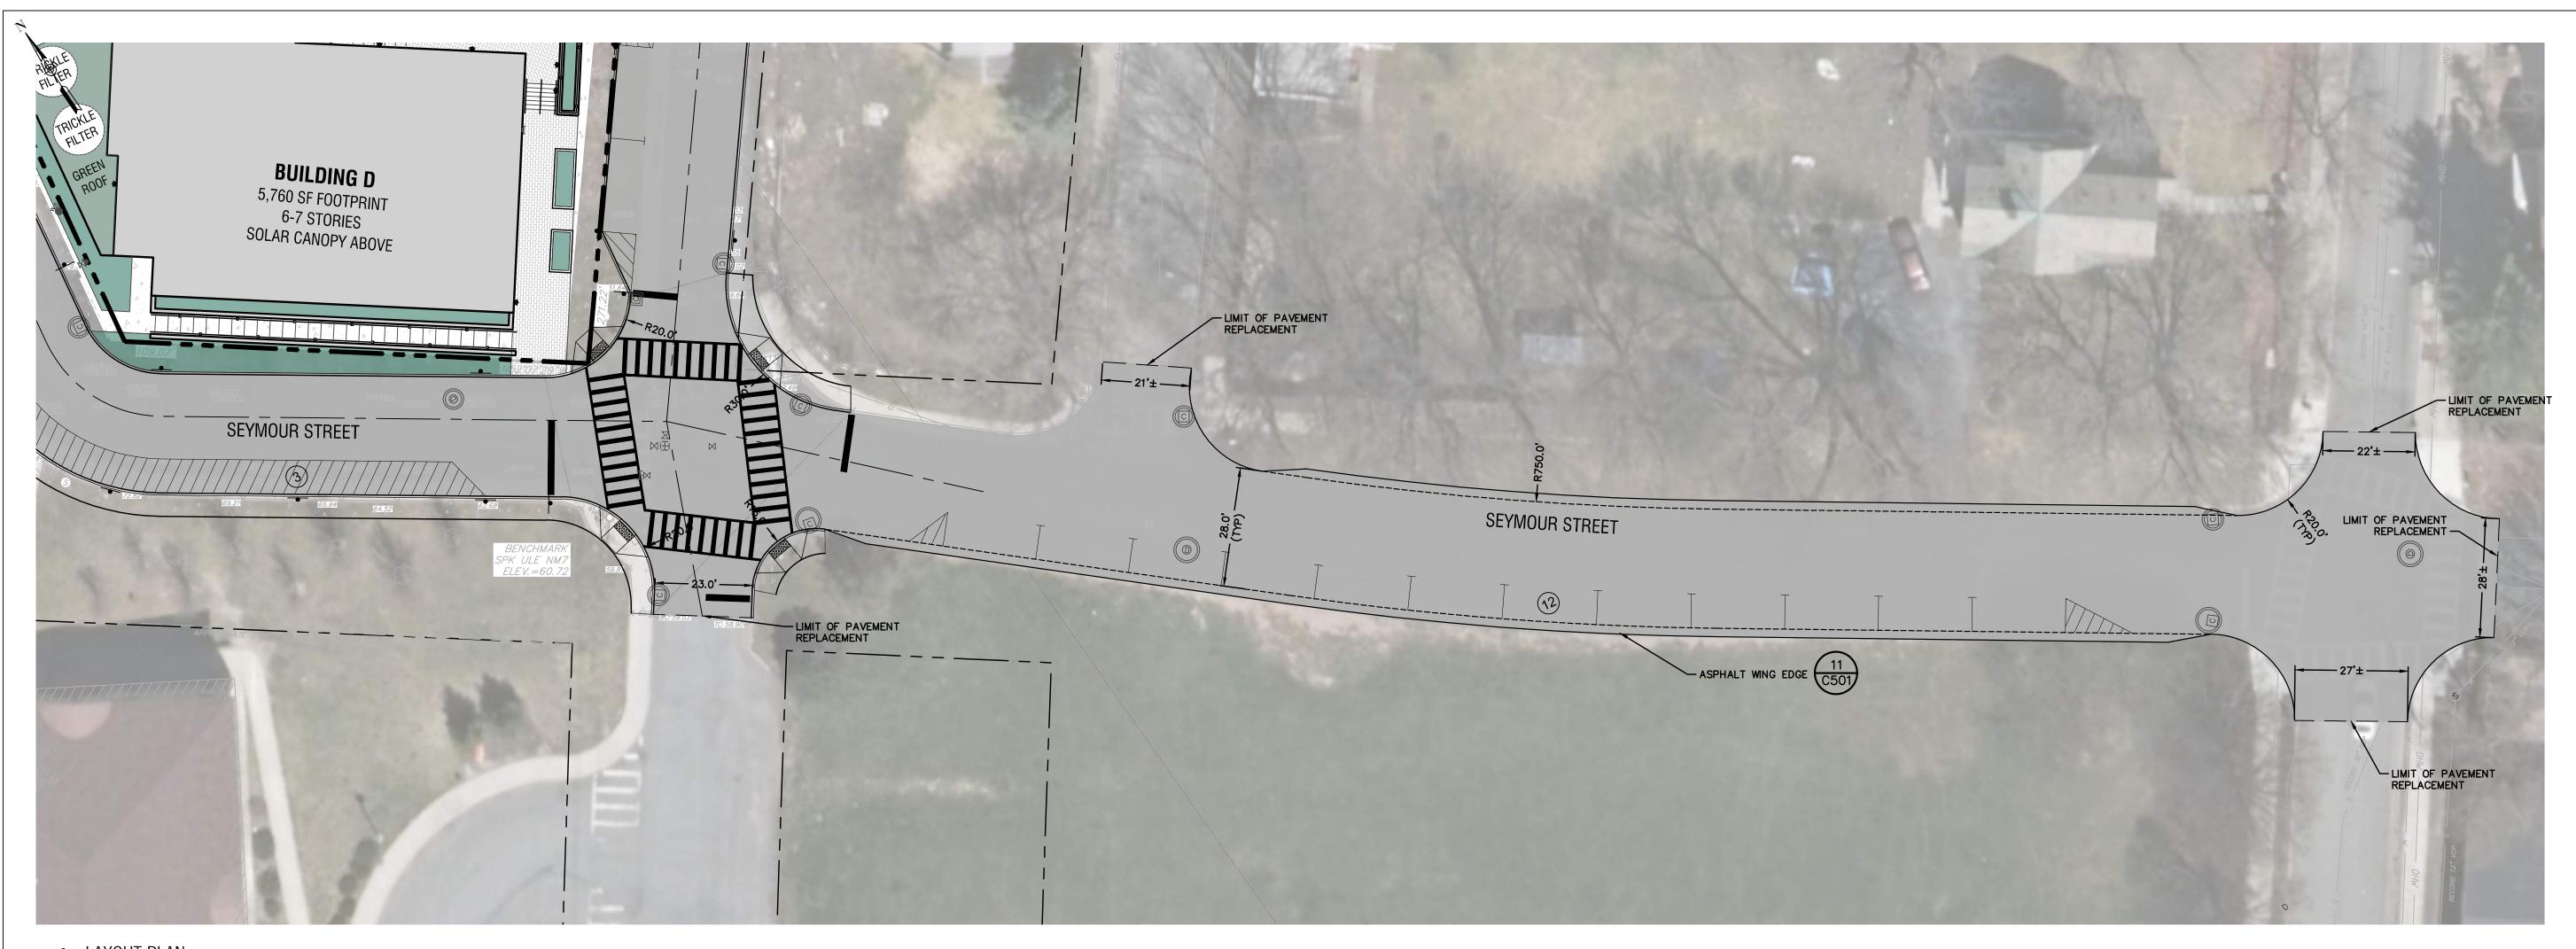

# THE SEVENTY-SIX

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Revision Description

Revision

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DOB Stamp & Signature


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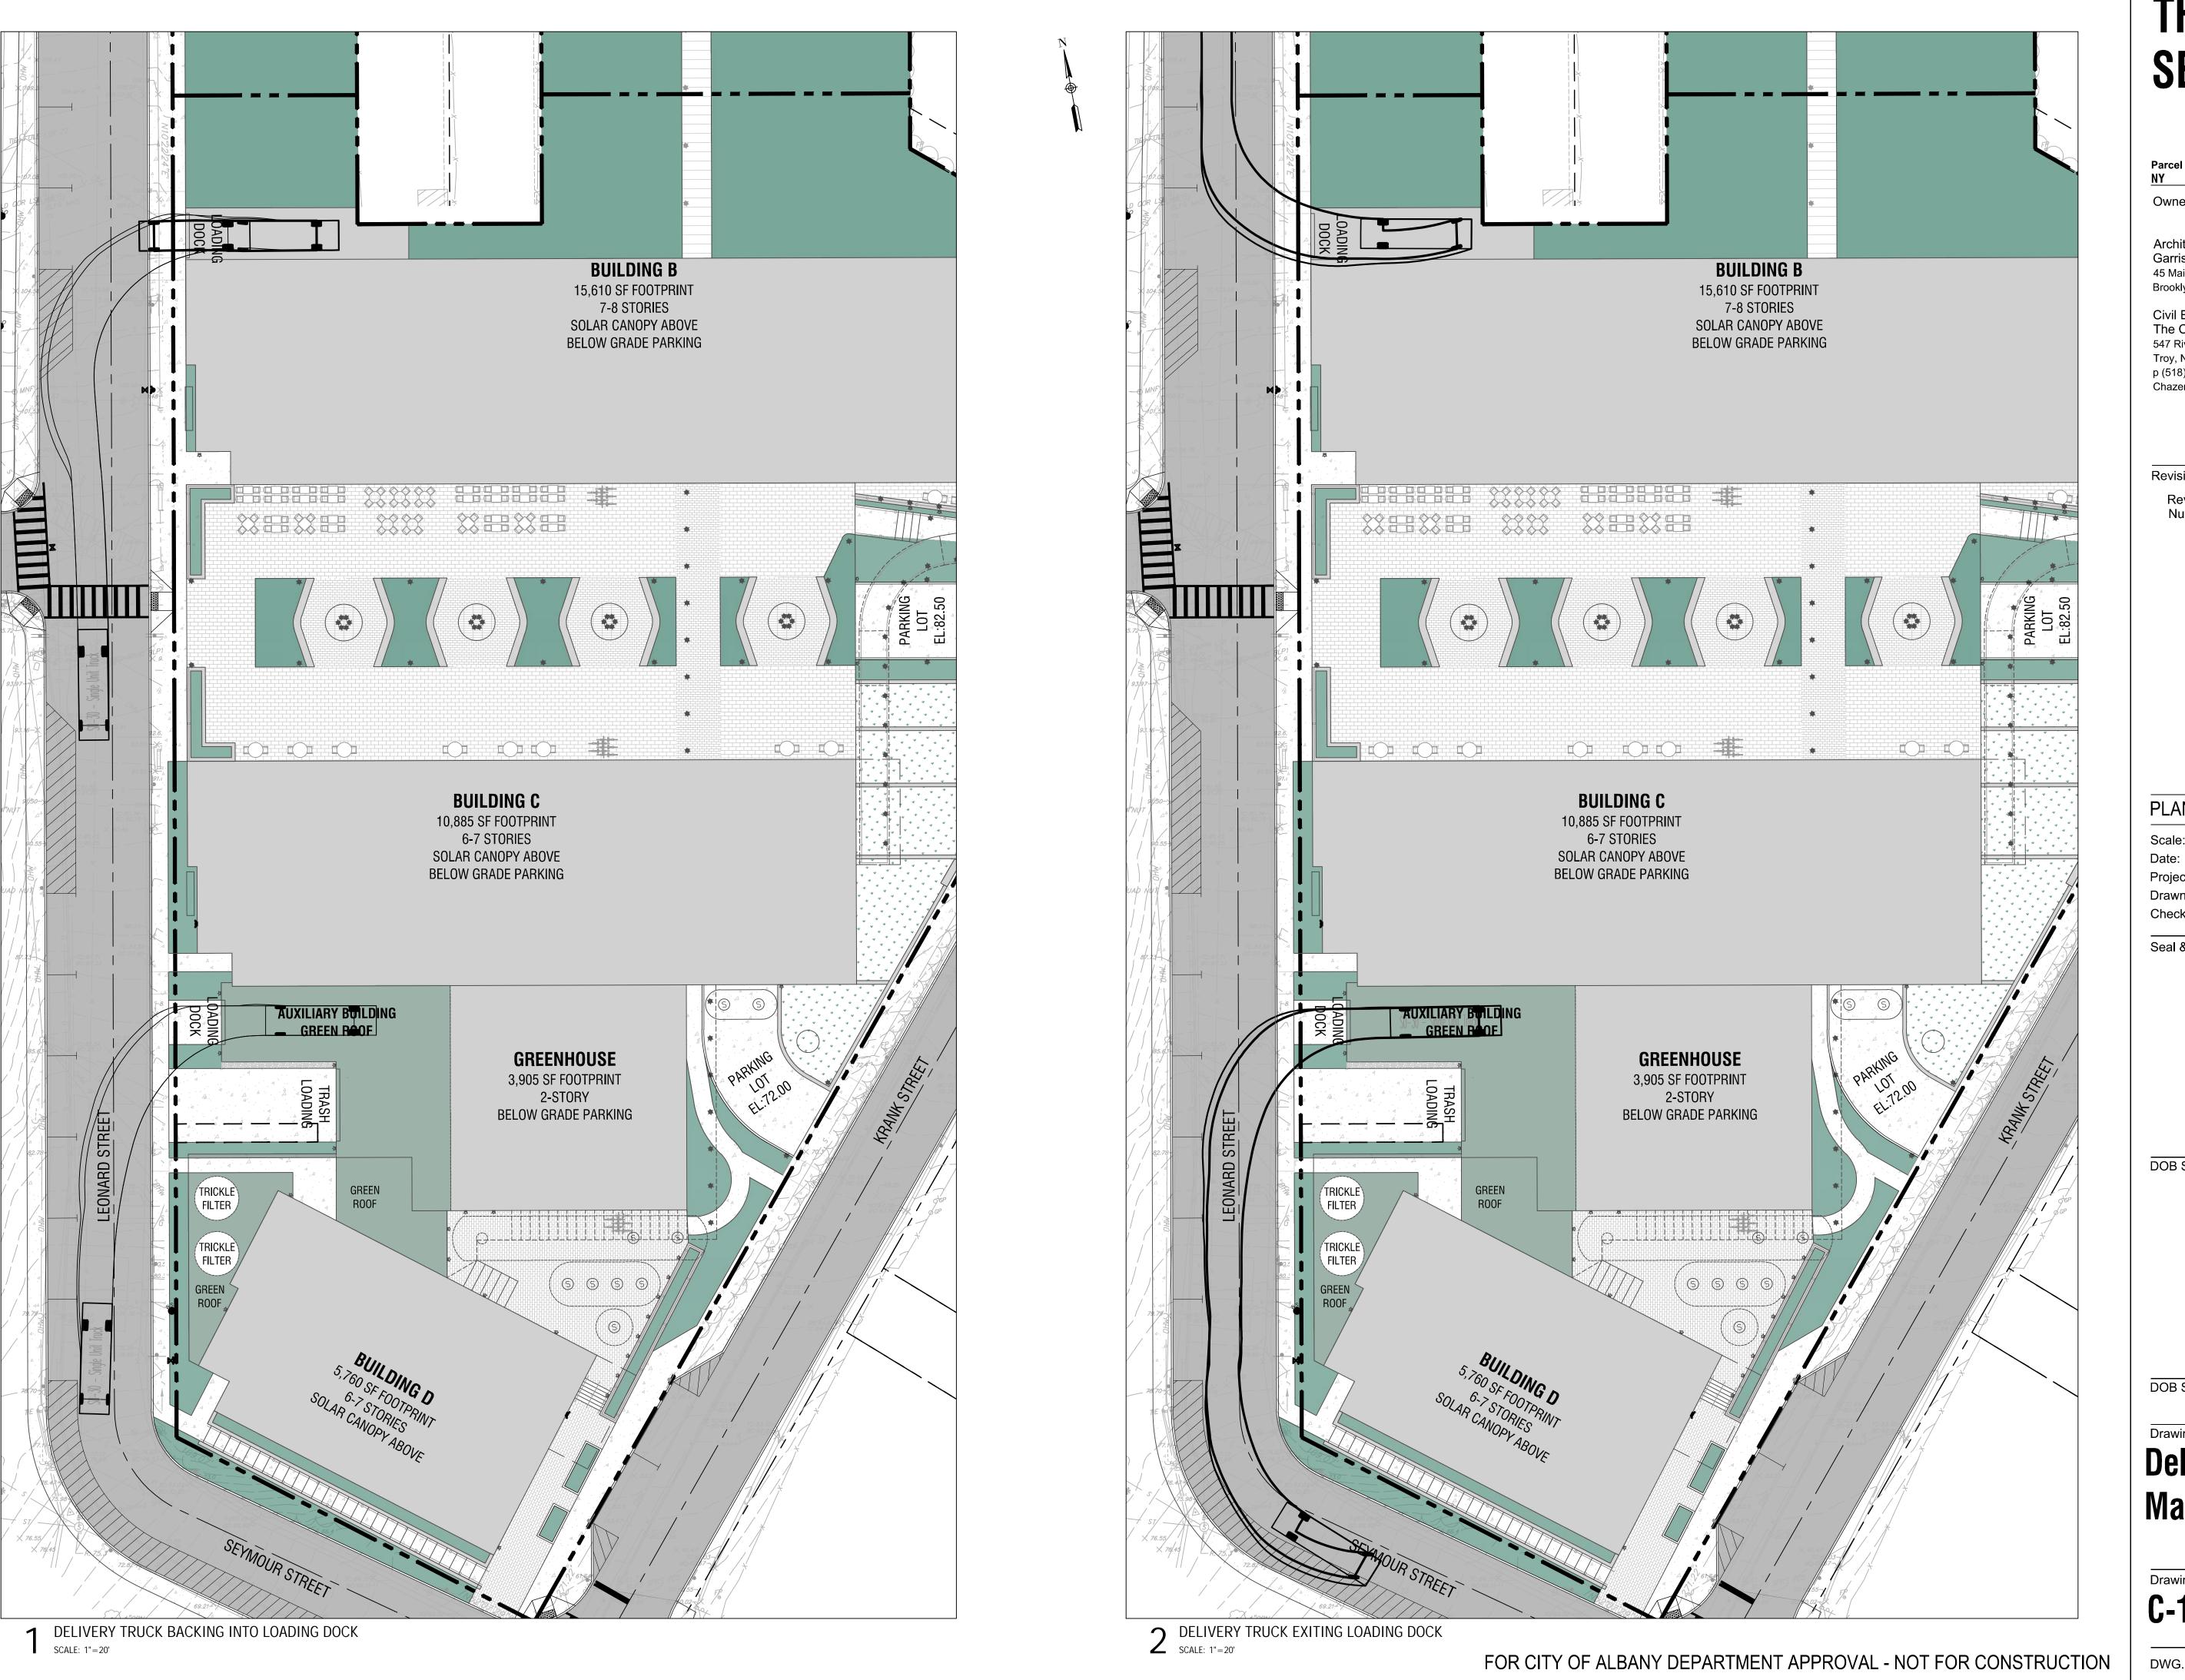
Drawing Title:

## **Offsite Improvements**

Drawing Number: C-190

LAYOUT PLAN SCALE: 1"=20'



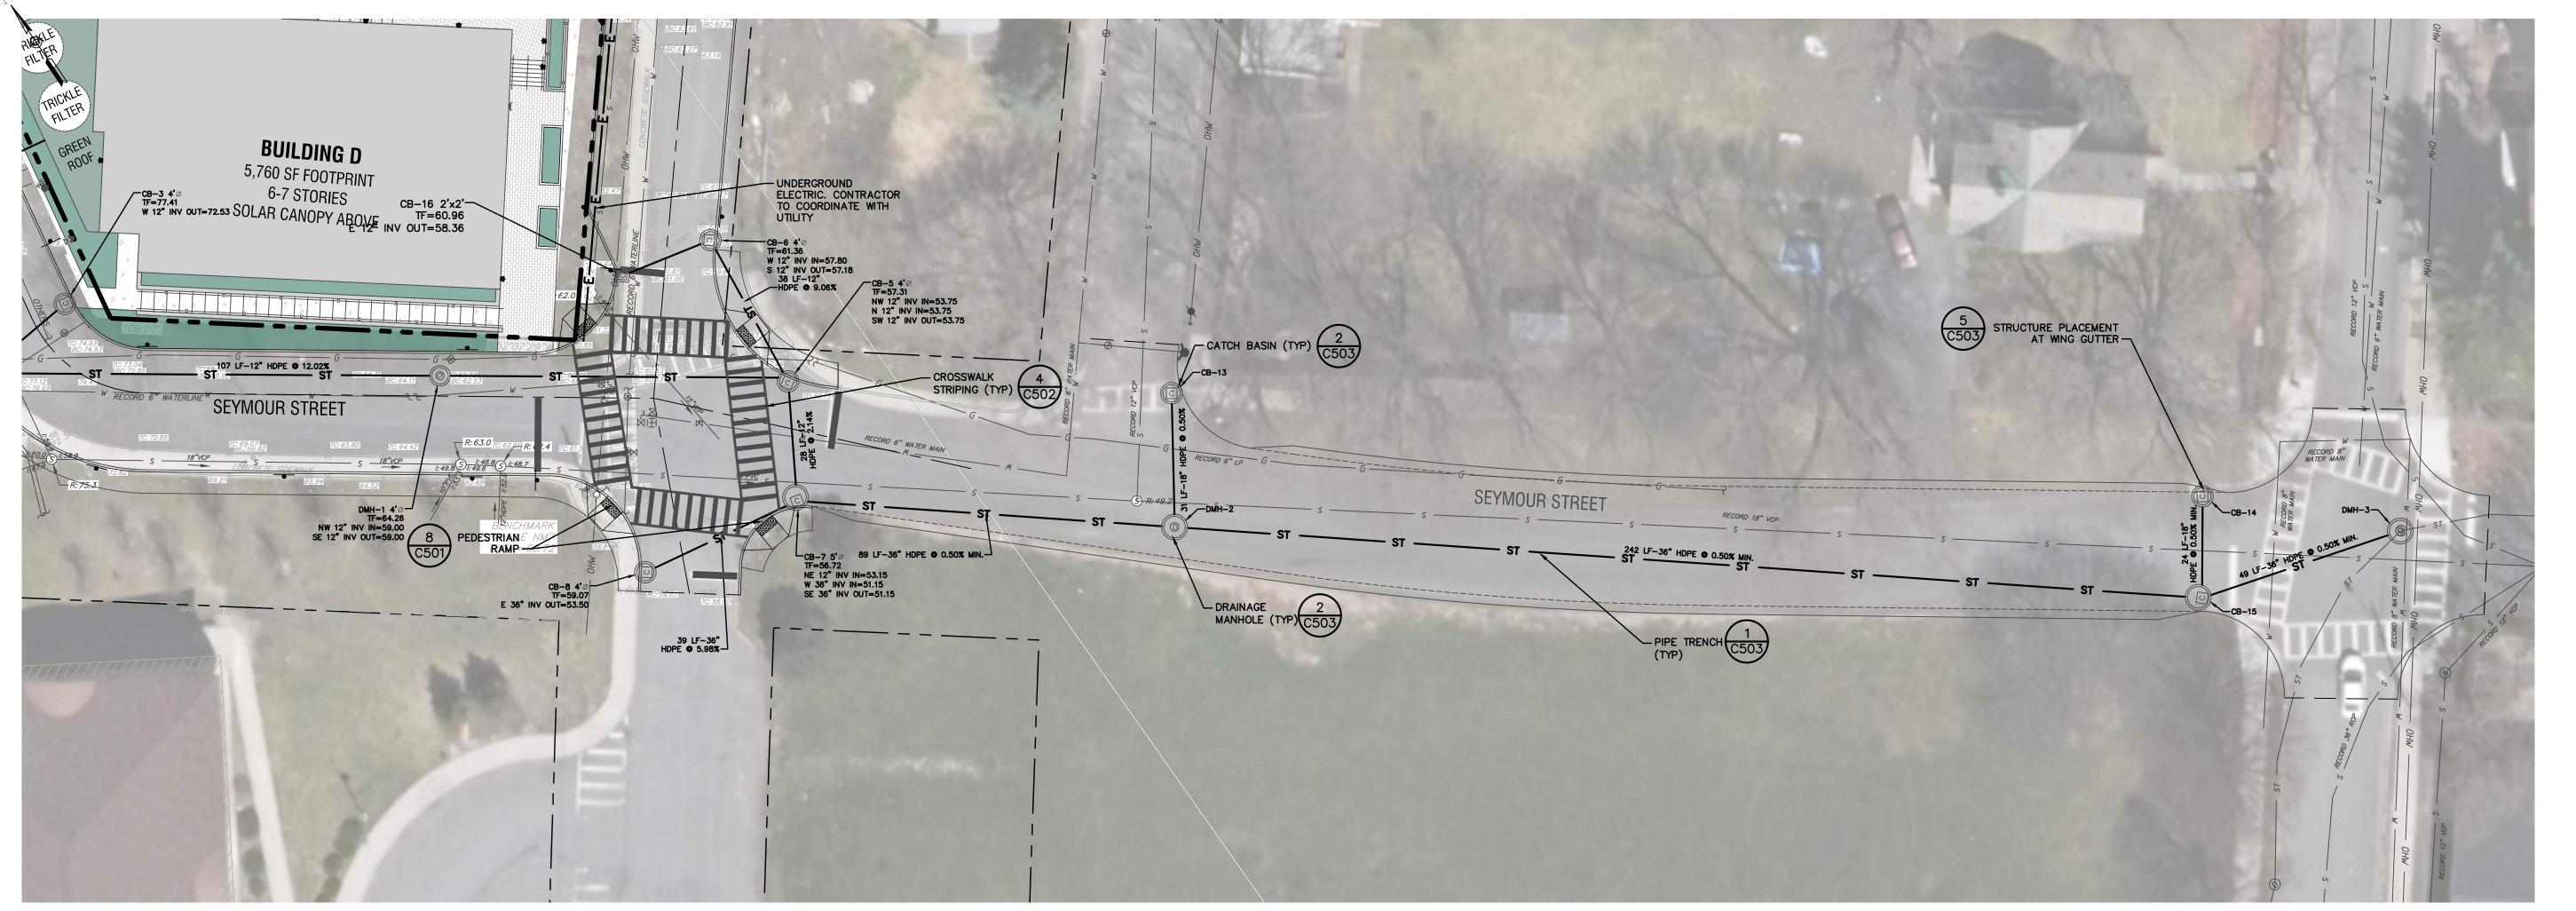

## THE SEVENTY-SIX

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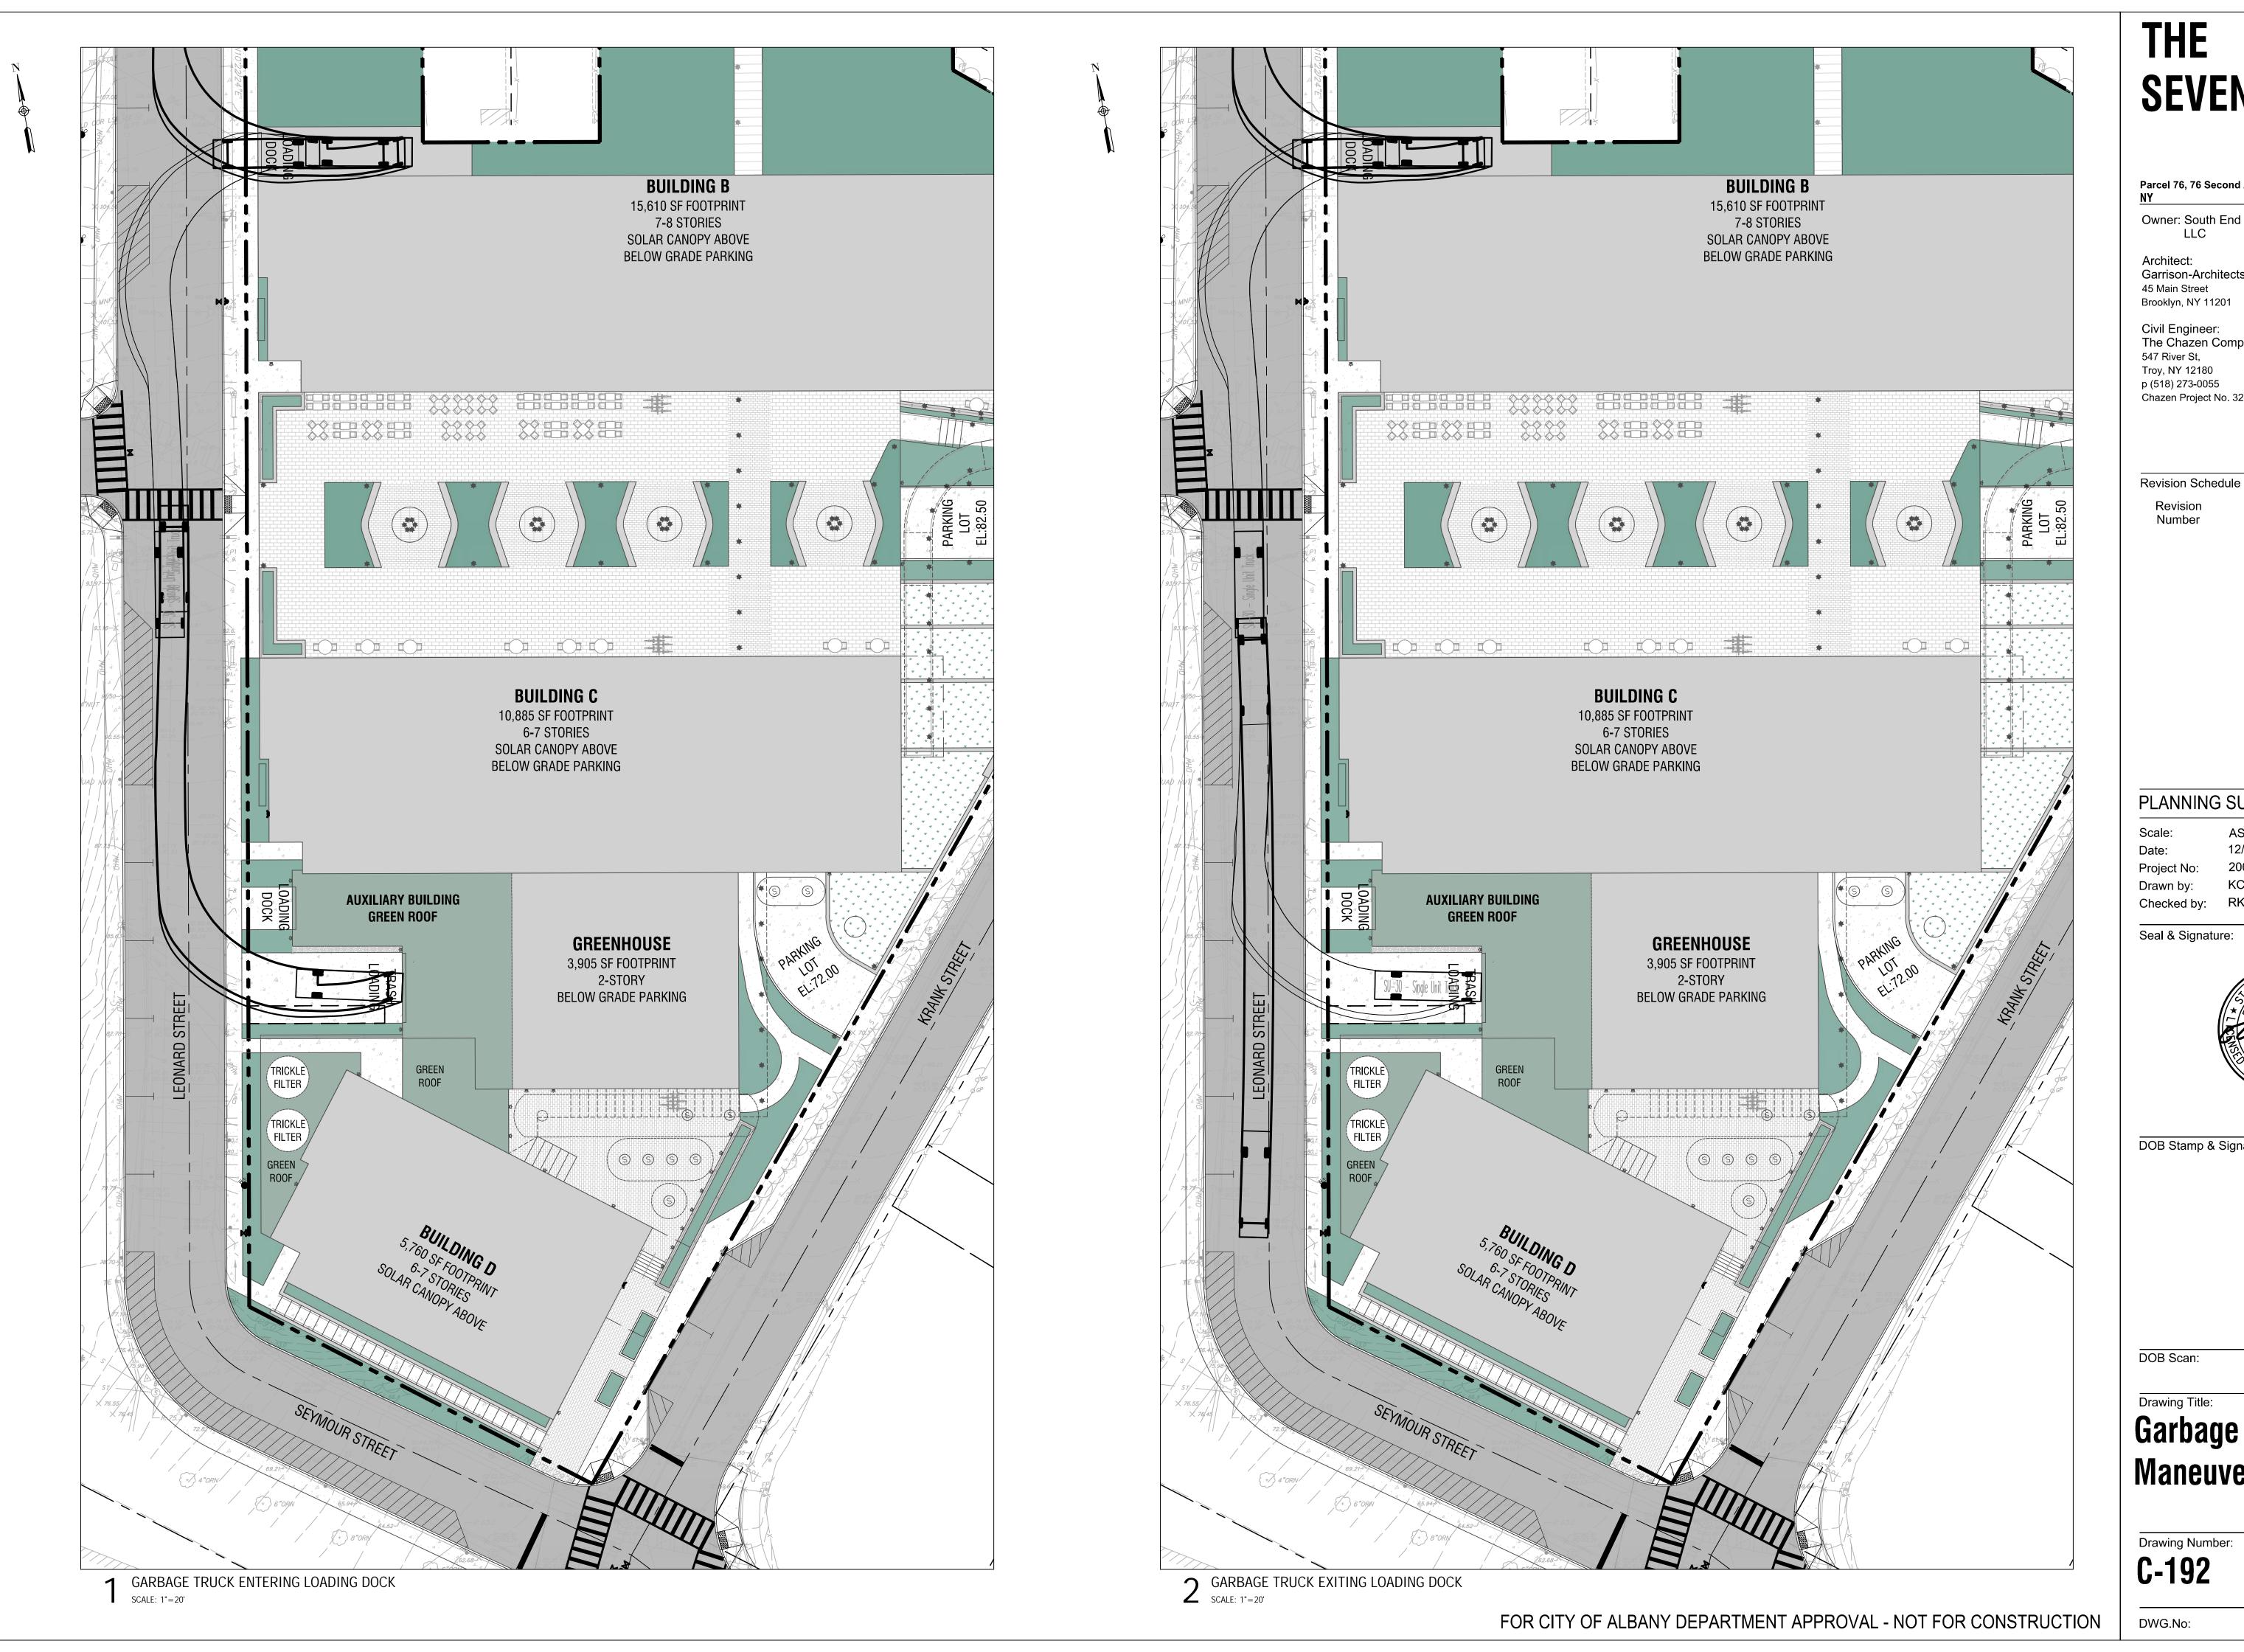
DOB Scan:

Drawing Title:

## **Delivery Truck** Maneuvering Plan

Drawing Number:

C-191



# SEVENTY-SIX

Parcel 76, 76 Second Avenue, City of Albany,

Owner: South End Development

Garrison-Architects

Civil Engineer: The Chazen Companies Troy, NY 12180 p (518) 273-0055 Chazen Project No. 32019.00

Description

Revision


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AS NOTED 12/8/2020




DOB Stamp & Signature

Garbage Truck Maneuvering Plan

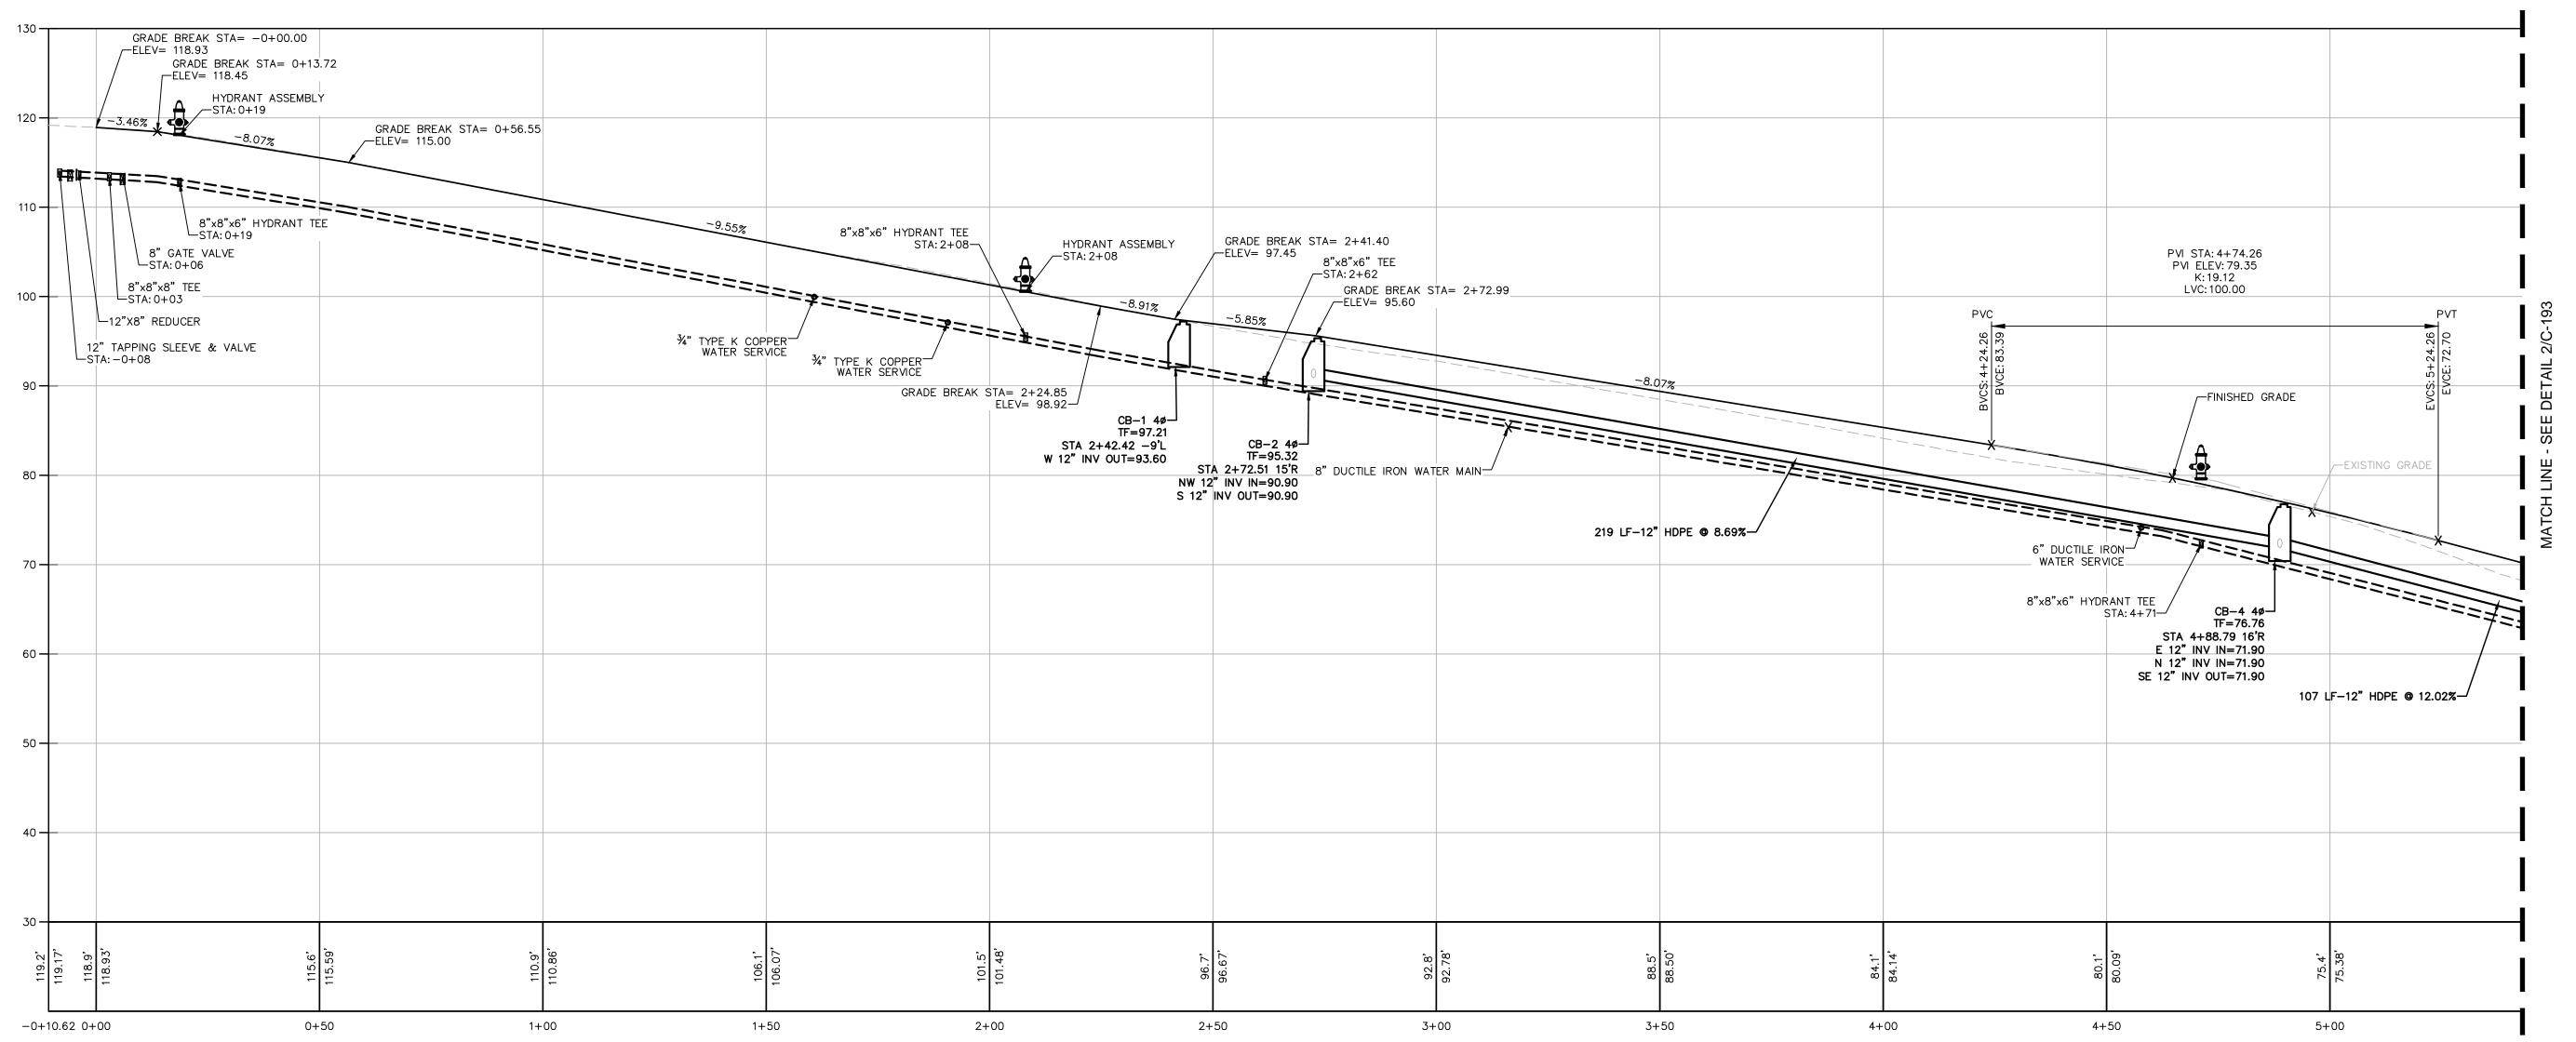

LEONARD ST AND SEYMOUR ST PROFILE STA:0+00 TO STA 5+50 SCALE: H: 1"=20' V: 1"=10'

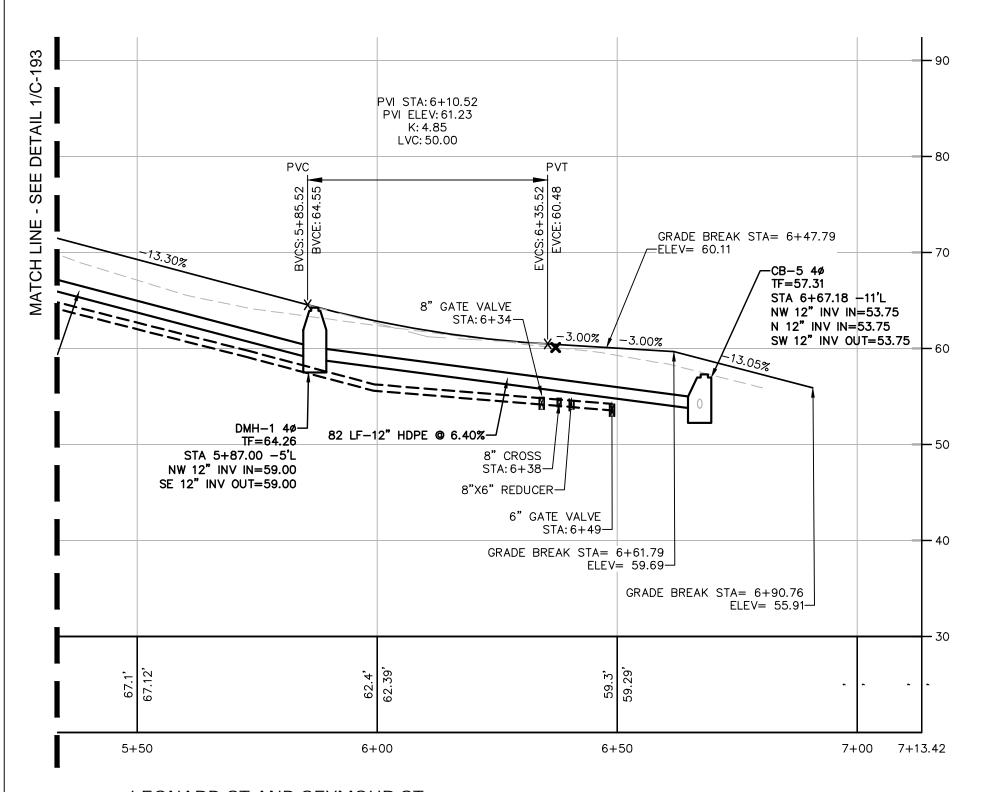

---- EXISTING GRADE ABBREVIATIONS:
PVC POINT OF VERTICAL CURVE
PVI POINT OF VERTICAL INTERSECTION POINT OF VERTICAL TANGENCY HORIZONTAL VERTICAL INSIDE DIAMETER SLOPE INVERT CATCH BASIN DRAINAGE MANHOLE SMH FES CO WSO SEWER MANHOLE FAIRED END SECTION CLEAN OUT WATER SHUT OFF HYD HYDRANT DUCTILE IRON PIPE VITRIFIED CLAY POLYVINYLCLORIDE PIPE HIGH DENSITY POLYETHYLENE PIPE CORRUGATED METAL PIPE REINFORCED CONCRETE PIPE SMOOTH INTERIOR CORRUGATED POLYETHYLENE PIPE

PROFILE LEGEND:

1. STATIONING SHOWN ON PROFILE IS CENTERLINE OF ROADWAY STATIONING.
2. PRESSURE AND LEAKAGE TESTING OF THE WATER MAIN SHALL BE WITNESSED BY DEPARTMENT STAFF AND ACCEPTABLE BACTERIOLOGICAL TEST MUST BE SUBMITTED AND ACCEPTED BY THE DEPARTMENT PRIOR TO FINAL ACCEPTANCE OF THE NEW WATER MAIN.
3. 48—HOURS NOTICE MUST BE GIVEN TO THE DEPARTMENT OF WATER FOR INSPECTIONS.

2 LEONARD ST AND SEYMOUR ST STA 5+50 TO 7+13.42 SCALE: H: 1"=20' V: 1"=10'

FOR CITY OF ALBANY DEPARTMENT APPROVAL - NOT FOR CONSTRUCTION

# THE SEVENTY-SIX

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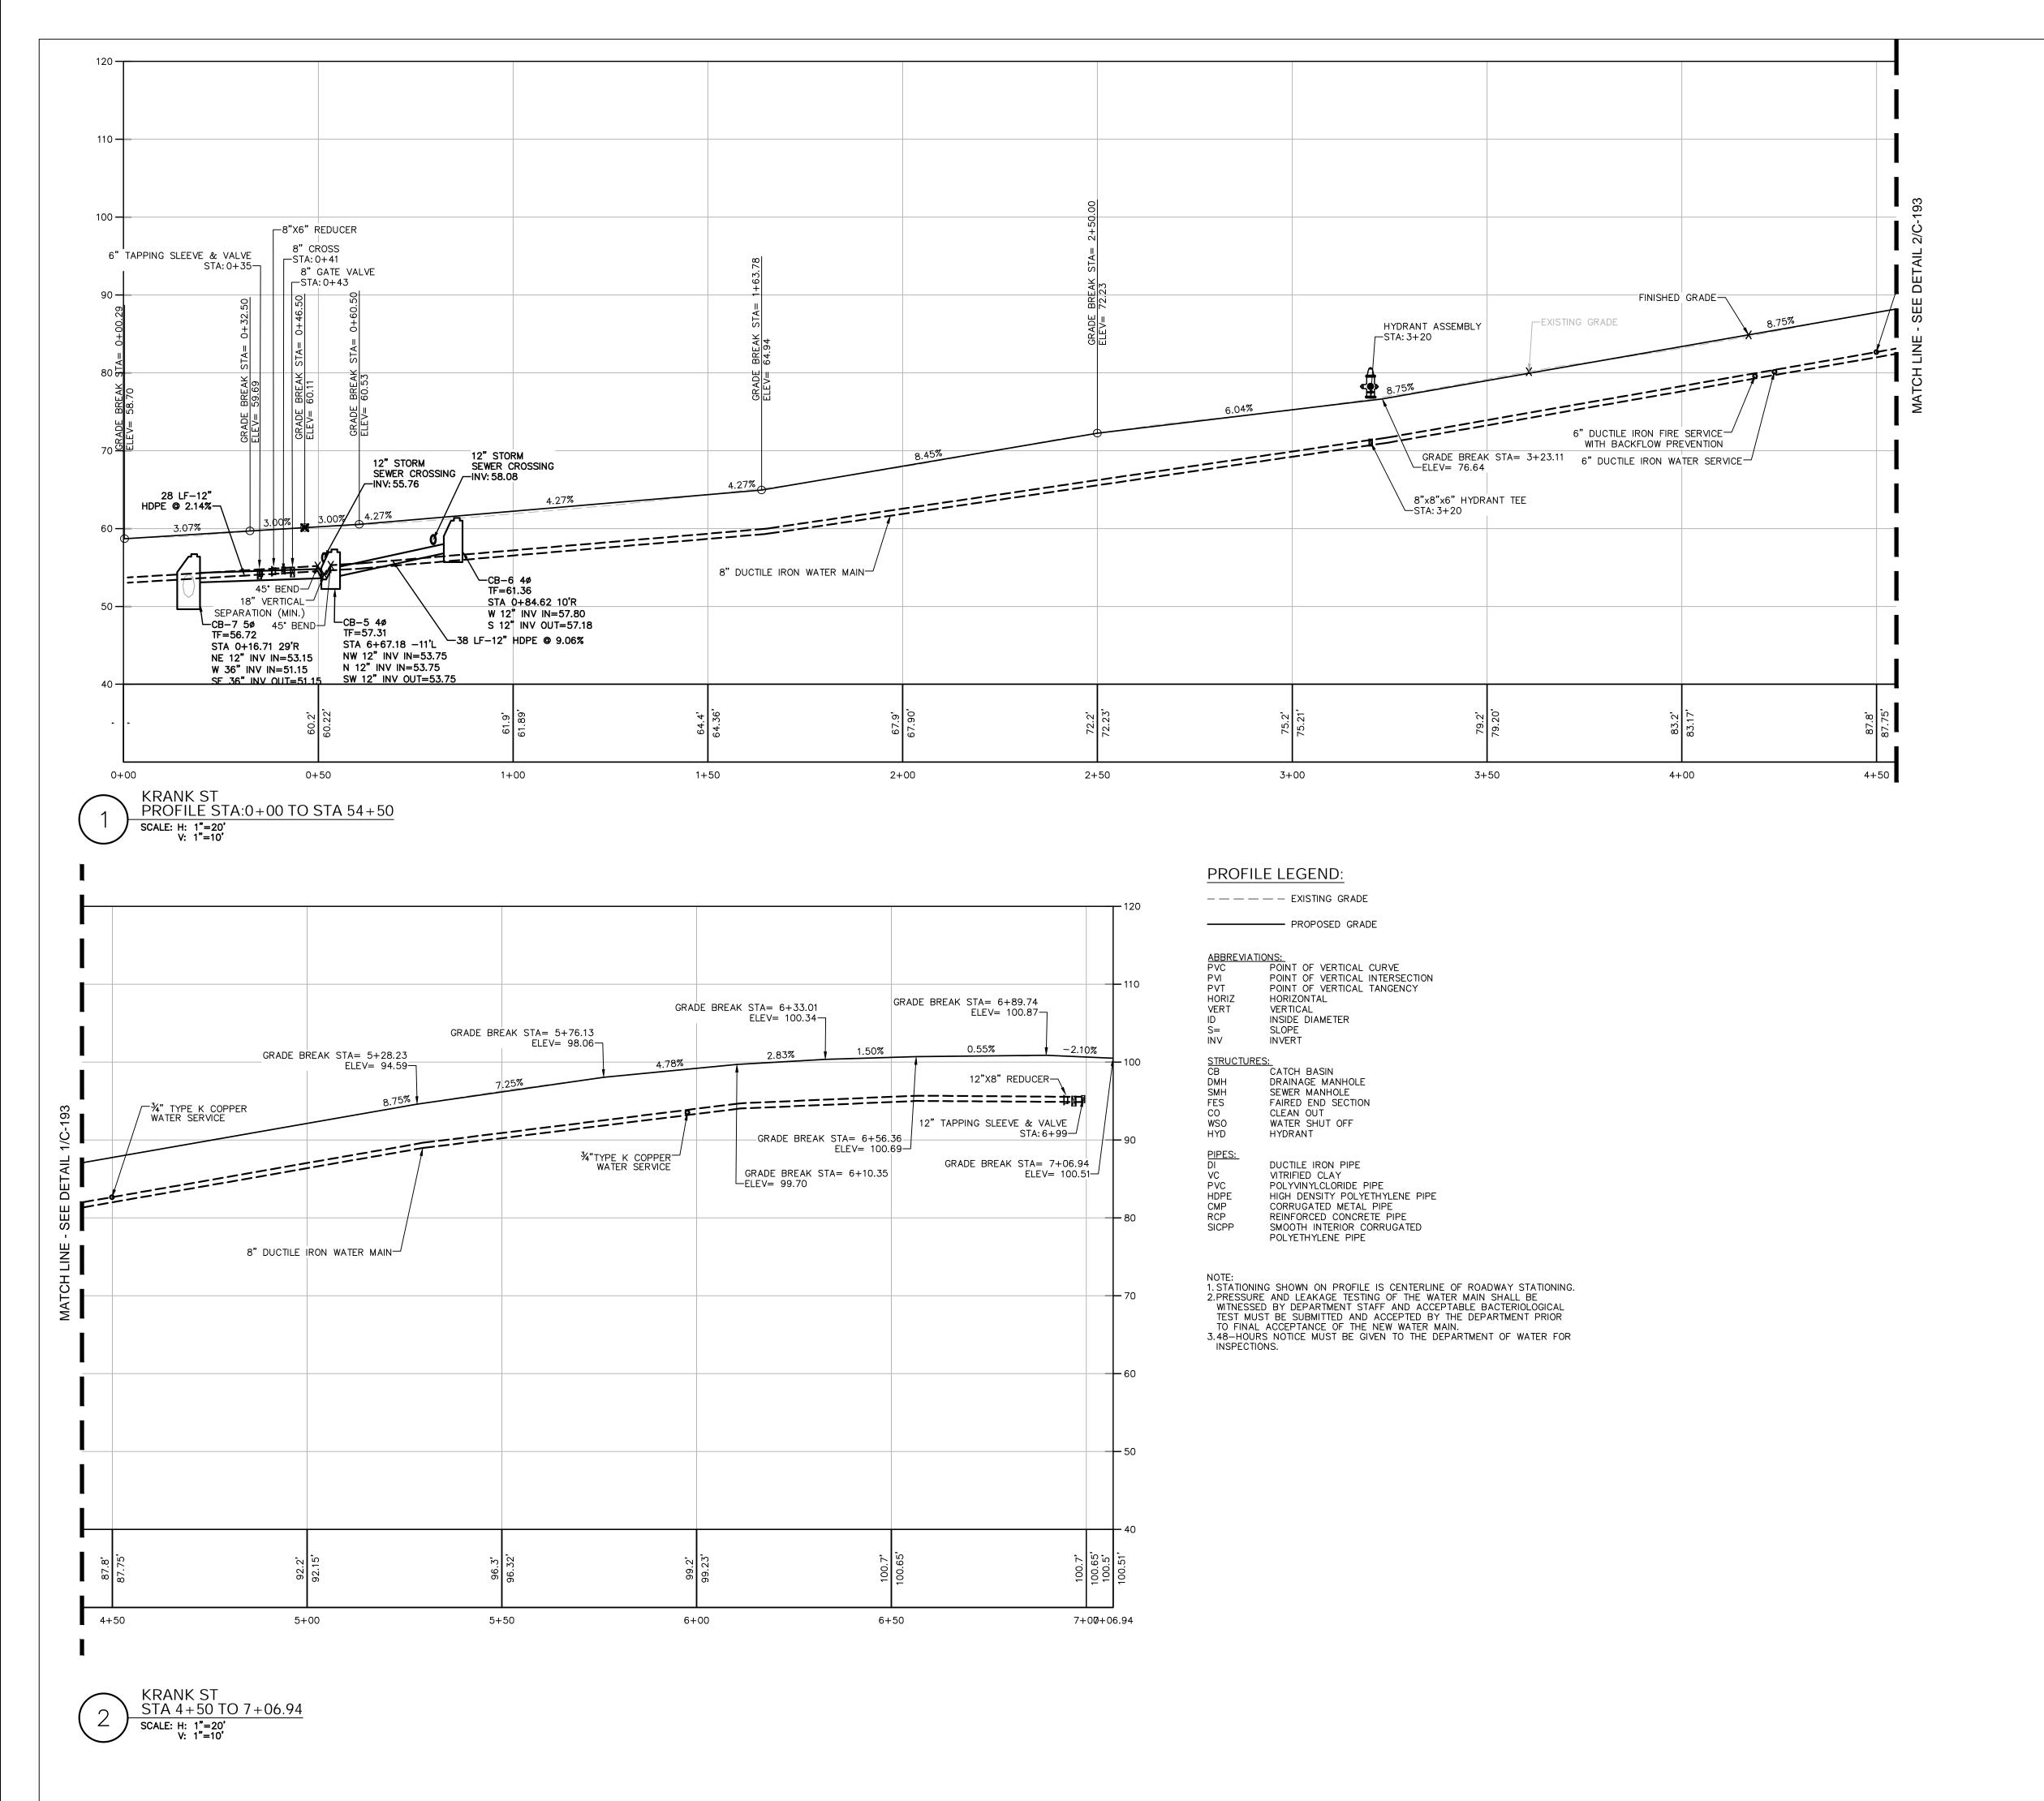
DOB Scan:

Drawing Title:

LEONARD ST & SEYMOUR ST PROFILE

Drawing Number: C-193

-130



THE SEVENTY-SIX

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Civil Engineer: The Chazen Companies 547 River St, Troy, NY 12180 p (518) 273-0055 Chazen Project No. 32019.00

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Project No: 2005
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Checked by: RK

Seal & Signature:



DOB Stamp & Signature


DOB Scan:

Drawing Title:

**KRANK ST PROFILE** 

Drawing Number:

C-194

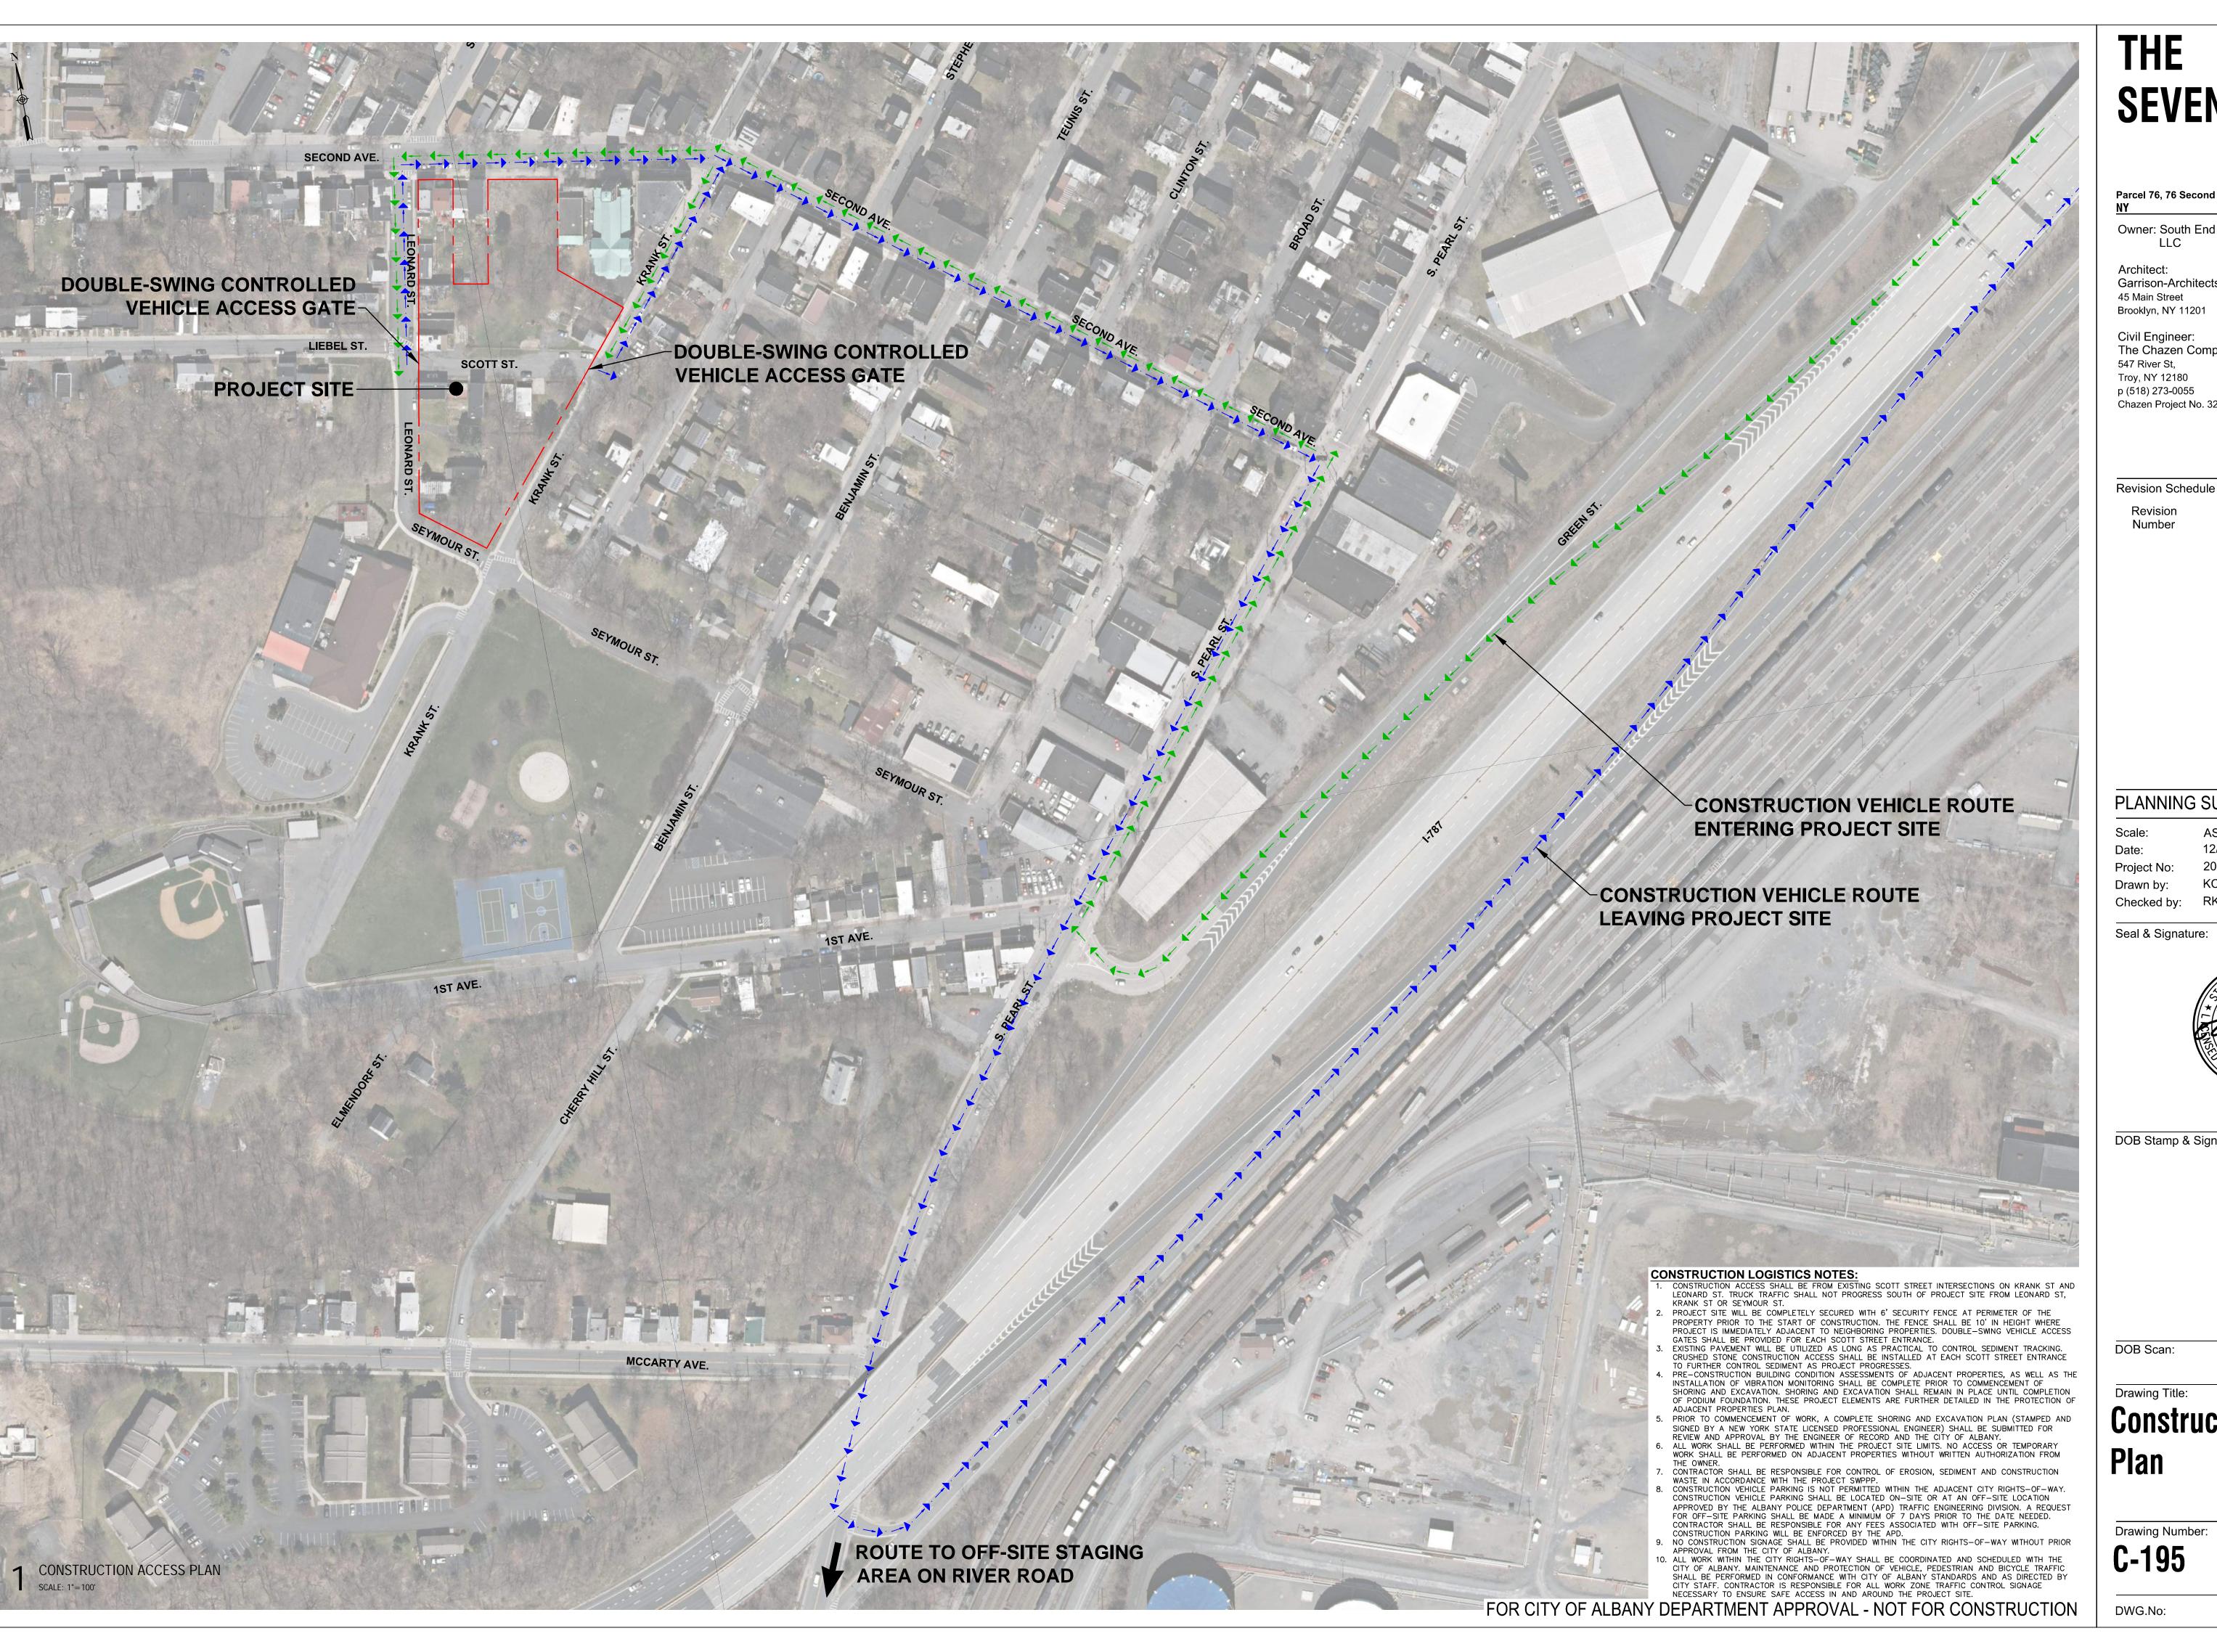

# SEVENTY-SIX

Parcel 76, 76 Second Avenue, City of Albany,

Owner: South End Development LLC

**Garrison-Architects** 

Civil Engineer: The Chazen Companies p (518) 273-0055 Chazen Project No. 32019.00


## PLANNING SUBMISSION SET

AS NOTED 12/8/2020



DOB Stamp & Signature


# **Construction Access**

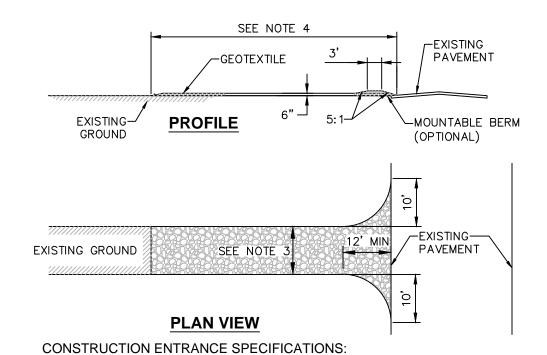

**CONSTRUCTION ENTRANCE SPECIFICATIONS:** . STONE SIZE - USE 2" STONE, OR RECLAIMED OR RECYCLED

- CONCRETE EQUIVALENT. 2. THICKNESS - NOT LESS THAN SIX (6) INCHES. 3. WIDTH - TWELVE (12) FOOT MINIMUM, BUT NOT LESS THAN THE FULL WIDTH AT POINTS WHERE INGRESS OR EGRESS OCCURS. TWENTY FOUR (24) FEET IF SINGLE ENTRANCE TO SITE.
- LOT WHERE A 30' MINIMUM LENGTH WOULD APPLY). 5. GEOTEXTILE - WILL BE PLACED OVER THE ENTIRE AREA PRIOR TO PLACING OF STONE 6. SURFACE WATER - ALL SURFACE WATER FLOWING OR DIVERTED
- 5:1 SLOPES WILL BE PERMITTED. 7. MAINTENANCE - THE ENTRANCE SHALL BE MAINTAINED IN A CONDITION WHICH WILL PREVENT TRACKING OR FLOWING OF SEDIMENT ONTO PUBLIC RIGHTS-OF-WAY. THIS MAY REQUIRE PERIODIC TOP DRESSING WITH ADDITIONAL STONE AS CONDITIONS DEMAND AND REPAIR AND/OR CLEANOUT OF ANY MEASURES USED TO TRAP SEDIMENT. ALL SEDIMENT SPILLED, DROPPED,
- WASHED OR TRACKED ONTO PUBLIC RIGHTS-OF-WAY MUST BE REMOVED IMMEDIATELY. 8. WASHING - WHEELS SHALL BE CLEANED TO REMOVE SEDIMENT PRIOR TO ENTRANCE ONTO PUBLIC RIGHTS-OF-WAY. WHEN WASHING IS REQUIRED, IT SHALL BE DONE ON AN AREA
- SEDIMENT TRAPPING DEVICE. 9. PERIODIC INSPECTION AND NEEDED MAINTENANCE SHALL BE PROVIDED AFTER EACH RAIN.



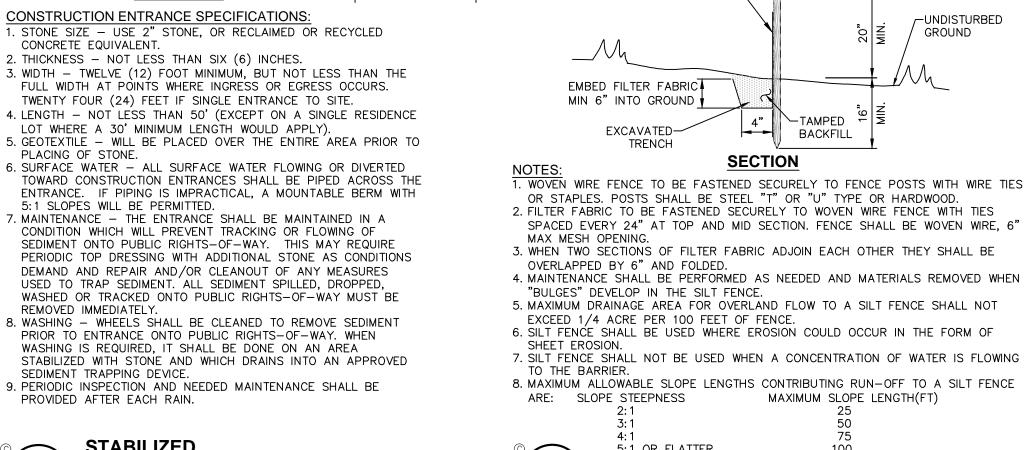

SCALE: NOT TO SCALE

SILT FENCE INSTALLATION DETAIL

MIRAFI 100X PREFABRICATED-


SILT FENCE WITH POSTS OR

APPROVED EQUIVALENT

10'MAX CENTER TO CENTER

PERSPECTIVE VIEW

-36" MIN FENCE POST

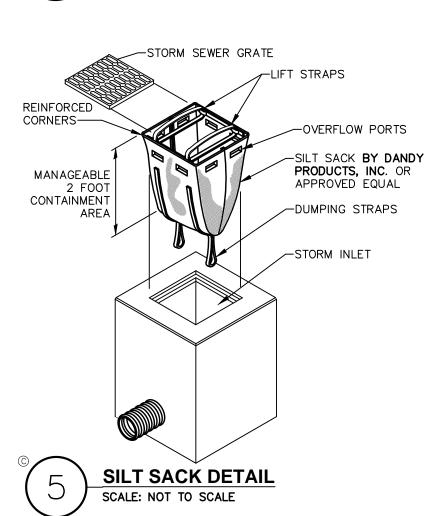

2. MAXIMUM SLOPE OF STOCKPILE SHALL BE 1V: 2H.

4. SEE SPECIFICATIONS FOR INSTALLATION OF SILT FENCE.

MIN.

SLOPE


2 SILT-C500 FENCE

SLOPE

AND STABLE.

VEGETATION OR COVERED

SCALE: NOT TO SCALE

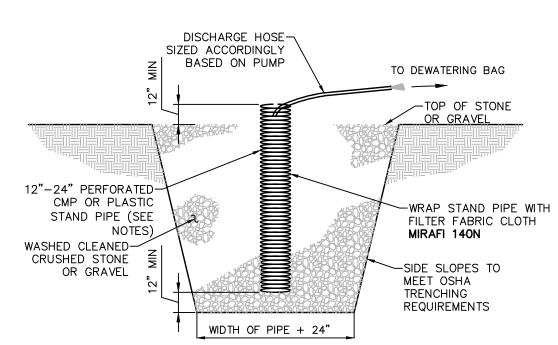

### TYPICAL SECTION OF SUMP PIT

1. SUMP PIT QUANTITY & LOCATION SHALL BE DETERMINED BY CONTRACTOR. 2. PERFORATIONS IN THE STANDPIPE SHALL BE EITHER CIRCULAR OR SLOTS. PERFORATION SIZE SHALL NOT EXCEED 1/2" INCH DIAMETER. PUMP RATE SHALL NOT EXCEED INFLOW RATE INTO STAND PIPE. 3. CRUSHED STONE OR GRAVEL SHALL BE NYSDOT #2 SIZE OR EQUIVALENT AND SHALL BE WASHED PRIOR TO PLACEMENT WITHIN SUMP.


4. DISCHARGE SHALL BE THROUGH DEWATERING BAGS, OR AS DIRECTED BY 5. CONTRACTOR TO SUBMIT DEWATERING PLAN TO ENGINEER FOR REVIEW &



APPROVAL.

**DEWATERING & SUMP PIT DETAIL** SCALE: NOT TO SCALE

ALL SEDIMENT.

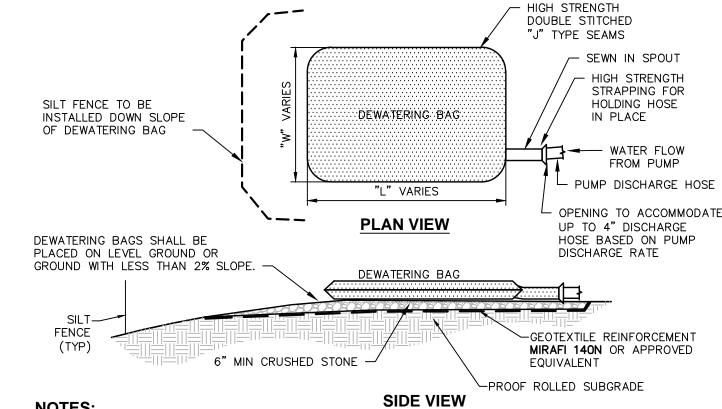

-WOVEN WIRE FENCE (MIN. 14

GAUGE W/ MAX. 6" MESH SPACING)

36" MIN FENCE

POSTS, DRIVEN

MIN 16" INTO

GROUND

SEDIMENT COLLECTION BAG SHALL BE EQUAL TO DIRTBAG® 55, AS MARKETED BY ACF ENVIRONMENTAL.


RICHMOND. VIRGINIA (800-448-3636). OR APPROVED EQUIVALENT. 2. SEDIMENT COLLECTION BAG SHALL BÉ A NONWOVEN BAG SEWN WITH HIGH STRENGTH THREAD. THE SEAMS SHALL BE HIGH STRENGTH, DOUBLE STITCHED, "J" TYPE SEAMS.

3. BAGS SHALL HAVE SEWN IN FILL SPOUT LARGE ENOUGH TO ACCOMMODATE UP TO A 4" DISCHARGE HOSE.

FILL SPOUT SHALL HAVE HIGH STRENGTH STRAPPING TO HOLD HOSE IN PLACE AND PREVENT PUMPED


- WATER FROM ESCAPING WITHOUT BEING FILTERED. 4. SEDIMENT COLLECTION BAGS SHALL BE INSTALLED IN ACCORDANCE WITH THE MANUFACTURERS INSTRUCTIONS, OR AS DIRECTED BY THE ENGINEER.
- SEDIMENT COLLECTED SHALL BE DISPOSED OF AT AN APPROPRIATE FACILITY. SEDIMENT COLLECTION BAGS SHALL BE REMOVED AND REPLACED UNDER ANY OF THE FOLLOWING · WHEN BAGS ARE FULL.
- WHEN BAGS HAVE BEEN IN PLACE FOR MORE THAN 30 DAYS (REMOVAL REQUIRED DUE TO ULTRAVIOLET DETERIORATION). WHEN BAGS ARE DAMAGED.
- 4. ALL SEDIMENT COLLECTION BAGS SHALL BE INSPECTED DAILY BY THE CONTRACTOR. 5. CARE SHALL BE TAKEN DURING REMOVAL TO MINIMIZE LOSS OF ENTRAPPED SEDIMENT.



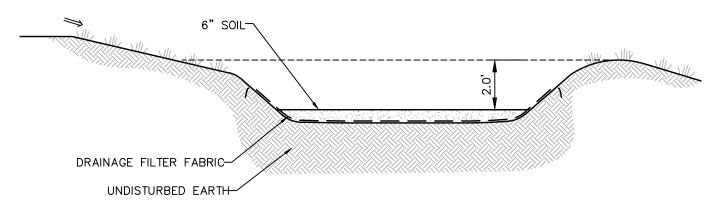

. CONTRACTOR TO EXCAVATE A 2.5-FT DEEP DEPRESSION, APPLY DRAINAGE FILTER FABRIC, AND PLACE 6" OF SOIL MEDIA ABOVE FABRIC TO SECURE IN PLACE. REMOVE SEDIMENT WHEN DEPTH OF SEDIMENT REACHES 1-FT. 3. ONCE UPHILL AREAS HAVE BEEN STABILIZED, THE CONTRACTOR SHALL REMOVE AND DISPOSE OF



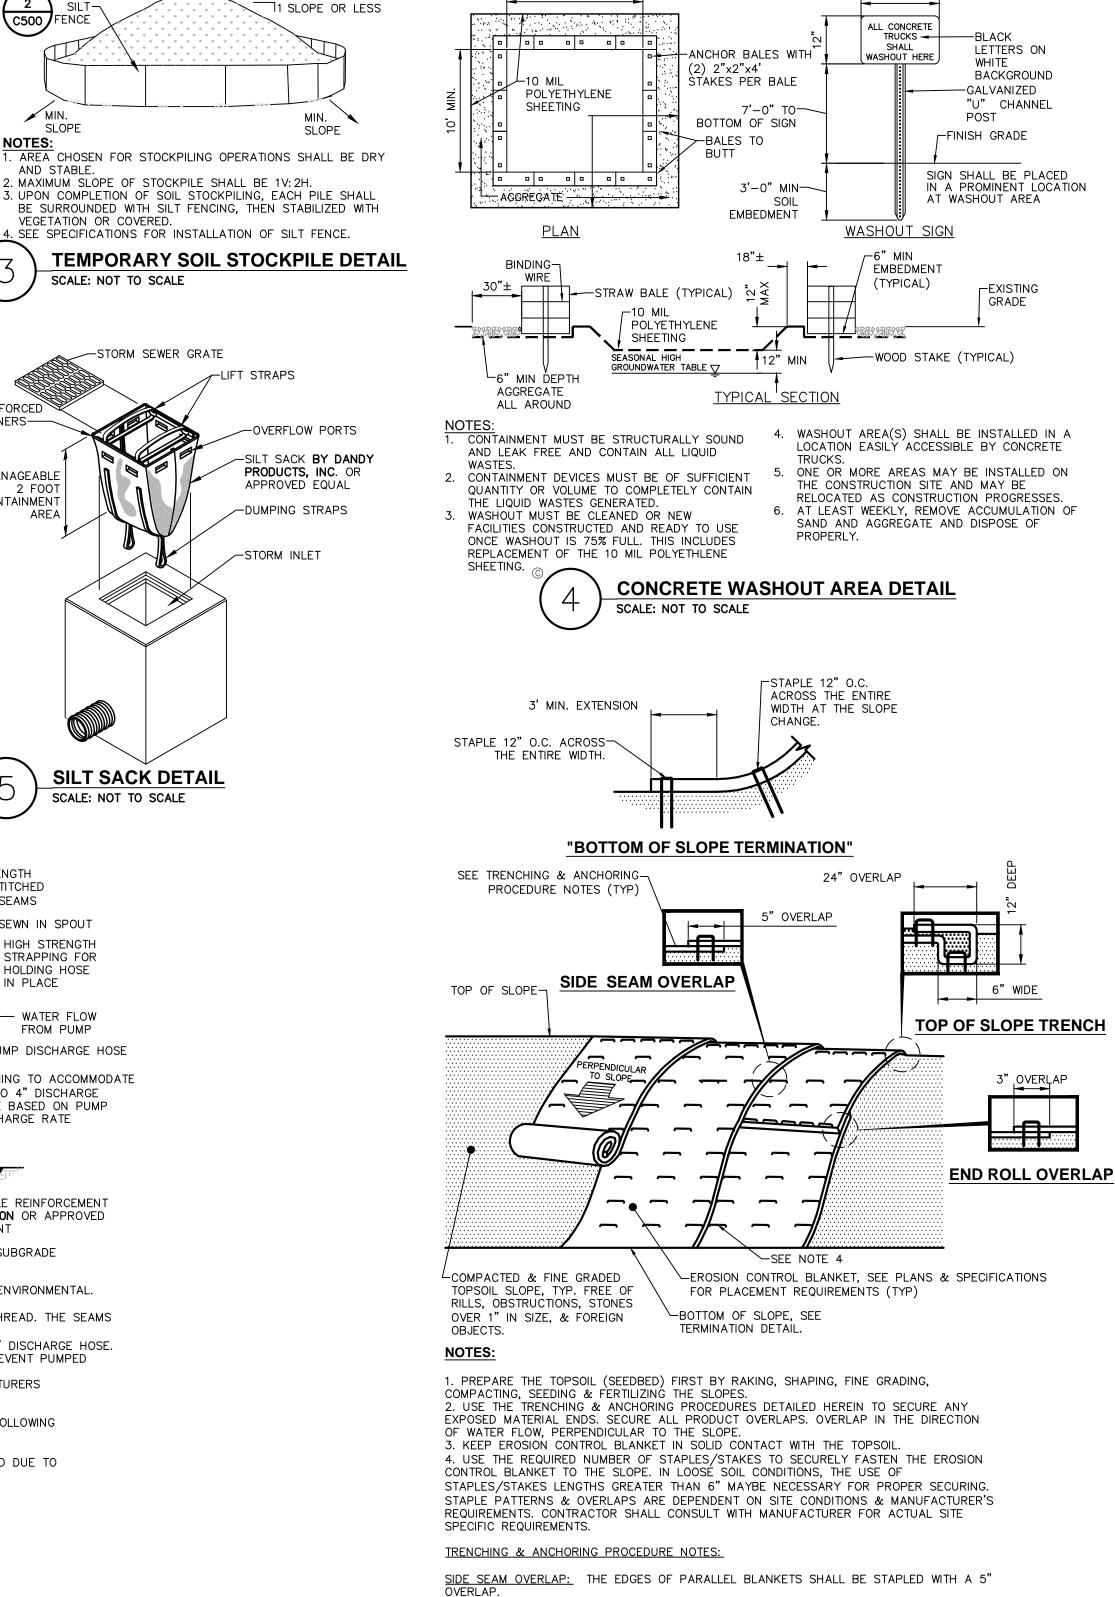

TOP OF SLOPE TRENCH: BEGIN AT THE TOP OF SLOPE BY ANCHORING THE EROSION CONTROL BLANKET IN A 6"D x 6"W TRENCH WITH A 12" OVERLAP EXTENDED BEYOND THE UP-SLOPE PORTION OF THE TRENCH. ANCHOR WITH A ROW OF STAPLES/STAKES 12" O.C. IN THE BOTTOM OF THE TRENCH. BACKFILL & COMPACT THE TRENCH AFTER STAPLING. APPLY SEED TO THE COMPACTED SOIL & FOLD THE REMAINING 12" PORTION OF THE EROSION CONTROL BLANKET BACK OVER THE SEED & COMPACTED SOIL. SECURE THE EROSION CONTROL BLANKET OVER THE COMPACTED SOIL WITH A ROW OF STAPLES/STAKES SPACED 12" O.C. ACROSS THE ENTIRE WIDTH.

END ROLL OVERLAP: CONSECUTIVE BLANKETS SPLICED DOWN THE SLOPE SHALL BE PLACED END OVER END (SHINGLE-STYLE) WITH A 3" OVERLAP. STAPLE THRU OVERLAPPED AREAS, 12" APART ACROSS THE ENTIRE WIDTH.

**EROSION CONTROL BLANKET INSTALLATION DETAIL** SCALE: NTS

# THE **SEVENTY-SIX**

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**AS NOTED** 12/8/2020 Date: Project No: KC/SM Drawn by: Checked by:

Seal & Signature:



DOB Stamp & Signature

DOB Scan:

**Drawing Title:** 


## **Erosion & Sediment Control Details**


**Drawing Number:** 

**C-500** 

DWG.No:

FOR CITY OF ALBANY DEPARTMENT APPROVAL - NOT FOR CONSTRUCTION

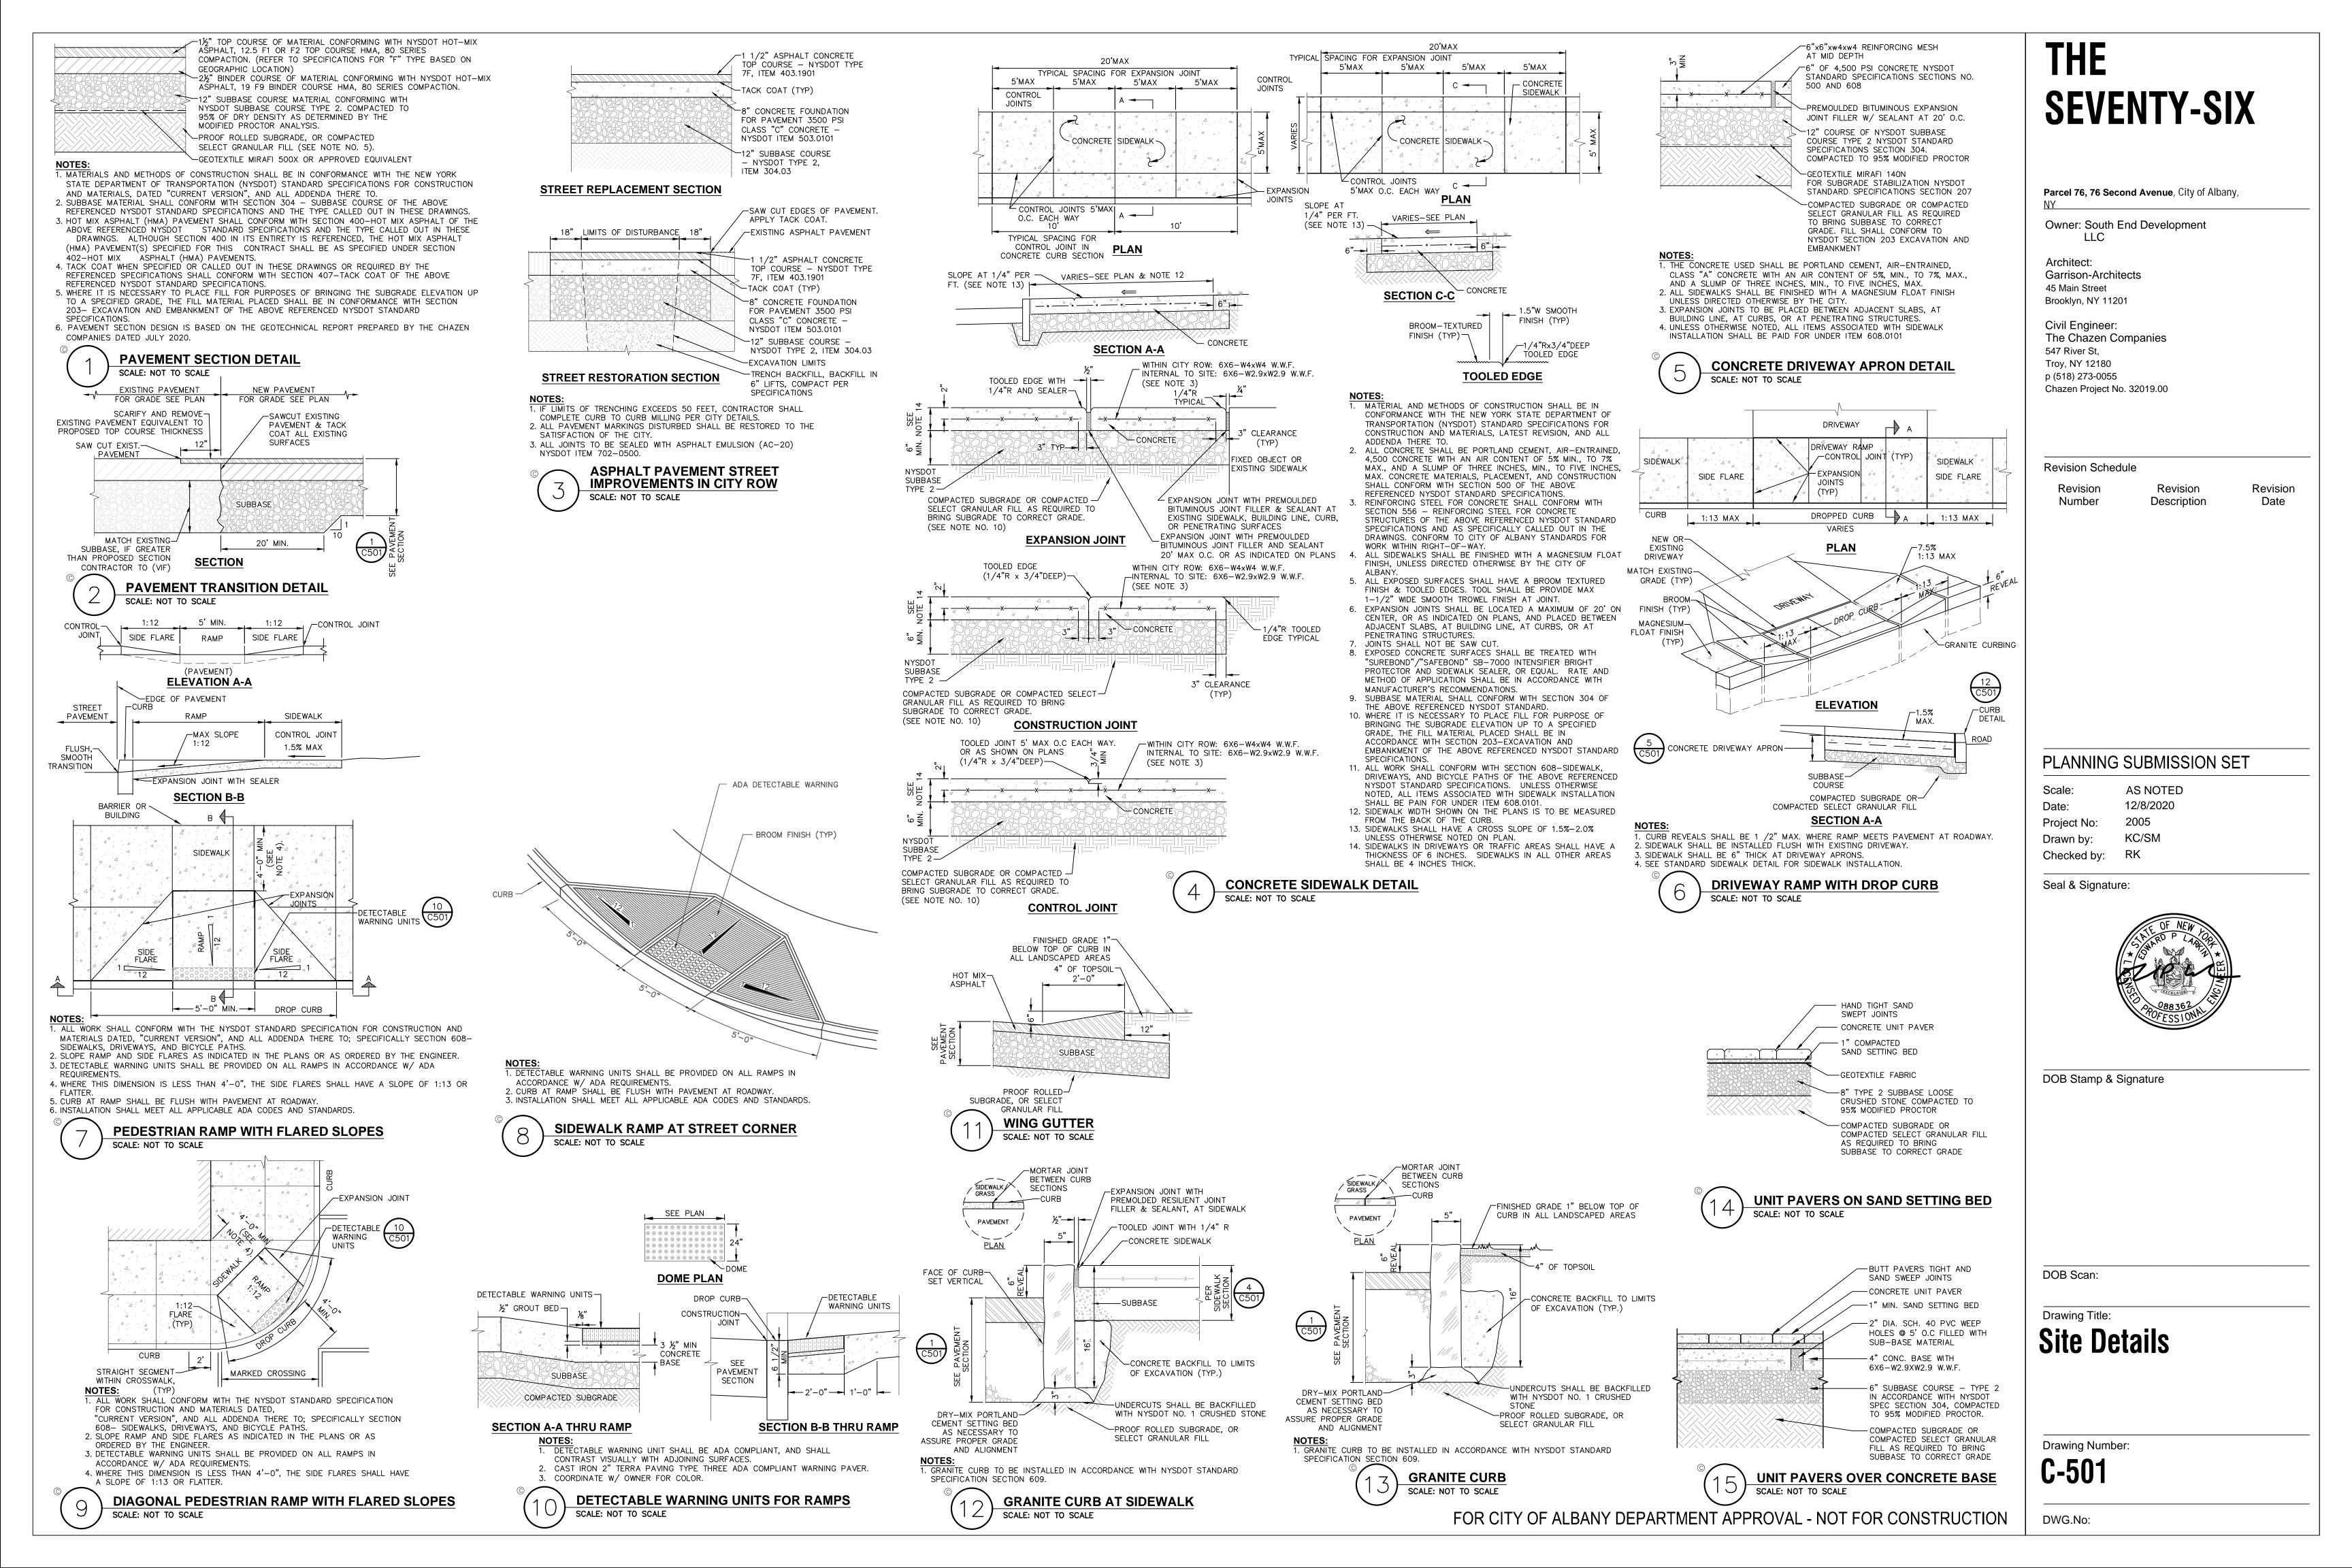

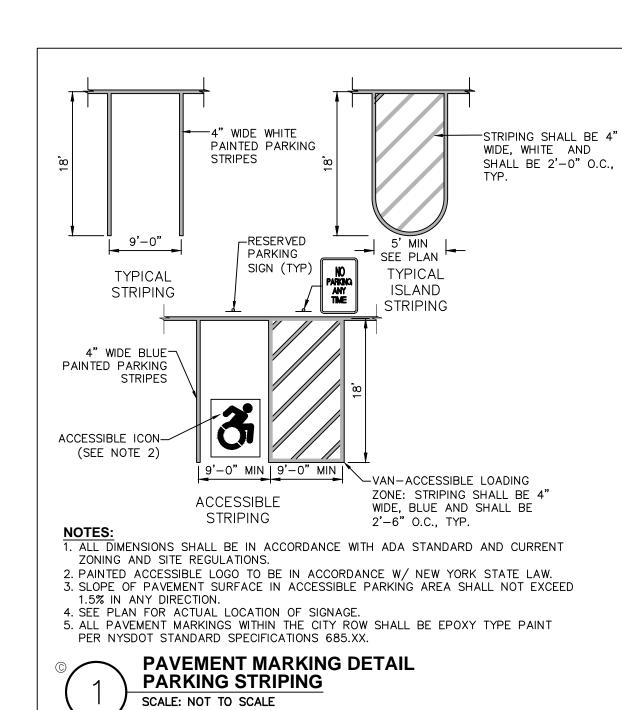

ALL STRIPING SHALL CONFORM TO THE LATEST EDITION OF THE NYSDOT STANDARD SPECIFICATIONS, SECTION 640 AND THE

2009 EDITION AND THE "NYS SUPPLEMENT." 2. STRIPE PAVEMENT AS INDICATED ON THE PLANS AND/OR IN ACCORDANCE WITH ALL APPLICABLE LOCAL, STATE AND FEDERAL

"NATIONAL MANUAL ON UNIFORM TRAFFIC CONTROL DEVICES" -

REQUIREMENTS. 3. STRIPING WORK WILL BE REVIEWED AND ACCEPTED BY THE

AUTHORITY HAVING JURISDICTION. 4. COLOR: DRIVE LANE DIVIDERS - WHITE OR AOBE NO PARKING ZONE WARNINGS - WHITE OR AOBE PARKING DIVIDERS - WHITE OR AOBE WALKING LINES - WHITE OR AOBE

ACCESSIBLE PARKING LINES & SYMBOL — BLUE


5. ALL PAVEMENT MARKINGS WITHIN THE CITY ROW SHALL BE EPOXY TYPE PAINT PER NYSDOT STANDARD SPECIFICATIONS 685.XX.

SIGNAGE NOTES:


1. ALL SIGNS SHALL CONFORM TO THE LATEST EDITION OF THE NYSDOT STANDARD SPECIFICATIONS, SECTION 645 AND THE "NATIONAL MANUAL ON UNIFORM TRAFFIC CONTROL DEVICES" -2009 EDITION AND THE "NYS SUPPLEMEN"

2. SIGN MOUNTING HEIGHT SHALL BE A MINIMUM OF 7'. MINIMUM MOUNTING HEIGHT MAY BE ADJUSTED ONLY IN ACCORDANCE WITH PROVISIONS OUTLINED IN THE "NATIONAL MANUAL ON UNIFORM TRAFFIC CONTROL DEVICES" - 2009 EDITION AND THE "NYS

3. SIGN POST SHALL BE IN ACCORDANCE W/ NYSDOT STANDARD SPECS SECTION 730.

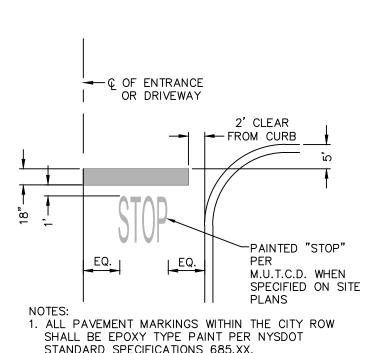


STANDARD SPECIFICATIONS 685.XX. **PAVEMENT MARKING DETAIL STOP BAR** 

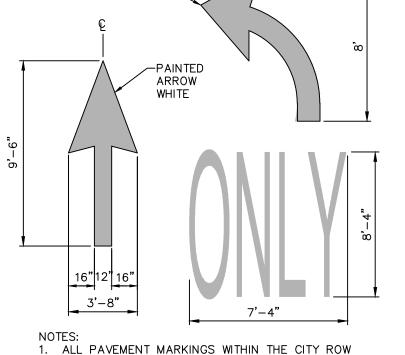


PAINTED ARROW-

SHALL BE EPOXY TYPE PAINT PER NYSDOT STANDARD SPECIFICATIONS 685.XX. **PAVEMENT MARKING DETAIL DIRECTIONAL ARROW** SCALE: NOT TO SCALE

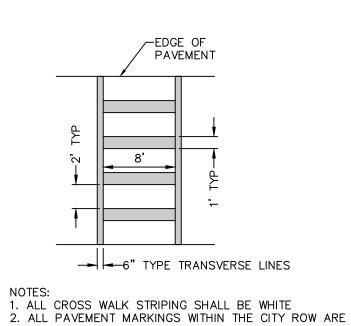


TO BE EPOXY TYPE PAINT NYSDOT ITEM 685.XX. PAVEMENT MARKING DETAIL

**CROSS WALK STRIPING** SCALE: NOT TO SCALE

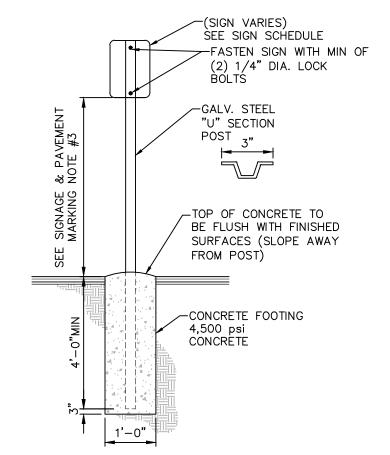


SCALE: NOT TO SCALE

SINGLE POST SIGN MOUNTING IN CONCRETE SCALE: NOT TO SCALE

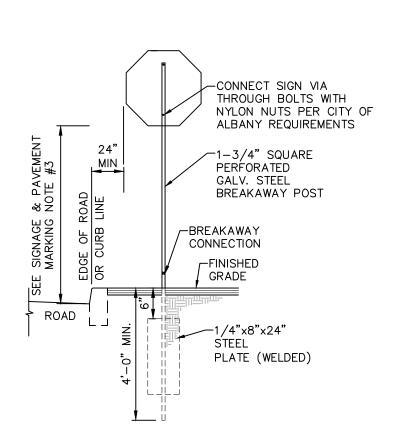

SINGLE POST SIGN MOUNTING IN CITY RIGHT-OF-WAY SCALE: NOT TO SCALE

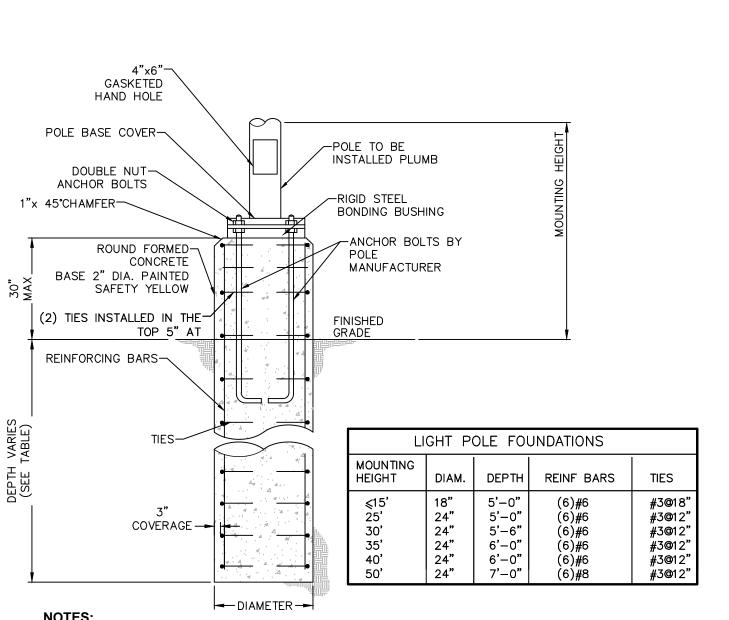


NOTES:


1. CONDUITS AND GROUNDING SHALL BE AS REQUIRED BY THE ELECTRICAL DESIGN. ALL CONCRETE SHALL BE 4,500 PSI @ 28 DAYS.

ALL REINFORCING STEEL SHALL BE GRADE 60. . DESIGNED FOR 90 MPH WIND WITH FIXTURE AREA OF 13 SF.

5. FOUNDATION DIAMETER AND REINFORCING CIRCLE SHALL BE COORDINATED WITH ANCHOR

6. FOUNDATIONS SHALL BE AUGERED INTO UNDISTURBED NATURAL SOIL OR COMPACTED FILL PER SITE GRADING PLANS.

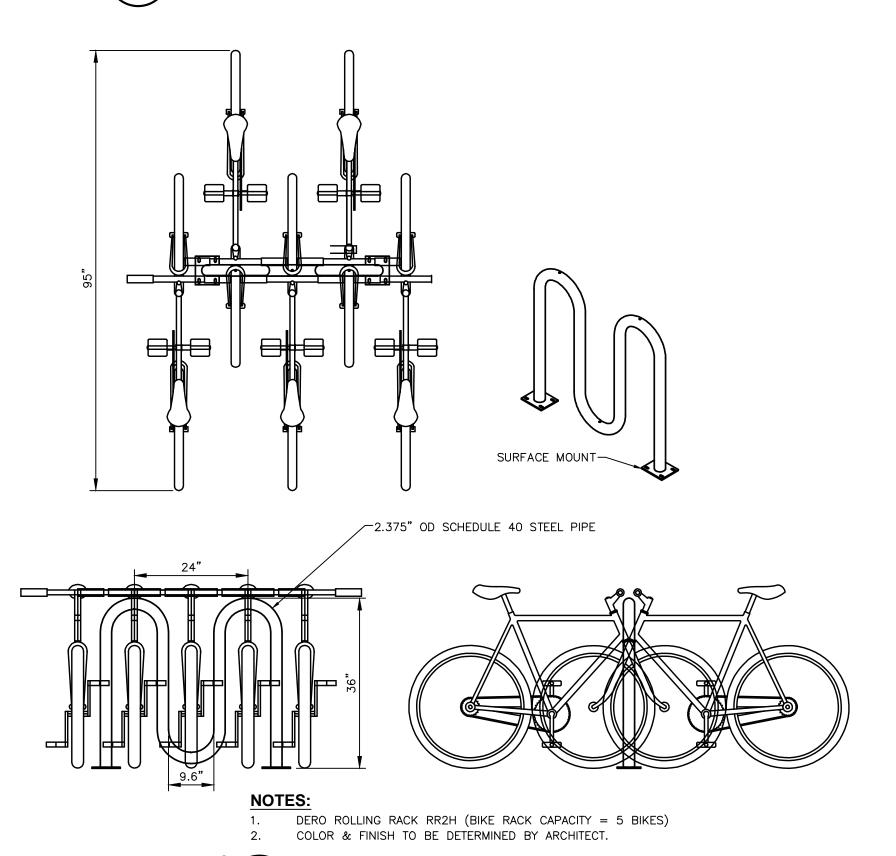

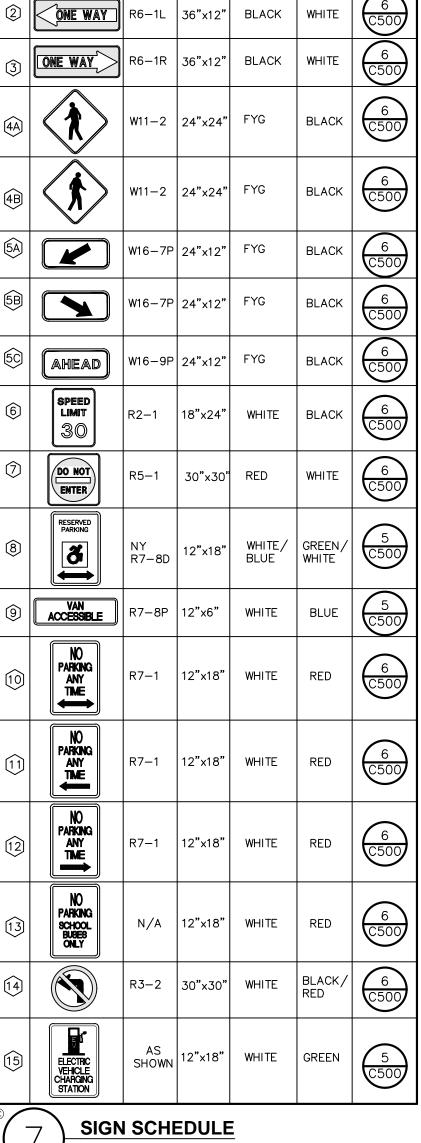


MUTCD MIN COLORS
NUMBER SIZE BCK GRND LEGEND MOUNTING

RED

30"x30"


SCALE: NOT TO SCALE

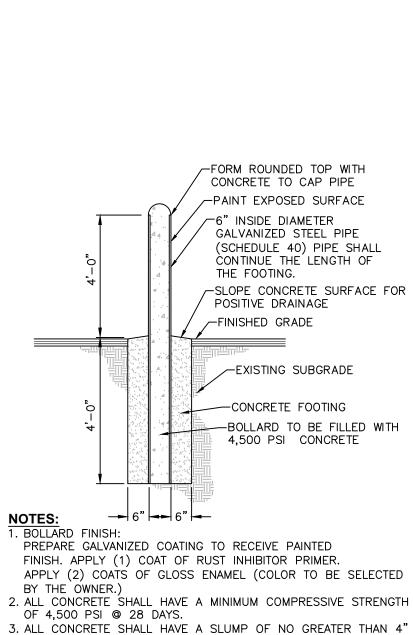

APPLY (2) COATS OF GLOSS ENAMEL (COLOR TO BE SELECTED

3. ALL CONCRETE SHALL HAVE A SLUMP OF NO GREATER THAN 4" (WITH A TOLERANCE OF 1"). 4. ALL CONCRETE SHALL HAVE A 5% ENTRAINED AIR (WITH A

TOLERANCE OF 1%) CONFORMING WITH ASTM C260. STEEL & CONCRETE BOLLARD DETAIL

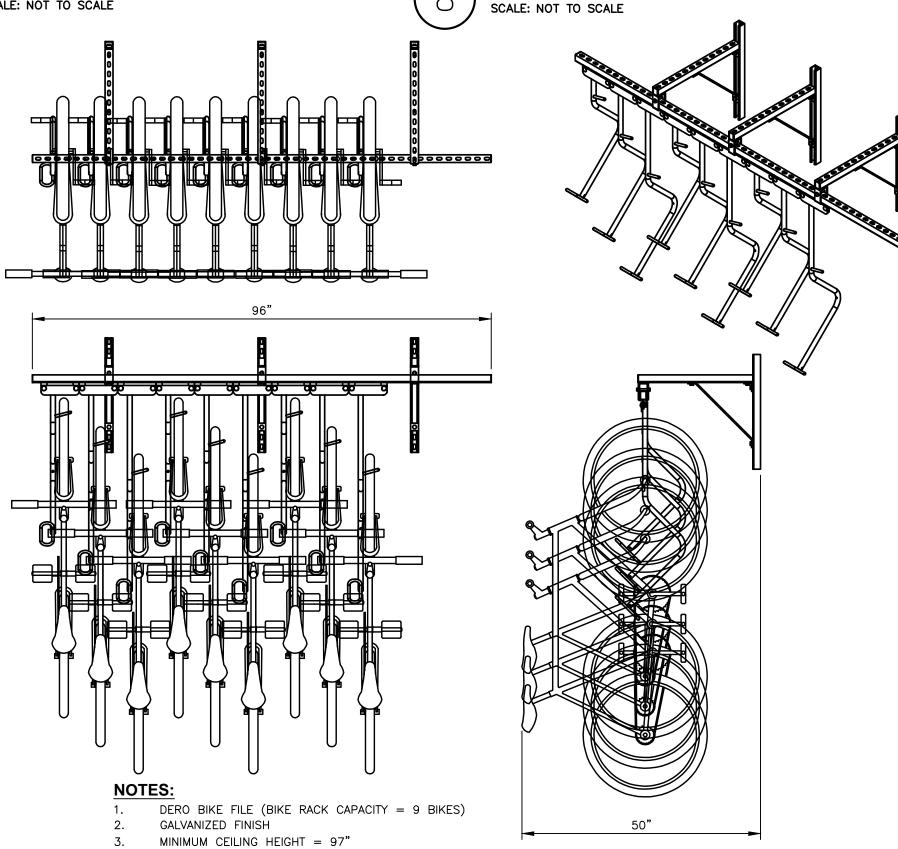

**WALL-MOUNTED BIKE RACK** 

FOR CITY OF ALBANY DEPARTMENT APPROVAL - NOT FOR CONSTRUCTION

## THE SEVENTY-SIX

Parcel 76, 76 Second Avenue, City of Albany,

Owner: South End Development LLC

Architect: Garrison-Architects 45 Main Street Brooklyn, NY 11201

Civil Engineer: The Chazen Companies 547 River St, Troy, NY 12180 p (518) 273-0055 Chazen Project No. 32019.00

**Revision Schedule** 

Revision Number

Revision Description Revision Date

PLANNING SUBMISSION SET

Scale: AS NOTED 12/8/2020 Date: Project No: KC/SM Drawn by:

Seal & Signature:

Checked by:



DOB Stamp & Signature

DOB Scan:

Drawing Title:

**Site Details** 


Drawing Number:

**C-502** 

DWG.No:

SITE LIGHTING CONCRETE BASE SCALE: NOT TO SCALE

SURFACE-MOUNTED BIKE RACK SCALE: NOT TO SCALE

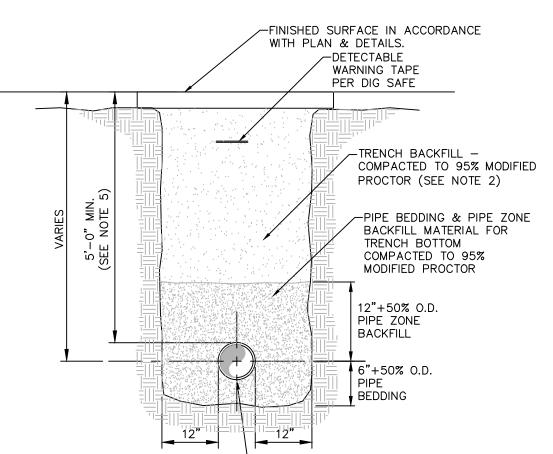

PIPE TYPE & SIZE VARIES. SEE PLAN

NOTES:

1. PIPE BEDDING & PIPE ZONE BACKFILL SHALL BE A NATURAL RUN-OF-BANK (R.O.B.) SAND OR A MIXTURE OF CRUSHED STONE AND GRAVEL, FREE OF SOFT, NONDURABLE PARTICLES, ORGANIC MATERIALS AND ELONGATED PARTICLES, AND SHALL BE WELL GRADED FROM FINE TO COARSE PARTICLES. BEDDING GRADATIONS SHALL BE APPROVED BY THE ENGINEER AND SHALL MEET THE FOLLOWING GRADATION REQUIREMENTS:

 SIEVE DESIGNATION
 % PASSING

 3/4"
 100%

 NO. 40
 0-70%

2. TRENCH BACKFILL SHALL BE A NATURAL RUN-OF-BANK (R.O.B.) OR PROCESSED GRAVEL, OR EXCAVATED MATERIAL FREE OF SOFT, NONDURABLE PARTICLES, ORGANIC MATERIALS AND ELONGATED PARTICLES, AND SHALL BE WELL GRADED FROM FINE TO COARSE PARTICLES. TRENCH BACKFILL GRADATIONS SHALL BE APPROVED BY THE ENGINEER AND SHALL MEET THE FOLLOWING GRADATION REQUIREMENTS:

 SIEVE DESIGNATION
 % PASSING

 4"
 100%

 NO. 40
 0-70%

 NO. 200
 0.10%

IN NON-TRAFFIC UNPAVED AREAS TRENCH BACKFILL CAN BE MATERIALS EXCAVATED FROM THE TRENCH AS APPROVED BY THE ENGINEER AND

COMPACTED TO 90% MODIFIED PROCTOR.

3. INSTALL CONTINUOUS DETECTABLE MARKING TAPE DURING BACKFILLING OF TRENCH FOR UNDERGROUND PIPING. LOCATE TAPE 12" BELOW FINISHED GRADE, DIRECTLY OVER PIPING, EXCEPT 6" BELOW SUBGRADE UNDER PAVEMENTS &

4. TRENCHING SHALL BE IMPLEMENTED IN ACCORDANCE WITH O.S.H.A. STANDARDS. 5. 5'-0" MIN COVER SHALL BE APPLIED TO WATER MAIN OR SANITARY SEWER FORCE MAINS ONLY.

-SLOPE & WARP
PAVEMENT TO MATCH

GRATE TOP OF FRAME

LINE

\_GUTER LINE

BEYOND

-CONCRETE

STRUCTURE

/-WING GUTTER

∠CONCRETE

STRUCTURE

GUTTER C501

FINISHED GRADE

∠BIT. CONC. PAVEMENT

IN ACCORDANCE WITH

-GRADE ADJUSTMENT

PLANS & DETAILS

VARIES (4" MIN)

BEYOND

STANDARD SLOPE

## PIPE TRENCH DETAIL (TYPICAL) SCALE: NOT TO SCALE

BACK OF-

SLOPE & WARP-

PAVEMENT TO MATCH

AME AND GRATE OF-

TYPE SPECIFIED

**48" ROUND STRUCTURE** 

SCALE: NOT TO SCALE

PLACEMENT AT WING GUTTER


GRATE TOP OF FRAME


C503

FINISHED GRADE

WING GUTTER

GUTTER-

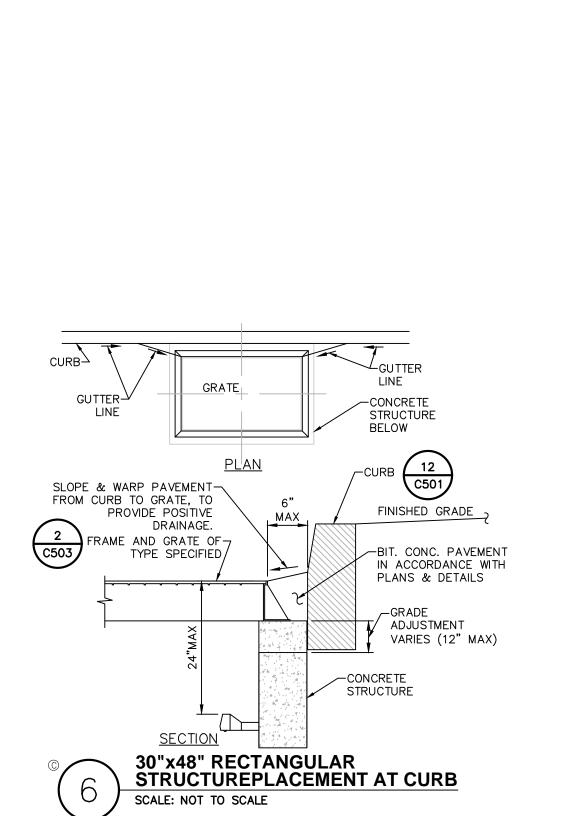

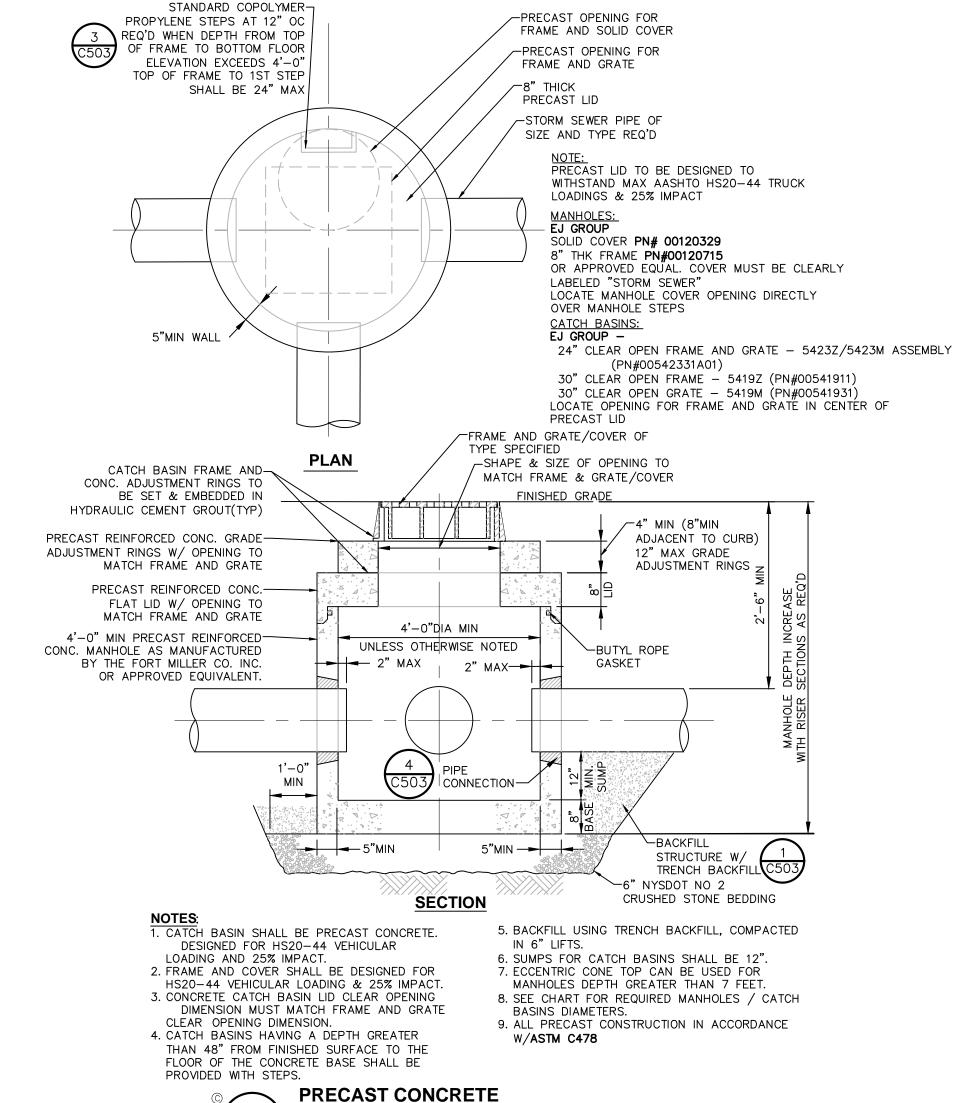

**CATCH BASIN/MANHOLE DETAIL** 

SCALE: NOT TO SCALE

MANUFACTURER NUMBER WIDTH LEG RUNG CLEAR MENT CLEAR

M.A. INDUSTRIES INC\* PS2-PF 14 3/4 9 1/4 13 3/4 3 3/8 5 7/8

M.A. INDUSTRIES INC\* PS2-PFS 14 3/4 8 1/4 13 3/4 3 3/8 4 7/8

\* OR EQUIVALENT

MH STEP DESIGN AND INSTALLATION SHALL COMPLY WITH ALL OSHA REGULATIONS

SEC.

A

SECTION


SECTION

**ACCEPTABLE MANHOLE STEPS** 

© COPOLYMER POLYPROPYLENE MH STEP

SCALE: NOT TO SCALE

NOTE: CAST IN PLACE

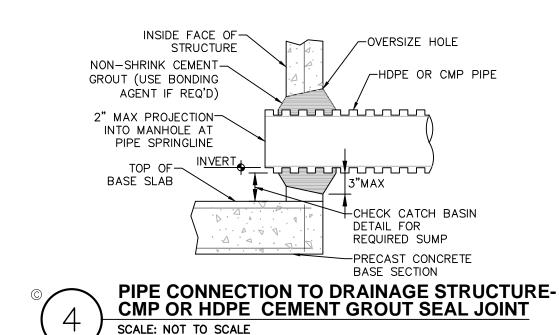

**STORM SEWER NOTES:** 

1. ALL STORM WATER MANAGEMENT STRUCTURES (I.E. CATCH BASIN, ETC.) SHALL BE REGULARLY INSPECTED FOR SEDIMENT ACCUMULATIONS. CATCH BASINS SHALL BE CLEANED WHEN SEDIMENT DEPTH REACHES A MAXIMUM OF 1/2 THE AVAILABLE SUMP DEPTH.

2. IF GROUNDWATER IS ENCOUNTERED DIT (A (A CUMP DIT) TO TRAD AND SUITED WATER FOR

SHALL CONSTRUCT A DEWATERING PIT (A.K.A. SUMP PIT) TO TRAP AND FILTER WATER FOR PUMPING TO A SUITABLE DISCHARGE AREA. THE DEWATERING PIT SHALL BE CONSTRUCTED IN ACCORDANCE WITH THE NEW YORK STATE GUIDELINES FOR URBAN EROSION AND SEDIMENT CONTROL, LATEST EDITION.

SEDIMENT CONTROL, LATEST EDITION.

3. ALL EROSION CONTROL MEASURES EMPLOYED DURING THE CONSTRUCTION PROCESS SHALL BE
AS OUTLINED ON THE EROSION AND SEDIMENT CONTROL PLANS, DETAILS AND NOTES.

### MANHOLES AND OTHER BELOW GRADE STRUCTURES:

1. STRUCTURAL DESIGN FOR MANHOLES AND OTHER BELOW-GRADE PRECAST CONCRETE STRUCTURES:

A. NON-TRAFFIC LOADS:

BELOW GRADE PRECAST CONCRETE STRUCTURES SHALL BE DESIGNED TO WITHSTAND LOADS IMPOSED BY STRUCTURE WEIGHT, EARTH COVER, LATERAL PRESSURE FROM EARTH AND GROUND WATER, AND LIVE LOADS SUCH AS PEDESTRIAN TRAFFIC OR MACHINERY ON OR ABOVE THE STRUCTURE; AND

B. TRAFFIC LOADS:
BELOW GRADE PRECAST CONCRETE STRUCTURES SHALL BE DESIGNED TO ALSO WITHSTAND
TRAFFIC LOADS CREATED BY
AN HS20-44 TRUCK PLUS 25% IMPACT AS DEFINED IN THE LATEST EDITION OF THE
AMERICAN ASSOCIATION OF STATE

HIGHWAY AND TRANSPORTATION OFFICIALS (AASHTO) DESIGN STANDARDS.

2. MATERIAL WHICH SHALL BE UTILIZED IN THE CONSTRUCTION OF PRECAST CONCRETE STRUCTURES:
CEMENT: ASTM C-150, TYPES I,II,III,VI

SAND: NYSDOT STD. SPEC. SECTION NO. 703-0 CONCRETE SAND STONE: NYSDOT STD. SPEC. SECTION NO. 703-02 COARSE AGGREGATE STEEL BAR REINFORCEMENT: ASTM A615, GRADE 60 WIRE MESH REINFORCEMENT: ASTM A185 PLAIN CONCRETE STRENGTH (28 DAY): 4,500 PSI (F'C)

ENTRAINED AIR: 5% MIN.

3. ALL CASTINGS (FRAMES AND COVERS, FRAMES AND GRATES, ETC.) FOR USE IN CONJUNCTION WITH MANHOLES AND OTHER BELOW GRADE STRUCTURES SHALL BE MANUFACTURED FROM GRAY IRON OR DUCTILE IRON. GRAY IRON SHALL CONFORM WITH ASTM A 48, CLASS 30B AND DUCTILE IRON SHALL CONFORM WITH ASTM A 536 AND BE OF A GRADE APPROPRIATE TO ITS INTENDED

USE.

4. ALL CASTINGS (FRAMES AND COVERS, FRAMES AND GRATES, ETC.) FOR USE IN CONJUNCTION WITH MANHOLES AND OTHER BELOW GRADE STRUCTURES SHALL BE DESIGNED TO WITHSTAND AASHTO HS 20-44 HIGHWAY LOADING PLUS 25% IMPACT.

5. ALL ASTM REFERENCES SHALL BE FOR THE LATEST ACTIVE STANDARD.

# THE SEVENTY-SIX

Parcel 76, 76 Second Avenue, City of Albany,

Owner: South End Development

Architect:
Garrison-Architects
45 Main Street
Brooklyn, NY 11201

Civil Engineer: The Chazen Companies 547 River St, Troy, NY 12180 p (518) 273-0055 Chazen Project No. 32019.00

Revision Schedule

Revision Number Revision
Description

Revision Date

### PLANNING SUBMISSION SET

Scale: AS NOTED

Date: 12/8/2020

Project No: 2005

Drawn by: KC/SM

Checked by: RK

Seal & Signature:



DOB Stamp & Signature


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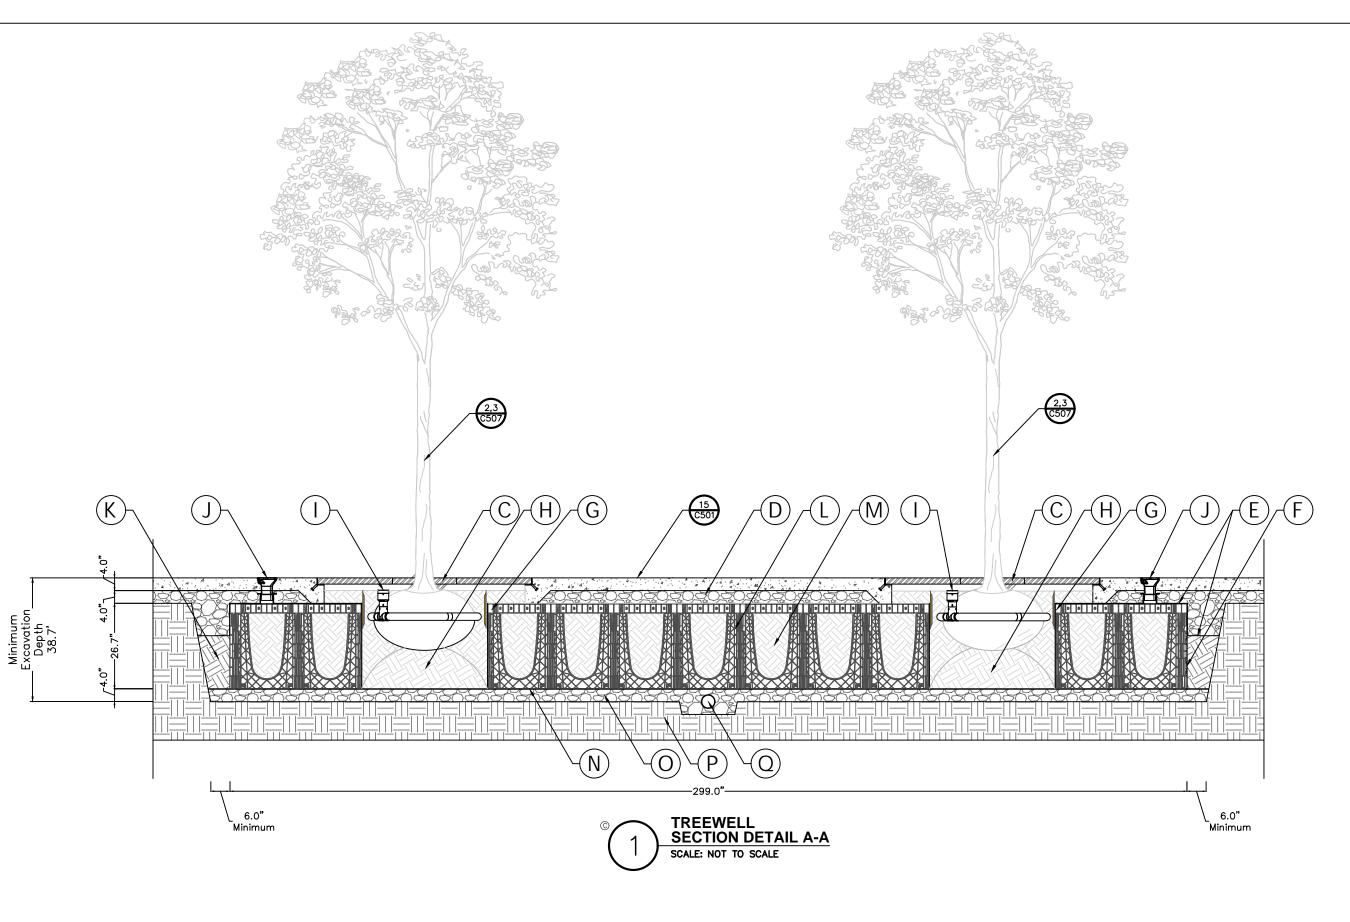
Drawing Title:

**Storm Sewer Details** 

Drawing Number: C-503

\_\_\_\_\_



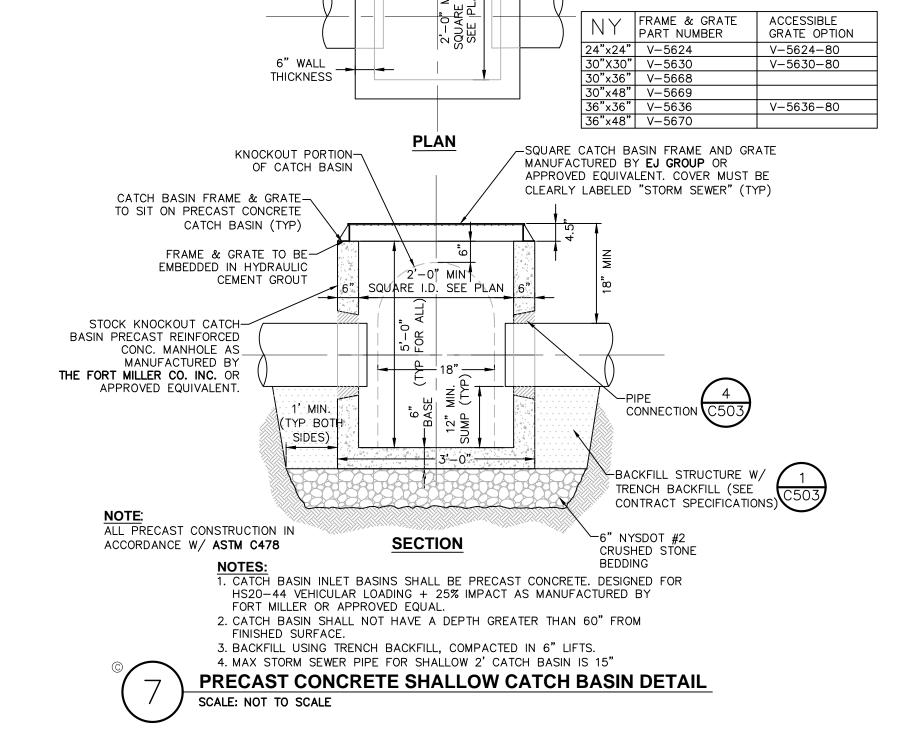

(See details for proper planting depth.)

B. PAVEMENT SURFACE (Per engineers' specifications. Thicken at treepit opening.)

C. TREE GRATE & FRAME (Cast in place frame)

D. GEOCOMPOSITE/GRID (Placed horizontally on top of the soil cells. Fold the geocomposite/grid down the outer edge 10" - 12" and fold it out horizontally 10" - 12". Overlap seams 10" -(GreenBlue Urban — www.greenblue.com)

E. ROOTSTOP™ 600 ROOT BARRIER (Wraps vertically around the soil cells. Seams must overlap 10" - 12" and be sealed with seam tape.) (GreenBlue Urban — www.greenblue.com)

F. REROOT™ 300 ROOT BARRIER (Wraps vertically around the inside of the treepit opening with the ribs facing the tree. seams must overlap 10" — 12" and be sealed with seam tape. (GreenBlue Urban - www.greenblue.com)

G. COMPACTED SOIL ROOTBALL PEDESTAL

H. ROOTRAIN™ CIVIC INLET & PIPE (Rootball irrigation and aeration system.) (GreenBlue Urban — www.greenblue.com)

I. ARBORVENT™ 150 INLET & PIPE (Soil aeration and irrigation system.) (GreenBlue Urban - www.greenblue.com)

COMPACTED BACKFILL Backfill shall be free of organic material, trash and other debris, and shall be free of toxic material injurious to plant growth. (Compact to 95% minimum standard proctor density)

K. ROOTSPACE® 600 PAVEMENT SUPPORT SYSTEM / 1-LAYER (Filled with planting soil.) (GreenBlue Urban – www.greenblue.com)

L. PLANTING SOIL (Screened sandy loam w/4-8% organics by volume. See Planting Soil Specification for composition. Foot compaction only.)

M. GEOGRID REINFORCEMENT FOR SOIL (Place on top of aggregate sub-base)

N. #57 AGGREGATE SUB-BASE / DRAINAGE LAYER - 4" MINIMUM DEPTH (Compact to 95% minimum standard proctor density)


O. COMPACTED SUB-GRADE

P. PERFORATED UNDERDRAIN (OPTIONAL) (Connect to stormwater drainage system per engineers' specifications)

Mix of sedum plants and perennials-(95% vegetation cover at installation) plastic geocomposite drainage Planting media engineered mix-Dual media system -filter fabric Depth: 4 inches - water retention system (HYDROPACK® Pre-grown green roof tray Water Retention 1.3"rain psf \ HYDROSTOCK Water Reservoir Layer
Water Retention 1.18"psf / Microfiber pedestal carries water to the plants. CONNECTORS 4 )Interconnected water reservoirs to share water reserves.


**HYDROPACK®** Max. weight load at full saturation (ASTM E2397): 22 lbs per sq. ft.

Max. water retention: 0.83 gal. per sq. ft. (1.3 inch) Effective RCN: 88 (ESD Chapter 5.)

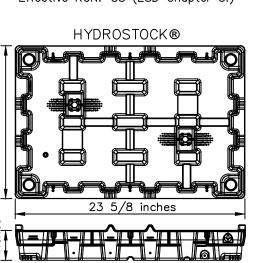

Max. water retention: 1.18 inch per sq. ft. of rainfall when the green roof is fully saturated. The water is stored and released slowly into the sewer system.

VEGETAL I.D. GREEN ROOF SECTION

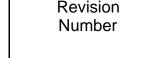

THE

SEVENTY-SIX

Parcel 76, 76 Second Avenue, City of Albany,

Owner: South End Development

LLC

Garrison-Architects

The Chazen Companies

Chazen Project No. 32019.00

Brooklyn, NY 11201

Architect:

45 Main Street

Civil Engineer:

Troy, NY 12180

p (518) 273-0055

Revision Schedule

547 River St,

Revision Description Revision Date

### PLANNING SUBMISSION SET

AS NOTED 12/8/2020 Date: Project No: KC/SM Drawn by:

Seal & Signature:

Checked by:



DOB Stamp & Signature

DOB Scan:


Drawing Title:

## Stormwater **Management Details**

**Drawing Number:** 

C-504

DWG.No:

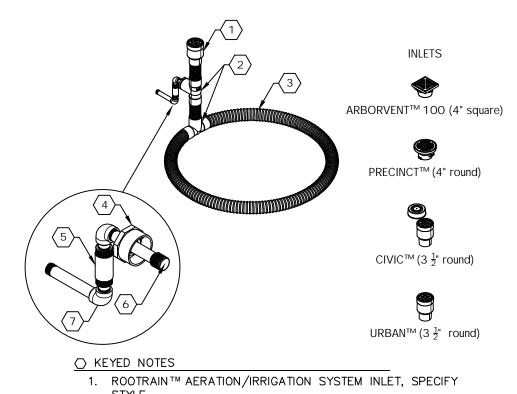

2. ROOTRAIN™ AERATION/IRRIGATION SYSTEM TEE.

3. ROOTRAIN™ AERATION/IRRIGATION SYSTEM PIPE 2 ¾" DIA. FIELD CUT TO FIT AS NEEDED. 4. 2" MALE X 1" FEMALE PVC REDUCING BUSHING.

5. IN-LINE ADJUSTABLE SPRING CHECK VALVE, ½" MIPT X FIPT PVC, TENSION SPRING. SEE GENERAL NOTE B. 6. IRRIGATION FLOOD BUBBLER. SEE NOTE C.

7. PIPE FITTINGS, AS REQUIRED.


A. ROOTBALL AERATION SYSTEM SHALL BE ROOTRAIN™

AERATION/IRRIGATION SYSTEM AS AVAILABLE FROM GREENBLUE URBAN (866-282-2743). SPRING CHECK VALVES ARE FACTORY PRESET TO HOLD BACK A MINIMUM OF 5 PSI OF STATIC PRESSURE CONTRACTOR SHALL ADJUST CHECK VALVES AS REQUIRED

TO PREVENT LOW HEAD DRAINAGE. C. FLOOD BUBBLER HEAD,  $\frac{1}{2}$ " THREAD, 1 GPM.

SCALE: NOT TO SCALE

ROOTRAIN **AERATION/IRRIGATION SYSTEM** 

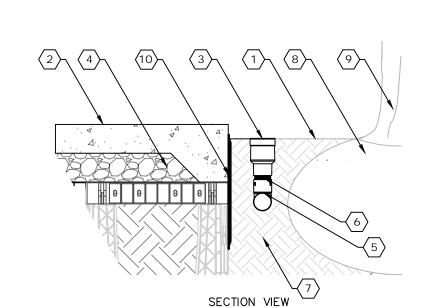

. FINISH GRADE, SEE PLAN 2. PAVEMENT SURFACE

ROOTRAIN™ AERATION/IRRIGATION SYSTEM INLET. 4. COMPACTED AGGREGATE PAVEMENT BASE 5. ROOTRAIN™ AERATION/IRRIGATION SYSTEM TEE. 6. ROOTRAIN™ AERATION/IRRIGATION SYSTEM PIPE, 2


%" DIA. FIELD CUT TO FIT AS NEEDED. 7. PLANTING SOIL 8. TREE ROOTBALL

9. TREE TRUNK 10. REROOT™ URBAN ROOT MANAGEMENT SYSTEM.

A. ROOTBALL AERATION SYSTEM SHALL BE ROOTRAIN  $^{\mathsf{TM}}$ AERATION/IRRIGATION SYSTEM AS AVAILABLE FROM GREENBLUE URBAN (866-282-2743).



ROOTRAIN **AERATION SYSTEM** SCALE: NOT TO SCALE

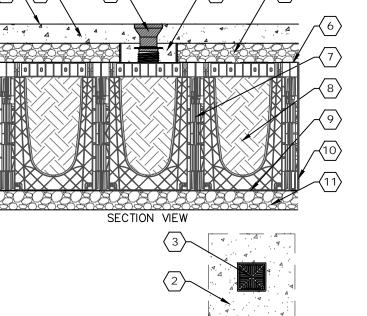

FINISH GRADE, SEE PLAN PAVEMENT SURFACE 3. ARBORVENT™ 150 SOIL AERATION/IRRIGATION SYSTEM INLET, (SEE NOTE A). 4. CONCRETE COLLAR TO SUPPORT ARBORVENT™ 150 (TYP.

PLAN VIEW

12" DIAMETER). 5. COMPACTED AGGREGATE PAVEMENT BASE.

6. GEOGRID/FABRIC COMPOSITE ROOTSPÁCE™ PAVEMENT SUPPORT SYSTEM. B. PLANTING SOIL


9. GEOGRID/SOIL REINFORCEMENT 10. ROOTSTOP™ ROOT AND MOISTURE BARRIER, INSTALL WITHIN 2" OF FINISH GRADE. OVERLAP SEAMS BY 8" AND SEAL WITH FUSION TAPE. MINIMUM 24" DEPTH RECOMMENDED.

(SEE NOTE B). 11. AGGREGATE SUB-BASE

A. AERATION INLET SHALL BE ARBORVENT™ 150 SOIL AERATION INLET AS AVAILABLE FROM GREENBLUE URBAN (866-282-2743).

B. ROOT AND MOISTURE BARRIER SHALL BE ROOTSTOP™ (SPECIFY DEPTH) AS AVAILABLE FROM GREENBLUE URBAN (866-282-2743).



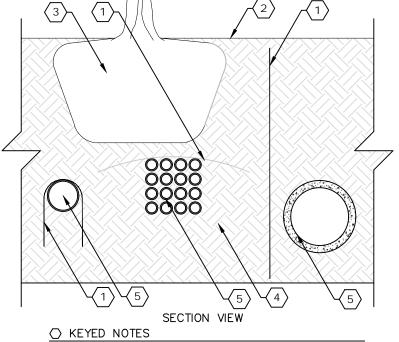

1. ROOTSTOP™ ROOT AND MOISTURE BARRIER, INSTALL WITHIN 2" OF FINISH GRADE. OVERLAP SEAMS BY 8" AND SEAL WITH FUSION TAPE. (SEE NOTE A). FINISH GRADE TREE ROOTBALL

4. PLANTING SOIL

UTILITY GENERAL NOTES A. ROOT AND MOISTURE BARRIER SHALL BE ROOTSTOP™

(SPECIFY DEPTH) AS AVAILABLE FROM GREENBLUE

URBAN (866-282-2743). **ROOT BARRIER AT UTILITY** 

FOR CITY OF ALBANY DEPARTMENT APPROVAL - NOT FOR CONSTRUCTION

## ROOTRAIN **AERATION SYSTEM** SCALE: NOT TO SCALE

ROOTRAIN™ AERATION/IRRIGATION SYSTEM INLET.

ROOTRAIN™ AERATION/IRRIGATION SYSTEM TEE.

3. ROOTRAIN™ AERATION/IRRIGATION SYSTEM PIPE2

¾" DIA. FIELD CUT TO FIT AS NEEDED.

GREENBLUE URBAN (866-282-2743).


6. REROOT™ URBAN ROOT MANAGEMENT SYSTEM.

A. ROOTBALL AERATION SYSTEM SHALL BE ROOTRAIN™

AERATION/IRRIGATION SYSTEM AS AVAILABLE FROM

4. TREE ROOTBALL

TREE TRUNK

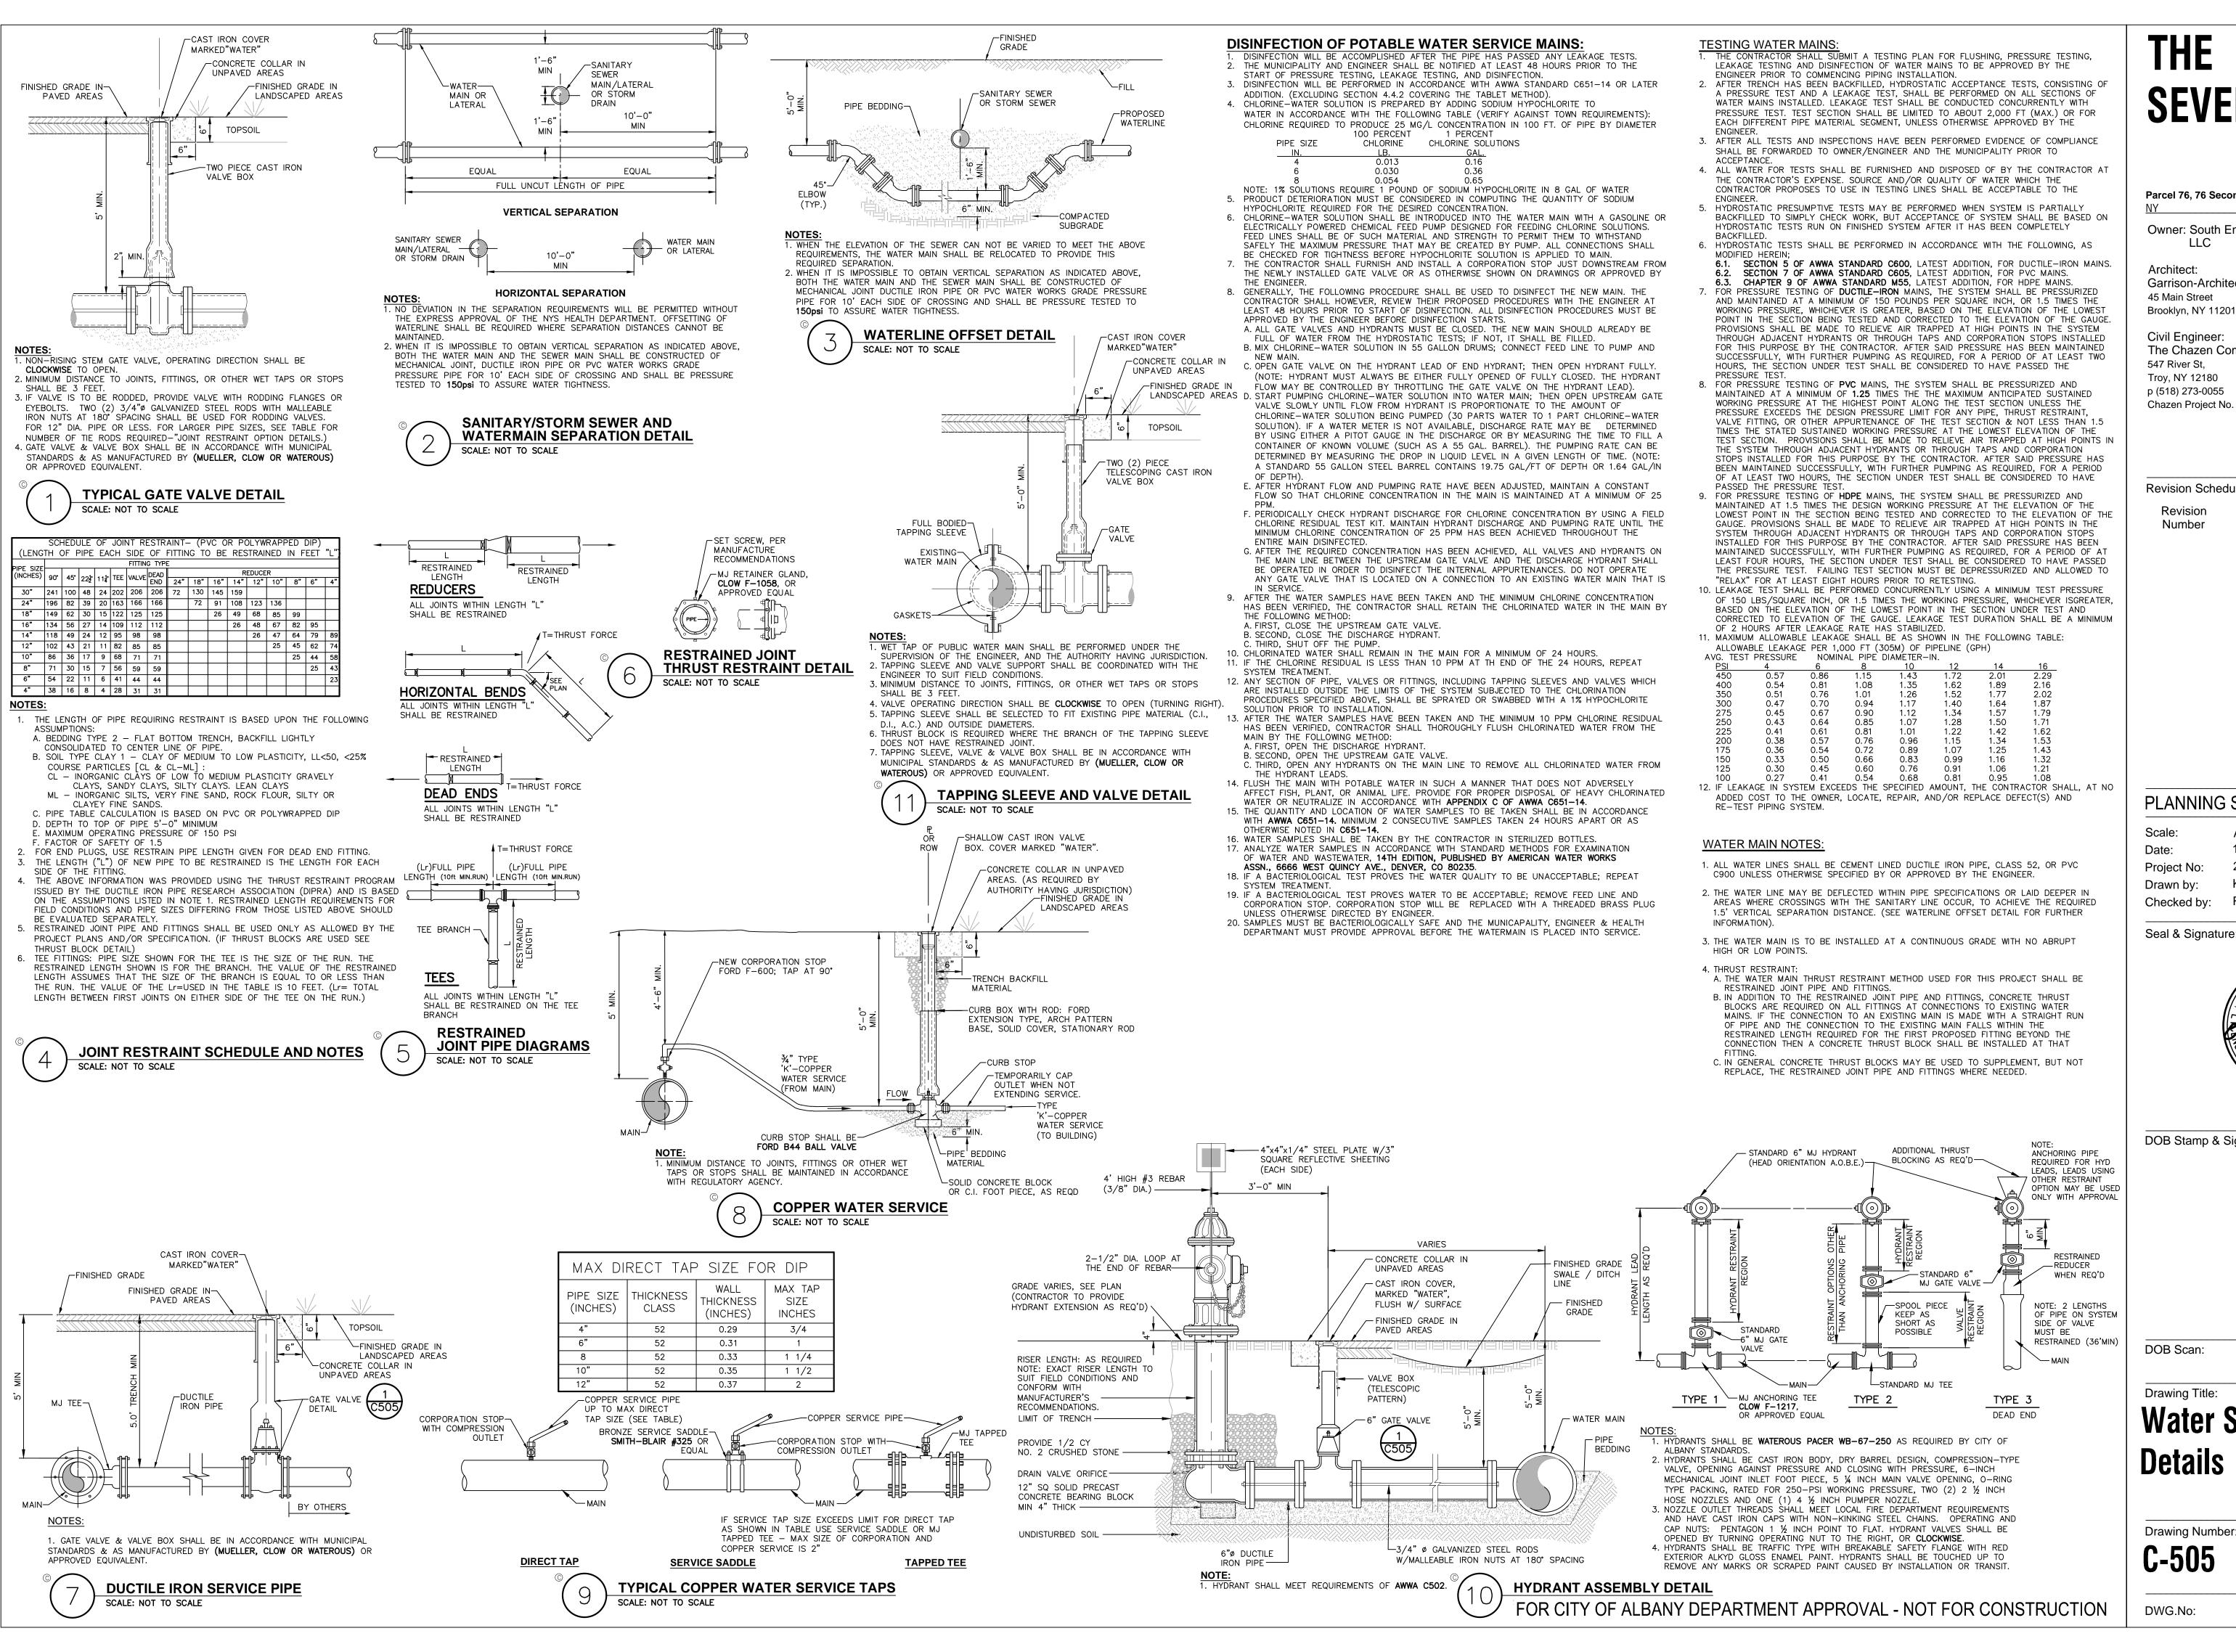

## THE **SEVENTY-SIX**

Parcel 76, 76 Second Avenue, City of Albany,

Owner: South End Development

Architect: Garrison-Architects 45 Main Street Brooklyn, NY 11201

Civil Engineer: The Chazen Companies 547 River St. Troy, NY 12180 p (518) 273-0055 Chazen Project No. 32019.00

#### Revision Schedule

Revision Number

Revision Description Revision Date

### PLANNING SUBMISSION SET

**AS NOTED** 12/8/2020 2005 Project No: KC/SM Drawn by:

Checked by:

Seal & Signature:



DOB Stamp & Signature

## Water System **Details**

C-505

#### CONTRACTOR SHALL INSTALL LOCATION MARKER AT THE END OF ALL SEWER SERVICE LATERALS AND LABEL THE UNIT IT SERVES, THE APPROXIMATE DEPTH TO THE TOP OF THE PIPE, AND THE ACTUAL INVERT ELEVATION OF THE SERVICE LATERAL SQUARE CUT-VISIBLE PLUMB 2"X4"-LOCATION MARKER AT END OF EXISTING AND/OR FINISHED GRADE LATERAL ∟2% GRADE (1/4" PER BEND (SEE NOTE 2) END CAP FOR— FUTURE CONNECTION BEDDING (TYP) C506 └2% GRADE (1/4" PER FOOT) (SEE NOTE 2) CONSTANT SLOPE -SEE NOTE 1 FROM BUILDING TO <u>SECTION</u> SEWER MAIN 45° AT MAIN PROPERTY LINE, R.O.W.,— EASEMENT LIMIT, ETC. PROPERTY LINE, \_SEWER MAIN R.O.W., OR EASEMENT LIMIT PLUMB 2"X4"¬ LOCATION MARKER AT END OF LATERAL (TYP.) REFER TO PLAN FOR LOCATION OF EACH MARKER 45°− WYE **T**X" BUILDING SEWER LATERAL (TYP) END CAP FOR-FUTURE CONNECTION NOTES: 1. OPTIMUM ANGLE IS 45°. THE ENGINEER MAY CALL FOR OTHER ANGLES TO SUIT JOB CONDITIONS. 2. THE CONTRACTOR SHALL BE RESPONSIBLE FOR INSTALLING THE SEWER LATERAL AS CONFIGURED AT THE

SLOPE SPECIFIED, AND FOR ESTABLISHING THE ELEVATION AT THE TERMINATION POINT OF THE LATERAL, IF EXISTING UTILITIES OR OTHER FEATURES PREVENT INSTALLATION IN THAT MANNER. THE ENGINEER SHALL BE CONSULTED PRIOR TO INSTALLATION.

STANDARD SEWER SERVICE CONNECTION PLAN SCALE: NOT TO SCALE

# THE SEVENTY-SIX

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Scale: AS NOTED 12/8/2020 Date: Project No: 2005 Drawn by: Checked by: RK

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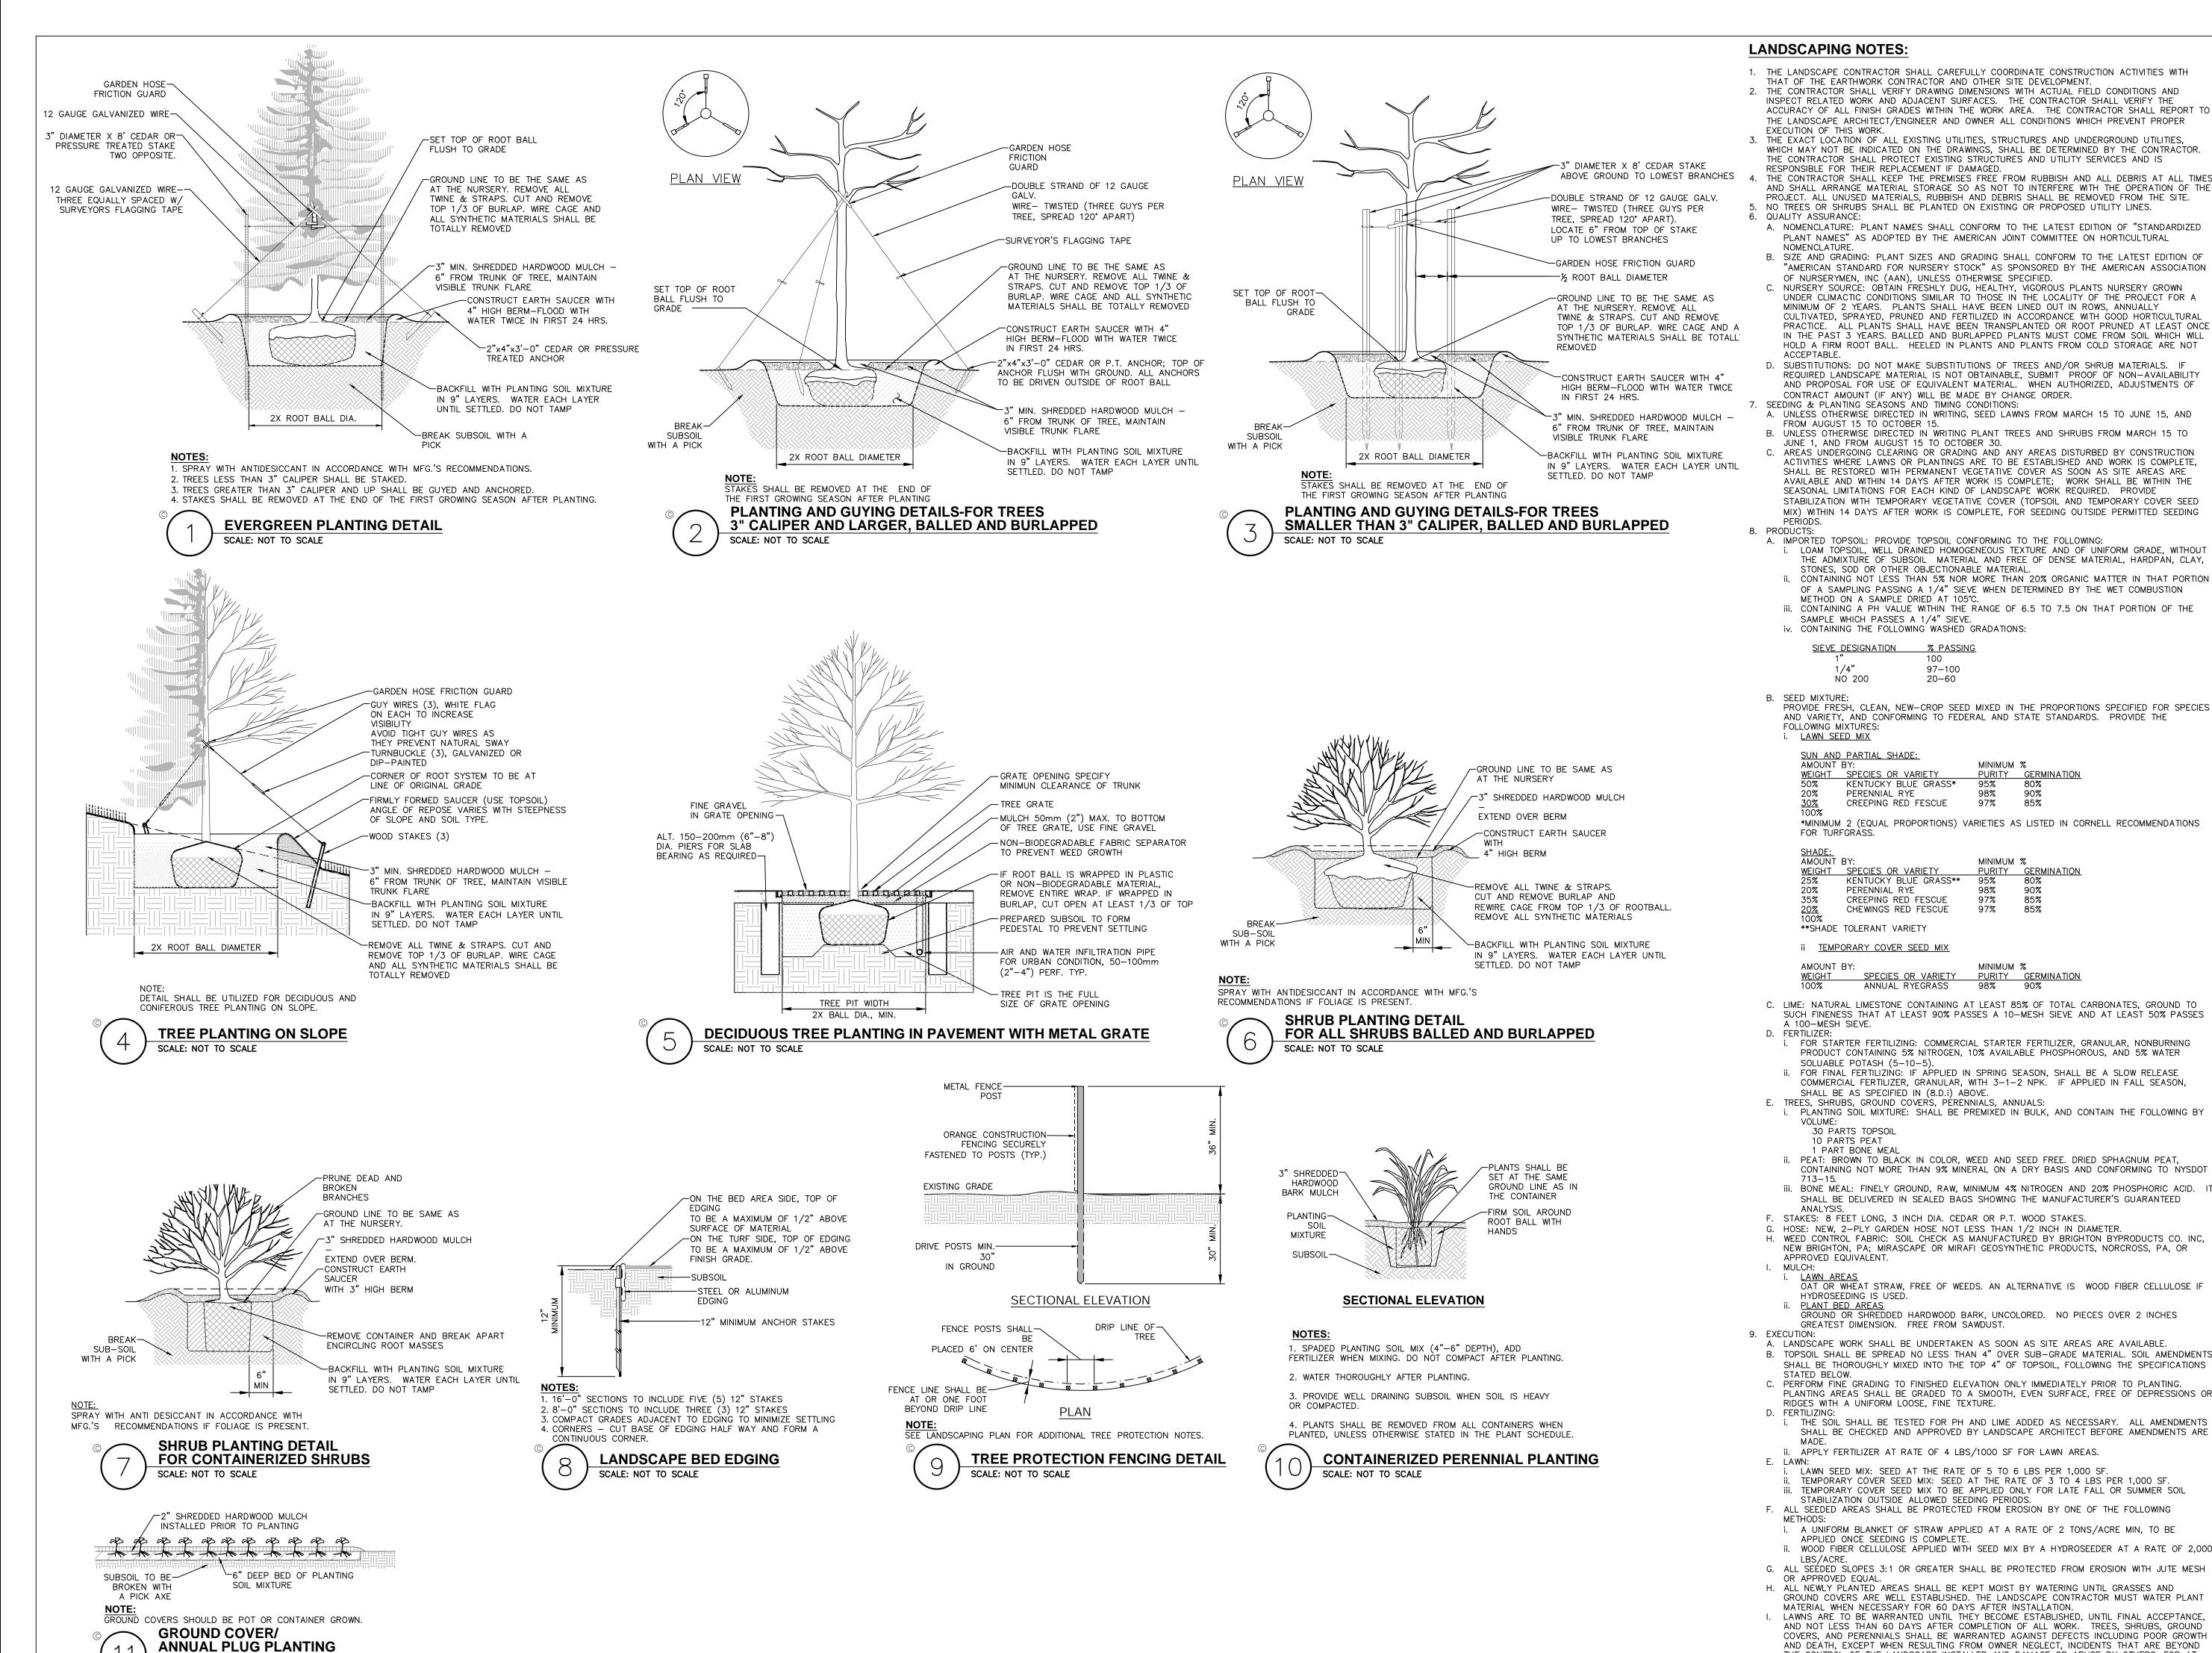
DOB Scan:

Sanitary Sewer
System Details

Drawing Number:

C-506

FOR CITY OF ALBANY DEPARTMENT APPROVAL - NOT FOR CONSTRUCTION



SCALE: NOT TO SCALE

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Revision Revision Description

Date

PLANNING SUBMISSION SET

**AS NOTED** Scale 12/8/2020 Date: 2005 Project No: KC/SM Drawn by:

Seal & Signature:

Checked by:



DOB Stamp & Signature

DOB Scan:

**Drawing Title:** 

## **Landscape Details** & Notes

Drawing Number:

DWG.No:

AND DEATH, EXCEPT WHEN RESULTING FROM OWNER NEGLECT, INCIDENTS THAT ARE BEYOND FOR CITY OF ALBANY DEPARTMENT APPROVAL - NOT FOR CONSTRUCTION

% PASSING 100 97-100

MINIMUM %

MINIMUM %

MINIMUM %

PURITY

PURITY

97%

90%

85%

85%

98%

97%

20-60

#### MAINTENANCE AND PROTECTION OF TRAFFIC (M&PT)

- 1.THE CONTRACTOR SHALL BE RESPONSIBLE FOR THE MAINTENANCE AND PROTECTION OF TRAFFIC (M&PT) FOR THE DURATION OF THE CONTRACT. M&PT SHALL BE PROVIDED IN ACCORDANCE WITH THE FOLLOWING DOCUMENTS:
- A.THE TRAFFIC CONTROL PLAN AND REQUIREMENTS SET FORTH IN THE PLANS AND/OR PROPOSAL OF THIS CONTRACT. B.THE MOST CURRENT EDITION OF THE MANUAL OF UNIFORM TRAFFIC CONTROL
- DEVICES (MUTCD) C.NEW YORK STATE DEPARTMENT OF TRANSPORTATION (NYSDOT) STANDARD SPECIFICATIONS - CHAPTER 19 WORK ZONE TRAFFIC CONTRÓL D.NYSDOT STANDARD SHEETS FOR WORK ZONE TRAFFIC CONTROL FOR LONG TERM
- OPERATION 619 SERIES FOR LONG TERM OPERATIONS. I.E THE WORK ZONE IS N EFFECT FOR OVERNIGH E.NYSDOT WORK ZONE TRAFFIC CONTROL MANUAL FOR SHORT TERM OPERATIONS, I.E. THE WORK ZONE IS IN EFFECT ONLY DURING THE DAY AND IS NOT MAINTAINED
- 2.THE MANUAL OF UNIFORM TRAFFIC CONTROL DEVICES (MUTCD) IS DEFINED AS THE NATIONAL MUTCD FOR STREETS AND HIGHWAYS (US DEPARTMENT OF TRANSPORTATION/FEDERAL HIGHWAY ADMINISTRATION) AS MODIFIED BY THE NEW YORK STATE SUPPLEMENT TO THE NATIONAL MUTCD. WHEN MUTCD IS NOTED IT REFERS TO THE MOST CURRENT EDITION.
- 3.THE TYPICAL DETAILS PRESENTED IN MUTCD AND NYSDOT STANDARD SHEETS REFLECT MINIMUM REQUIREMENTS. ADDITIONAL DEVICES AND/OR METHODS OF TRAFFIC CONTROL MAY BE ORDERED BY THE ENGINEER TO MEET FIELD CONDITIONS.
- 4.PROPOSED REVISIONS TO THE TRAFFIC CONTROL PLAN MUST BE SUBMITTED FOR APPROVAL BY THE CONTRACTOR TO THE REGULATORY AGENCY WITH AUTHORITY OVER THE ROADWAY, OR ITS REPRESENTATIVE, I.E. ENGINEER. PROPOSED REVISIONS MUST BE SUBMITTED FIVE (5) WORK DAYS PRIOR TO THE PLANNED IMPLEMENTATION OF THE PROPOSED REVISIONS.
- 5.THE CONTRACTOR SHALL PROVIDE THE ENGINEER, IN WRITING, WITH CONTACT INFORMATION FOR STAFF AUTHORIZED TO SECURE LABOR, MATERIALS, AND EQUIPMENT FOR EMERGENCY REPAIRS OUTSIDE OF NORMAL WORK HOURS. THE CONTACT INFORMATION SHALL INCLUDE NAMES, ADDRESSES, AND TELEPHONE NUMBERS (HOME AND CELL). THE ENGINEER SHALL PROVIDE THE CONTACT INFORMATION TO THE APPROPRIATE REGULATORY AGENCIES, LOCAL POLICE AND NEW YORK STATE POLICE, AND THE LOCAL NYSDOT MAINTENANCE RESIDENCY.
- 6. THE CONTRACTOR SHALL PROVIDE A TENTATIVE SCHEDULE OF OPERATIONS TO THE ENGINEER AND ALL LOCAL AUTHORITIES AND EMERGENCY SERVICE PROVIDERS TWO WEEKS BEFORE BEGINNING CONSTRUCTION ACTIVITIES. DURING CONSTRUCTION. THE CONTRACTOR SHALL BE REQUIRED TO PROVIDE NOTIFICATION TO THE ENGINEER. LOCAL AUTHORITIES, AND EMERGENCY SERVICE PROVIDERS OF CHANGES TO THE PREVIOUS WORK PLAN/WORK LOCATIONS, PROVISIONS SHALL BE MADE AT THE PRE-CONSTRUCTION MEETING OR OTHER MEETING PRIOR TO THE START OF WORK BETWEEN THE CONTRACTOR, LOCAL AUTHORITIES AND EMERGENCY SERVICE PROVIDERS TO ADDRESS A SITUATION WHEN EMERGENCY ACCESS IS NEED THROUGH A CONSTRUCTION OPERATION OF CONTRACT LIMITS.

- 1. THE CONTRACTOR SHALL MAINTAIN AT LEAST ONE ACCESS TO EACH ADJACENT PROPERTY DURING ALL CONSTRUCTION OPERATIONS. 2.IF CONDITIONS REQUIRE THAT ACCESS TO A PROPERTY BE TEMPORARILY CLOSED. THE CONTRACTOR SHALL NOTIFY THE OWNER AND OCCUPANT AT LEAST 24 HOURS IN 3.ALL PROPERTIES SHALL HAVE AT LEAST ONE ACCESS DRIVE OPEN FOR SAFE USE AT THE END OF FACH WORK DAY 4.FOR MULTIPLE ACCESS PROPERTIES, AT LEAST ONE ACCESS SHALL BE OPEN AT ALL
- 5.SUITABLE RAMPS SHALL BE INSTALLED TO MAINTAIN SMOOTH TRANSITIONS FROM RESIDENTIAL AND COMMERCIAL DRIVEWAYS TO AND FROM THE WORK AREA.

1.A MINIMUM 500' LONGITUDINAL DISTANCE SHALL BE MAINTAINED BETWEEN WORK OPERATIONS ON ALTERNATE SIDES OF THE ROADWAY, UNLESS OTHERWISE APPROVED BY THE FNGINFER. 2.IF TWO OR MORE WORK AREAS ARE ADJACENT, OVERLAP, OR IN CLOSE PROXIMITY (LESS THAN 500' APART,) THE CONTRACTOR SHALL ENSURE THAT THERE ARE NO CONFLICTING SIGNS OR PAVEMENT MARKINGS, AND THAT LANE CONTINUITY IS

MAINTAINED THROUGHOUT ALL WORK AREAS.

- 1. THE CONTRACTOR SHALL LOCATE LANE CLOSURES TO PROVIDE OPTIMUM VISIBILITY, IE. PRIOR TO HORIZONTAL CURVES AND VERTICAL CRESTS, TO THE EXTENT CONDITIONS 2.THE CONTRACTOR MAY BE REQUIRED TO RE-OPEN ALL TRAVEL LANES AT ANY TIME IF THE ROUTE IS NEEDED FOR EMERGENCY PURPOSES, INCLUDING INCIDENTS OUTSIDE THE CONTRACT LIMITS
- 3.LANE CLOSURES MUST CONFORM TO THE TIME REQUIREMENTS OF THE CONTRACT DOCUMENTS AND HIGHWAY WORK PERMITS IF ISSUED. 4.TEMPORARY LANE CLOSURES MAY NOT BE PERMITTED DURING THE PEAK TRAVEL PERIODS OF 7:00 TO 9:00 AM AND 3:30 TO 6:00 PM UNLESS APPROVED BY THE **FNGINFFR**
- 5.TEMPORARY LANE CLOSURES MAY NOT BE PERMITTED DURING THE FOLLOWING HOLIDAY PERIODS: EASTER WEEKEND, MEMORIAL DAY WEEKEND, JULY 4TH, COLUMBUS DAY, THANKSGIVING, CHRISTMAS, AND NEW YEAR'S DAY.

#### WORK ZONE TRAVEL LANES: 1.THE MINIMUM LANE WIDTH FOR WORK ZONE TRAVEL LANES SHALL BE 11' FOR FREEWAYS AND/OR EXPRESSWAYS, AND 10' FOR ALL OTHER TYPES OF ROADWAYS. EXCEPTIONS TO THESE MINIMUM LANES WIDTHS MUST BE AUTHORIZED BY THE

- 2.WRITTEN NOTICE SHALL BE PROVIDED BY THE CONTRACTOR TO THE ENGINEER AT LEAST 21 DAYS IN ADVANCE OF PERFORMING ANY WORK THAT RESULTS IN THE REDUCED WIDTH OF AN EXISTING ROADWAY. THE ENGINEER SHALL NOTIFY THE LOCAL NYSDOT RESIDENCY PERMIT ENGINEER IN A TIMELY MANNER OF THE CONTRACTOR'S NOTICE
- 1. WHERE POSSIBLE ALL CHANNELIZING AND GUIDING DEVICES ARE TO BE PLACED SO AS TO PROVIDE A MINIMUM 2' LATERAL CLEARANCE TO THE TRAVELED WAY.

- 1. ALL SIGNS SHALL BE LOCATED AS SHOWN IN THE WORK ZONE TRAFFIC CONTROL PLANS OR AS SPECIFIED BY THE CURRENT MUTCD, NYSDOT STANDARD SHEETS, OR NYSDOT WORK ZONE TRAFFIC CONTROL MANUAL. SIGNS GENERALLY SHALL BE LOCATED ALONG THE RIGHT SIDE OF THE ROADWAY FACING ONCOMING TRAFFIC AT RIGHT
- 2.THE LOCATIONS OF SIGNS MAY BE ADJUSTED FROM THAT SHOWN IN THE WORK ZONE TRAFFIC CONTROL PLANS BASED ON SIGHT DISTANCE AND OTHER CONSIDERATIONS. THE FINAL LOCATIONS OF SIGNS ARE SUBJECT TO THE ENGINEER'S APPROVAL. 3.EXISTING SIGNS THAT CONFLICT IN MESSAGE OR VISIBILITY WITH THE SIGNS REQUIRED BY THE WORK ZONE TRAFFIC CONTROL PLAN LAYOUT SHALL BE COVERED, REMOVED, STORED OR RESET AS APPROVED BY THE ENGINEER. ALL APPROPRIATE EXISTING SIGNS SHALL BE RESTORED TO THEIR ORIGINAL CONDITION AND/OR LOCATION UNLESS
- REPLACED UNDER THIS CONTRACT. 4.SIGNS AT OR NEAR INTERSECTIONS SHALL BE PLACED SO THAT THEY DO NOT
- OBSTRUCT A MOTORIST'S LINE OF SIGHT. 5.WARNING AND REGULATORY SIGNS SHALL BE POSTED ON BOTH SIDES OF MULTI-LANE DIVIDED HIGHWAYS, MULTI-LANE RAMPS, AND ONE WAY STREETS. IF LANE RESTRICTIONS REDUCE THE TRAVEL WAY TO ONE LANE, SIGNS SHALL BE PLACED ON THE RIGHT SIDE OF THE ACTIVE TRAVEL LANE, UNLESS OTHERWISE AUTHORIZED BY THE ENGINEER. 6. THE DIMENSIONS OF WORK ZONE TRAFFIC CONTROL SIGNS ARE DESCRIBED IN THE
- MUTCD AND OTHER DOCUMENTS NOTED IN "GENERAL NOTES 1". ANY CHANGES TO THE DIMENSIONS SHALL BE APPROVED BY THE ENGINEER. 7.SIGN INSTALLATION NOTES A.SIGN SUPPORT - THE CONTRACTOR SHALL SUPPLY ADEQUATE SUPPORTS SO THAT THE SIGNS ARE IMPROPER POSITION AND ALIGNMENT AS SHOWN IN THE WORK ALL WOOD SUPPORTS SHALL BE PAINTED WITH TWO (2) COATS OF WHITE PAINT
- ZONE TRAFFIC CONTROL PLAN, AND OTHER M&PT REQUIREMENT DOCUMENTATION. B.SIGN PANELS MAY BE MADE OF ALUMINUM, STEEL OR PLYWOOD. THE BACKS OF ALL PLYWOOD PANELS SHALL BE PAINTED WITH TWO (2) COATS OF WHITE PAINT. C.SIGN LEGEND - SIGN LEGEND, BORDERS AND MARGINS SHALL BE IN ACCORDANCE WITH THE MUTCD.
- D.SIGN COLOR THE COLOR OF THE SIGN BACKGROUND AND LEGEND SHALL BE AS SPECIFIED IN THE MUYCD. THE MARGIN SHALL BE THE SAME COLOR SPECIFIED FOR THE BACKGROUND, AND THE BORDER SHALL BE THE SAME COLOR SPECIFIED FOR THE LEGEND. E.SIGN SHAPE - THE SHAPE OF ALL SIGNS SHALL BE AS SPECIFIED IN THE MUTCD.
- CORNERS OF SIGNS SHALL BE ROUNDED. F.REFLECTORIZATION - ALL SIGNS SHALL BE REFLECTIVE USING HIGH INTENSITY REFLECTORIZED TAPE OR PAINT. ALL SIGNS SHALL BE REVIEWED AT NIGHT AFTER ERECTION FOR VISIBILITY AND REFLECTORIZATION. ANY SIGNS NOT MEETING PROPER REFLECTION REQUIREMENTS SHALL BE REPLACED.
- 8.THE CONTRACTOR SHALL KEEP SIGNS CLEANED AND CLEARED AT ALL TIMES. ALL SIGNS ARE THE PROPERTY OF THE CONTRACTOR AND SHALL BE MAINTAINED IN GOOD CONDITION FOR THE DURATION OF THE CONTRACT. ALL SIGNS SHALL BE REMOVED FROM THE WORK SITE WHEN THE CONTRACT WORK IS ACCEPTED.

### PAVEMENT MARKINGS:

- 1. ALL TEMPORARY PAVEMENT MARKINGS SHALL BE PLACED (LOCATED) IN ACCORDANCE WITH THE CONTRACT DOCUMENTS AND THE MUTCH. 2.ALL TEMPORARY PAVEMENT MARKINGS SHALL CONFORM TO THE MATERIAL AND
- PLACEMENT REQUIREMENTS OF THE CONTRACT DOCUMENTS, MUTCD, AND NYSDOT STANDARD SPECIFICATIONS. 3.IF REQUIRED TEMPORARY PAVEMENT MARKINGS CONFLICT IN MESSAGE OR LOCATION WITH EXISTING PAVEMENT MARKINGS, THE EXISTING PAVEMENT MARKINGS WILL BE REMOVED OR COVERED FOR THE DURATION OF THE USE OF THE TEMPORARY MARKINGS AS APPROVED BY THE ENGINEER. ALL APPROPRIATE EXISTING MARKINGS SHALL BE RESTORED TO THEIR ORIGINAL CONDITION AND/OR LOCATION UNLESS REPLACED UNDER THIS CONTRACT.

- TEMPORARY TRAFFIC SIGNALS: 1. THE OPERATION, I.E. PHASING AND TIMING, OF TEMPORARY TRAFFIC SIGNALS OR EXISTING TRAFFIC SIGNAL MODIFIED TO CONTROL WORK ZONE ACTIVITY, SHALL BE APPROVED BY THE REGULATORY AUTHORITY HAVING CONTROL OVER THE ROADWAY
- AND/OR EXISTING TRAFFIC SIGNAL. 2.TEMPORARY TRAFFIC SIGNALS INSTALLED FOR WORK ZONE ACTIVITIES SHALL CONFORM TO THE REQUIREMENTS OF THE MUTCD AND NYSDOT STANDARD SHEET 619-62,
- EFFECTIVE DATE 01/08/09. 3.ALL WORK ZONE OPERATIONS AND WORK SHALL BE COMPLETED AND ACCEPTED BY THE ENGINEER PRIOR TO THE REMOVAL OF THE TEMPORARY TRAFFIC SIGNAL(S)
- INSTALLED TO CONTROL TRAFFIC FOR THOSE ACTIVITIES. 4.THE CONTRACTOR SHALL PROVIDE THE ENGINEER, IN WRITING, WITH CONTACT INFORMATION FOR STAFF AUTHORIZED TO PERFORM MAINTENANCE AND REPAIRS TO TEMPORARY TRAFFIC SIGNALS DURING AND OUTSIDE OF NORMAL WORK HOURS. THE
- CONTACT INFORMATION SHALL INCLUDE NAMES, ADDRESSES, AND TELEPHONE NUMBERS (HOME AND CELL). THE ENGINEER SHALL PROVIDE THE CONTACT INFORMATION TO THE APPROPRIATE REGULATORY AGENCIES, LOCAL POLICE, AND NEW YORK STATE POLICE.

#### WORK DURATION

WORK DURATION DIRECTLY INFLUENCES THE REQUIREMENTS FOR WORK ZONE TRAFFIC CONTROL. TO FACILITATE THE UNDERSTANDING OF THE INFORMATION PRESENTED IN THE CONTRACT PLANS AND DOCUMENTS, ESPECIALLY THE NYSDOT DOCUMENTS REFERENCED IN THE M&PT GENERAL NOTES. THE FOLLOWING DEFINITIONS ARE PRESENTED.

- 1.LONG TERM STATIONARY WORK WORK THAT OCCUPIES A LOCATION MORE THAN THREE CONSECUTIVE DAYS. TYPICALLY THE WORK AREA IS OCCUPIED BY EXCAVATIONS, MATERIALS, AND/OR EQUIPMENT AT TIMES WHEN WORKERS ARE NOT PRESENT. 2.INTERMEDIATE-TERM STATIONARY WORK - WORK THAT OCCUPIES A LOCATION MORE THAN ONE DAYLIGHT PERIOD UP TO THREE CONSECUTIVE DAYS, OR NIGHTTIME WORK LASTING MORE THAN ONE HOUR. TYPICALLY THE WORK AREA IS OCCUPIED BY
- 3.SHORT-TERM STATIONARY WORK DAYTIME WORK THAT OCCUPIES A LOCATION FOR MORE THAN ONE HOUR WITHIN A SINGLE DAYLIGHT PERIOD. EXAMPLES ARE GUIDERAIL REPAIR, DITCH MAINTENANCE, AND BRIDGE INSPECTION. 4.SHORT DURATION WORK - WORK THAT OCCUPIES A LOCATION UP TO ONE HOUR. EXAMPLES ARE POT HOLE REPAIR, MINOR GUIDERAIL REPAIR, AND SIGN REPAIR.

EXCAVATIONS, MATERIALS, AND/OR EQUIPMENT AT TIMES WHEN WORKERS ARE NOT

- 5.MOBILE WORK WORK THAT MOVES INTERMITTENTLY OR CONTINUOUSLY. EXAMPLES ARE PAINT STRIPING OPERATIONS, SWEEPING OPERATIONS, AND HERBICIDE SPRAYING THE ABOVE DEFINITIONS ARE ON PER NYSDOT STANDARD SHEET 619-11, EFFECTIVE DATE
- 01/08/09, AND THE NYSDOT WORK ZONE TRAFFIC CONTROL MANUAL. LONG-TERM AND INTERMEDIATE-TERM WORK ZONE TRAFFIC CONTROL REQUIREMENTS ARE

SHORT-TERM, SHORT DURATION, AND MOBILE WORK ZONE TRAFFIC CONTROL REQUIREMENTS ARE COVERED BY THE NYSDOT WORK ZONE TRAFFIC CONTROL MANUAL.

COVERED BY THE 619 SERIES OF THE NYSDOT STANDARD SHEETS.

BARRIER VEHICLE USE RI	TABLE NY1 EQUIREMENTS(LONG TERM, INTERMEDI		ID SHORT TERM	STATIONARY C	LOSURES)
			USE REQUIF	REMENTS 4,5	
CLOSURE TYPE	EXPOSURE CONDITION <sup>1</sup>	FREEWAY	NON-FREEWAY (PRECONSTRU	( CTION POSTED	SPEED LIMIT)
			w 45 MPH	35-40 MPH	I 30 MPH
	WORKERS ON FOOT OR IN VEHICLES EXPOSED TO TRAFFIC	REQUIRED <sup>3</sup>	REQUIRED <sup>3</sup>	REQUIRED <sup>3</sup>	OPTIONAL <sup>2</sup>
LANE CLOSURE	NON—TRAVERSABLE HAZARD (IE. EQUIPMENT, MATERIALS,EXCAVATION) ONLY NO WORKERS EXPOSED	REQUIRED <sup>3</sup>	REQUIRED <sup>3</sup>	OPTIONAL <sup>2</sup>	OPTIONAL <sup>2</sup>
CHOIN DED. OF COURT	WORKERS ON FOOT OR IN VEHICLES EXPOSED TO TRAFFIC	REQUIRED <sup>3</sup>	REQUIRED <sup>3</sup>	OPTIONAL 2	OPTIONAL <sup>2</sup>
SHOULDER CLOSURE	NON—TRAVERSABLE HAZARD (IE. EQUIPMENT, MATERIALS,EXCAVATION) ONLYNO WORKERS EXPOSED	REQUIRED <sup>3</sup>	OPTIONAL <sup>2</sup>	OPTIONAL <sup>2</sup>	OPTIONAL <sup>2</sup>

- 1. THE EXPOSURE CONDITIONS DESCRIBED IN TABLE NY1-A ASSUMES THERE IS NO POSITIVE PROTECTION (TEMPORARY TRAFFIC BARRIER) PRESENT. WHERE WORKERS OR HAZARDS ARE PROTECTED BY A TEMPORARY TRAFFIC BARRIER, BARRIER VEHICLES ARE NOT REQUIRED.
- 2. WHERE THE REQUIREMENT IS "OPTIONAL", EITHER A BARRIER VEHICLE OR THE STANDARD LONGITUDINAL BUFFER SPACE (TABLE 6C-2) SHALL BE PROVIDED.
- REQUIREMENTS SHALL INCLUDE PROVIDING A SEPARATE BARRIER VEHICLE FOR EACH CLOSED LANE AND EACH CLOSED PAVED SHOULDER 8' OR GREATER IN WIDTH. IF THE WORK SPACE MOVES WITH IN THE STATIONARY CLOSURE, THE BARRIER VEHICLE SHALL BE REPOSITIONED ACCORDINGLY.
- 4. BARRIER VEHICLES PROTECTING NON-TRANSVERSABLE HAZARDS SHALL REMAIN IN PLACE DURING BOTH WORKING AND NON-WORKING HOURS UNTIL THE HAZARD NO LONGER EXISTS. EXCEPTIONS TO THESE REQUIREMENTS MAY BE MADE, AS APPROVED BY THE REGIONAL DIRECTOR OR HIS/HER DESIGN EE WHERE BARRIER VEHICLE PLACEMENT WOULD BE INEFFECTIVE OR WOULD INTERFERE WITH THE SAFE OPERATION OF TRAFFIC.
- 5. BARRIER VEHICLES ARE NOT REQUIRED FOR MILLING AND/OR PAVING OPERATIONS, BUT THE STANDARD LONGITUDINAL BUFFER SPACE (TABLE 6C-2) SHALL BE PROVIDED.BARRIER VEHICLES ARE NOT REQUIRED FOR FLAGGING OPERATIONS, BUT THE STANDARD LONGITUDINAL BUFFER SPACE (TABLE6C-2) SHALL BE PROVIDED.

ADVA	TABLE NCE WARNII	NY6H-3 NG SIGN SF	PACING			TABLE 6C-3 TAPER LENGTH FOR TEMPORARYTRA	AFFIC CONTROL ZONES
	DISTANCE	BETWEEN	SIGNS	SIGN I	LEGEND	TARE OF TARES	TARER LENOTH (L)
ROAD TYPE	A (FT.)	B (FT.)	C (FT.)	XX	YY	TYPE OF TAPER MERGING TAPER	TAPER LENGTH (L)
URBAN (I 30 MPH*)	100	100	100	AHEAD	AHEAD	SHIFTING TAPER	L/2
URBAN (35-40 MPH*)	200	200	200	AHEAD	AHEAD	SHOULDER TAPER	L/3
URBAN (w 45 MPH*)	350	350	350	1000 FT.	AHEAD	ONE-LANE, TWO-WAY TRAFFIC TAPER	100 FT. MAXIMUM
RURAL	500	500	500	1500 FT.	1000 FT.	DOWNSTREAM TAPER	100 FT. PER LANE
EXPRESSWAY / FREEWAY	1000	1500	2640	1 MILE	1/2 MILE	TABLE NY	7-A
PRECONSTRUCTION PO	OSTED S	PEED LI	MIT			PLACEMENT DISTANCE FO	

URBAN: (MEETS MORE THAN 1 OF THE FOLLOWING
CRITERIA)SIDEWALKS, BICYCLE USAGE, CURBING, CLOSED
DRAINAGE SYSTEMS, DRIVEWAY DENSITIES GREATER THAN 24
DRIVEWAYS PER MILE, MINOR COMMERCIAL DRIVEWAY DENSITIES
OF 10 DRIVEWAYS PER MILE OR GREATER, MAJOR COMMERCIAL
DRIVEWAYS, NUMEROUS RIGHT OF WAY CONSTRAINTS, HIGH
DENSITY OF CROSS STREETS, 85TH PERCENTILE SPEEDS OF
AE MOULOD LECC

RURAL: ANY AREA NOT EXHIBITING MORE THAN ONE OF THE ABOVE CHARACTERISTICS.

PARTIAL CONTROL OF ACCESS.

EXPRESSWAY: DIVIDED HIGHWAYS FOR TRAFFIC WITH FULL OR STATIONARY WORK ZONES. PARTIAL CONTROL OF ACCESS AND GENERALLY WITH GRADE SEPARATION SAT MAJOR CROSSROADS.

FREEWAYS/INTERSTATE: LOCAL OR INTER REGIONAL HIGH-SPEED, DIVIDED, HIGH-VOLUME FACILITIES WITH FULL OR

_						. –
븨		TAB	LE NY2-A			Н
	PLACE	MENT DISTANC	E FOR BARRIE	ER VEHICLES		
	PRECONSTRUCTION POSTEDSPEED	F	PLACEMENT DI BARRIER VE	, ,		
	LIMIT (MPH)	(18000	LBS.)	(2400	0 LBS.)	Ľ
Ş۱		MINIMUM	MAXIMUM	MINIMUM	MAXIMUM	ŀ
닉	> 55	100 FT.	200 FT.	100 FT.	200 FT.	ŀ
	45 - 55	100 FT.	200 FT.	85 FT.	165 FT.	lt
	< 45	85 FT.	165 FT.	50 FT.	100 FT.	
	* AS DEFINED IN	NYSDOT S	TANDARD S	SPECIFICATI	ON 619:	

BARRIER VEHICLE - VEHICLE USED FOR STATIONARY SHOULDER CLOSURES, LANE CLOSURES, AND OTHER

MINIMUM DISTANCE SHOWN REFLECTS THE ACTUAL ROLL AHEAD DISTANCE FROM MANUFACTURER.


	LONGITUDINAL DU	LONGITUDINAL BUFFER SPACE				
	PRECONSTRUCTION POSTEDSPEED LIMIT (MPH)	DISTANCE				
┨	25	155 FT.				
-	30	200 FT.				
4	35	250 FT.				
╛	40	305 FT.				
	45	360 FT.				
_	50	425 FT.				
	55	495 FT.				
	60	570 FT.				
	65	645 FT.				

TABLES, TABLE NOTES & WORK ZONE TRAFFIC CONTROL AREA FROM NYSDOT STANDARD SHEET 619-11 (LATEST EDITION)

#### TABLE 6H-4 FORMULAS FOR DETERMINING TAPER LENGTHS TAPER LENGTH (L) \_ = TAPER LENGTH WS = WIDTH OF OFFSET (FT.)= PRECONSTRUCTION (40 MPH) OR LESS $L = WS^2/60$ POSTED SPEED LIMIT (MPH) L = WS(45 MPH) OR MORE STANDARD TAPER LENGTHS LATERAL SHIFT TEMPORARY TRAFFIC CONTROL ZONE POSTED SPEED LIMIT F TRAFFIC (25 MPH) (30 MPH) (35 MPH) (40 MPH) (45 MPH) (50 MPH) (60 MPH) (65 MPH) (67 MPH) FLOW PATH 165 215 360 400 440 480 520 95 135 185 240 405 450 495 540 585 630 105 150 205 270 450 500 550 600 650 700 115 | 165 | 225 | 295 | 495 | 550 | 605 | 660

125 | 180 | 245 | 320 | 540 | 600 | 660 | 720 |

IF WARRANTED CONTRACTOR CAN SUBMIT ALTERNATE M&PT PLANS TO FACILITATE CONSTRUCTION ACTIVITIES TO THE CITY & THE ENGINEER FOR REVIEW & APPROVAL PRIOR TO START OF CONSTRUCTION.

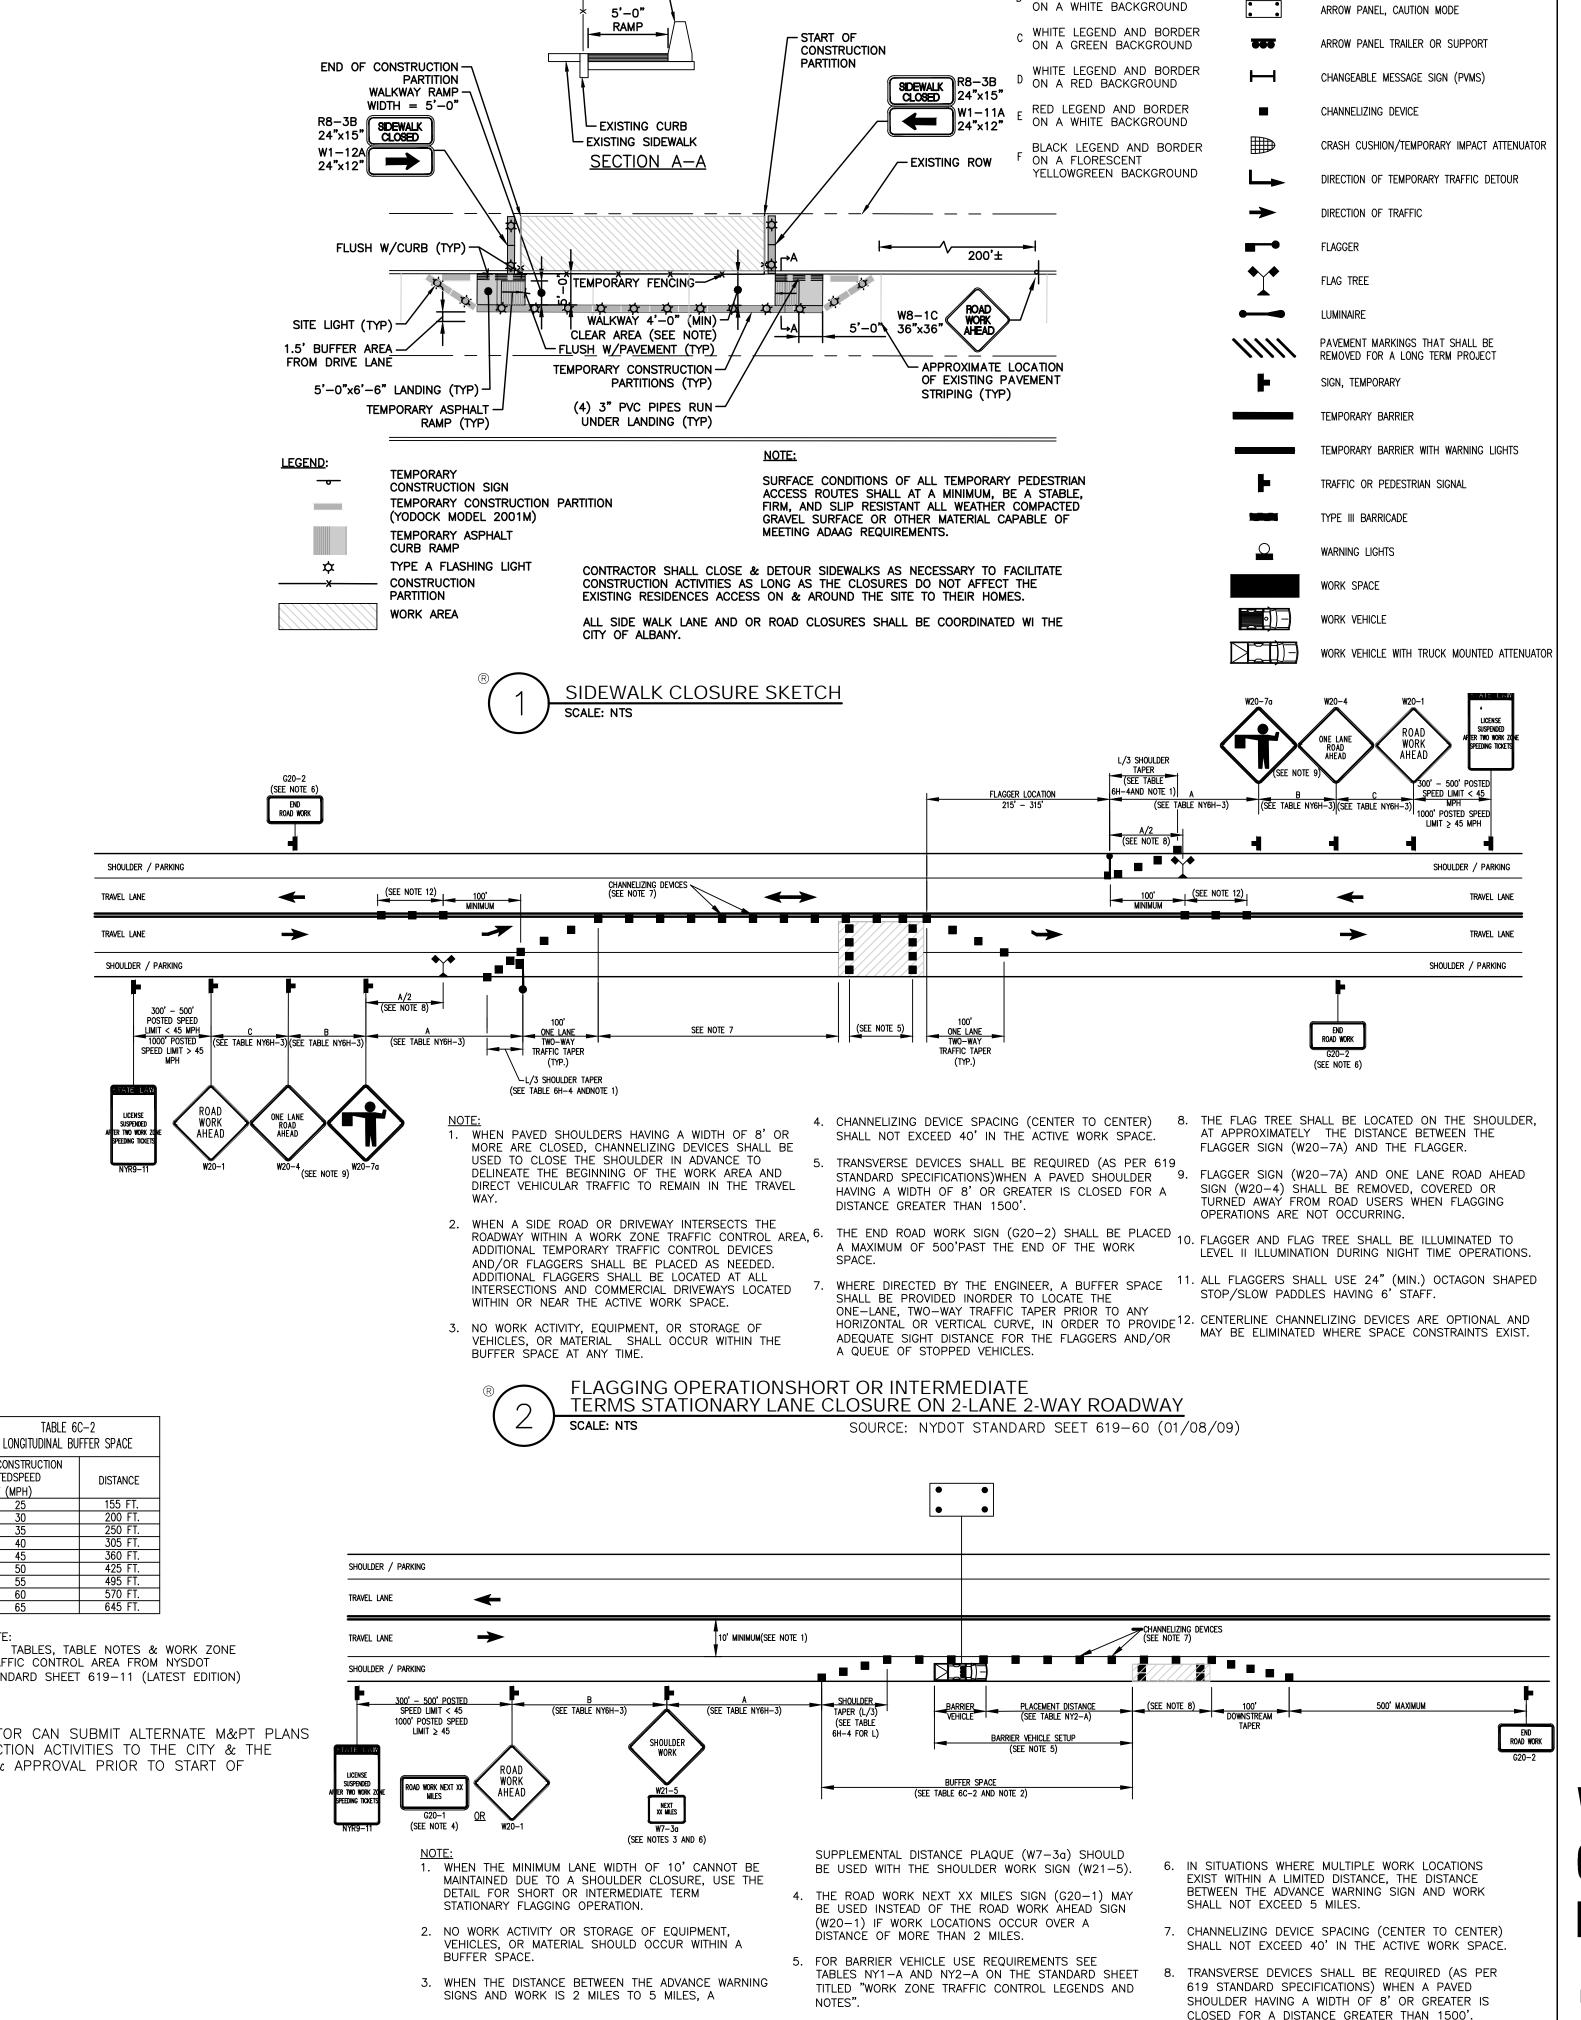

SHOULDER CLOSURE SHORT OR INTERMEDIATE TERM STATIONART2-LANE 2-WAY ROADWAY

SCALE: NTS FOR CITY OF ALBANY DEPARTMENT APPROVAL - NOT FOR CONSTRUCTION

**TEMPORARY** 

LANDING

CONSTRUCTION

TEMPORARY FENCING

SCALE: NTS

SIGNAGE COLOR CODE LEGEND

BLACK LEGEND AND BORDER

ON A ORANGE BACKGROUND

R BLACK LEGEND AND BORDER

CODE DESCRIPTION

## THE SEVENTY-SIX

Parcel 76, 76 Second Avenue, City of Albany,

Owner: South End Development LLC

Architect: Garrison-Architects 45 Main Street Brooklyn, NY 11201

WORK ZONE TRAFFIC CONTROL LEGEND

ARROW PANEL

DESCRIPTION

Civil Engineer: The Chazen Companies 547 River St. Troy, NY 12180 p (518) 273-0055 Chazen Project No. 32019.00

Revision Schedule

Revision Number

Revision Description

Revision

Date

### PLANNING SUBMISSION SET

Scale: **AS NOTED** 12/8/2020 Date: 2005 Project No: KC/SM Drawn by: Checked by:

Seal & Signature:



DOB Stamp & Signature


DOB Scan

Drawing Title:


**Work Zone Traffic Control Details &** 


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C-508

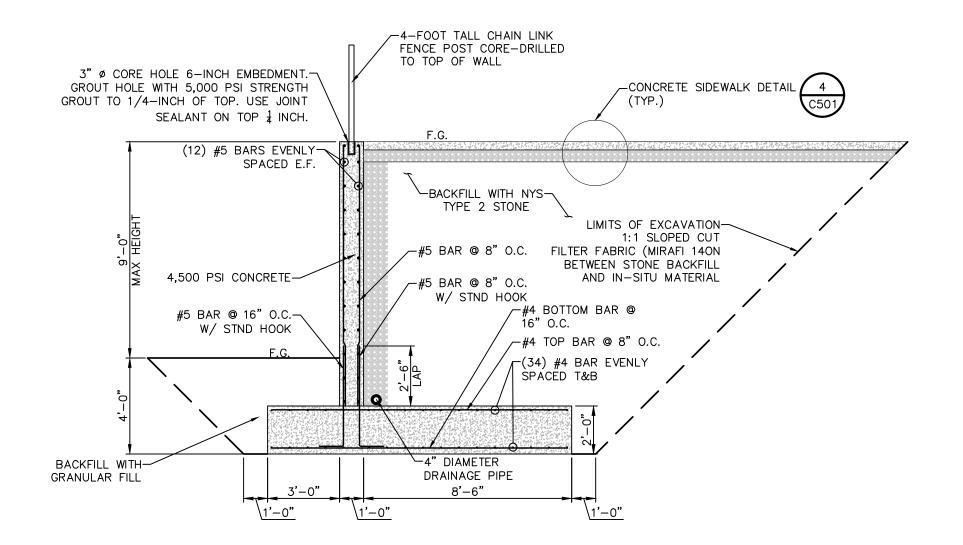


## TYPICAL REINFORCED CAST-IN-PLACE CONRETE RETAINING WALL SECTION



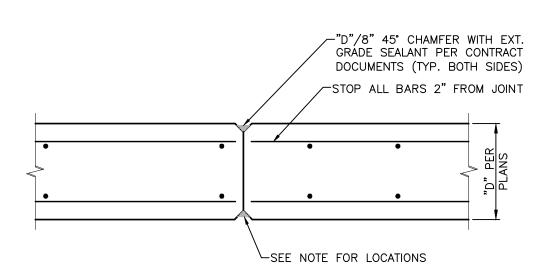

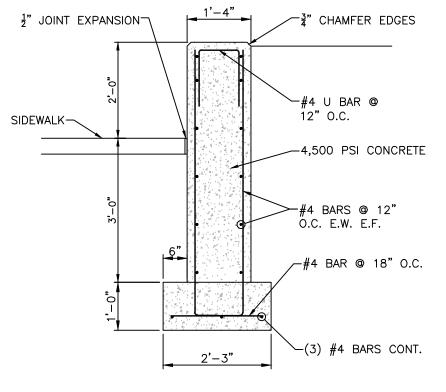2 TYPICAL SEAT WALL SECTION
SCALE: 1/2"=1'-0"

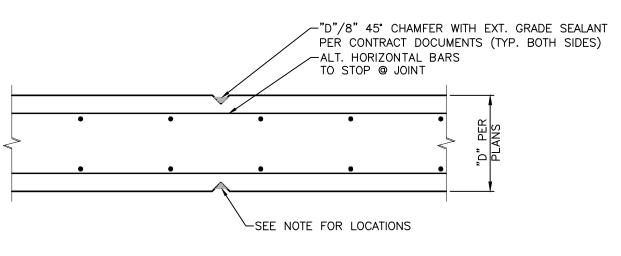


NOTE:


1. CONTRACTION JOINTS IN STEMS SHALL BE PLACED AT THE FOLLOWING:

· 3 TIMES THE HEIGHT OF THE WALL FOR WALL LESS THAN 8 FT.


· AT LEAST THE HEIGHT OF THE WALL FOR WALLS GREATER THAN 12 FT, BUT THE SPACING SHALL NOT EXCEED 25 FEET


· A JOINT SHALL BE PLACED WITHIN 10 TO 15 FEET OF EACH CORNER.

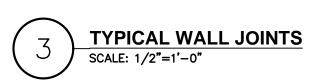

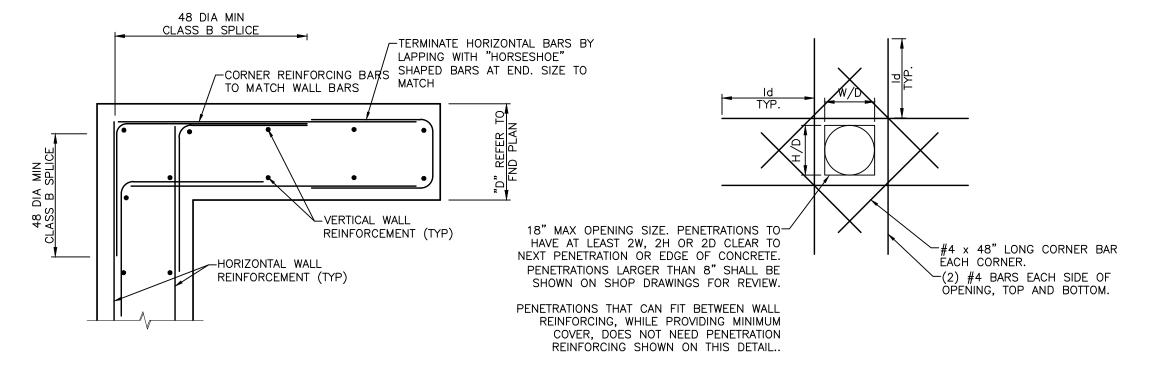

4 TYPICAL CORNER REINFORCEMENT
SCALE: 1/2"=1'-0"

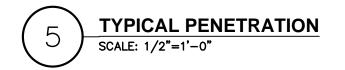

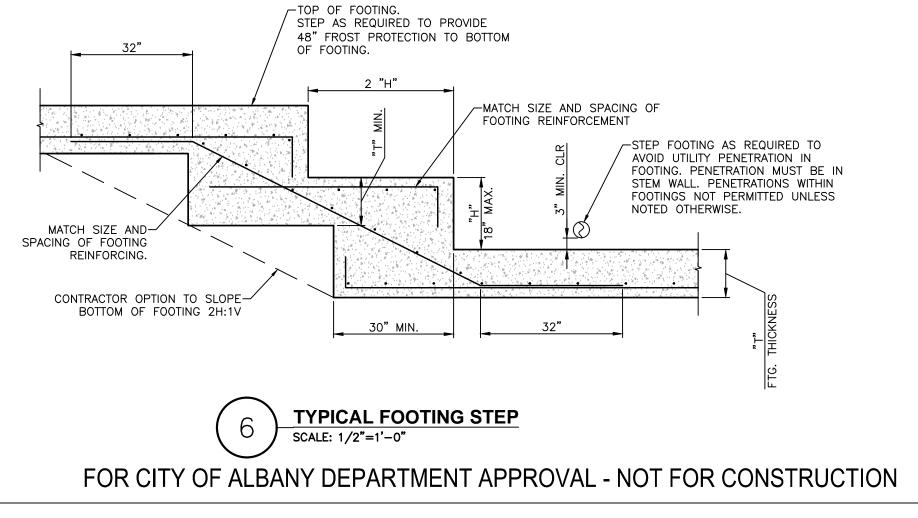

# THE SEVENTY-SIX

Parcel 76, 76 Second Avenue, City of Albany,

Owner: South End Development

Architect: Garrison-Architects 45 Main Street Brooklyn, NY 11201

Civil Engineer: The Chazen Companies 547 River St, Troy, NY 12180 p (518) 273-0055 Chazen Project No. 32019.00

Revision Schedule

Revision Number

Revision Description

Revision Date

PLANNING SUBMISSION SET

Scale: AS NOTED
Date: 12/8/2020
Project No: 2005
Drawn by: KC/SM
Checked by: RK

Seal & Signature:



DOB Stamp & Signature

DOB Scan:

Drawing Title:

Retaining Wall Details

Drawing Number:

C-509