PLANNING SUBMISSION 90 S. SWAN ST.


CONVERSION OF OFFICE BUILDING TO 61-UNIT APARTMENT BUILDING


90 S. SWAN ST. ALBANY NY, 12210

TAX MAP NO. 76.24-7-44


DRAWING LIST:

G001	COVER SHEET
1 OF 1	SURVEY
S101	LANDSCAPE PLAN
S102	UTILITY PLAN
S103	PEDESTRIAN TRAFFIC PLAN
S104	CONSTRUCTION ACCESS PLAN
S105	WORK ZONE TRAFFIC CONTROL
S106	DETAILS
S107	DETAILS
A101	EXISTING FIRST FLOOR PLAN
A102	EXISTING SECOND-FOURTH FLOOR PLA
A200	PROPOSED FIRST FLOOR PLAN
A201	PROPOSED SECOND FLOOR PLAN
A202	PROPOSED THIRD & FOURTH PLAN
A203	PROPOSED ROOF PLAN
A301	EXTERIOR ELEVATIONS

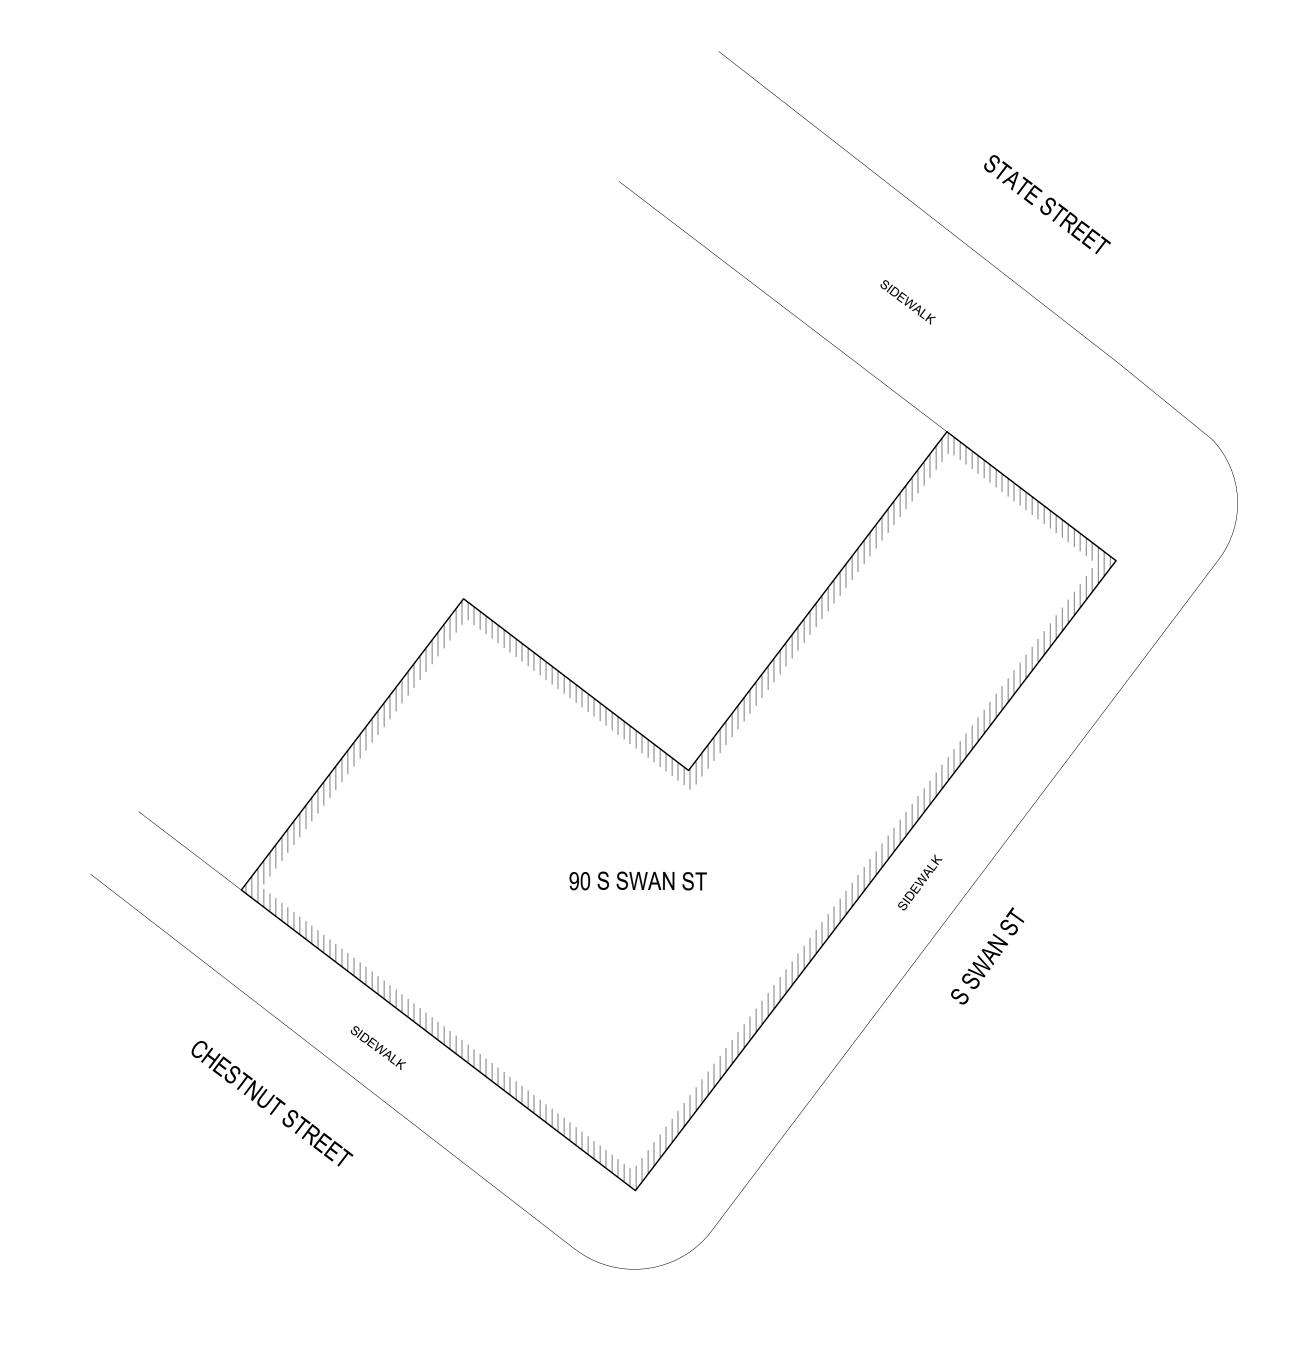

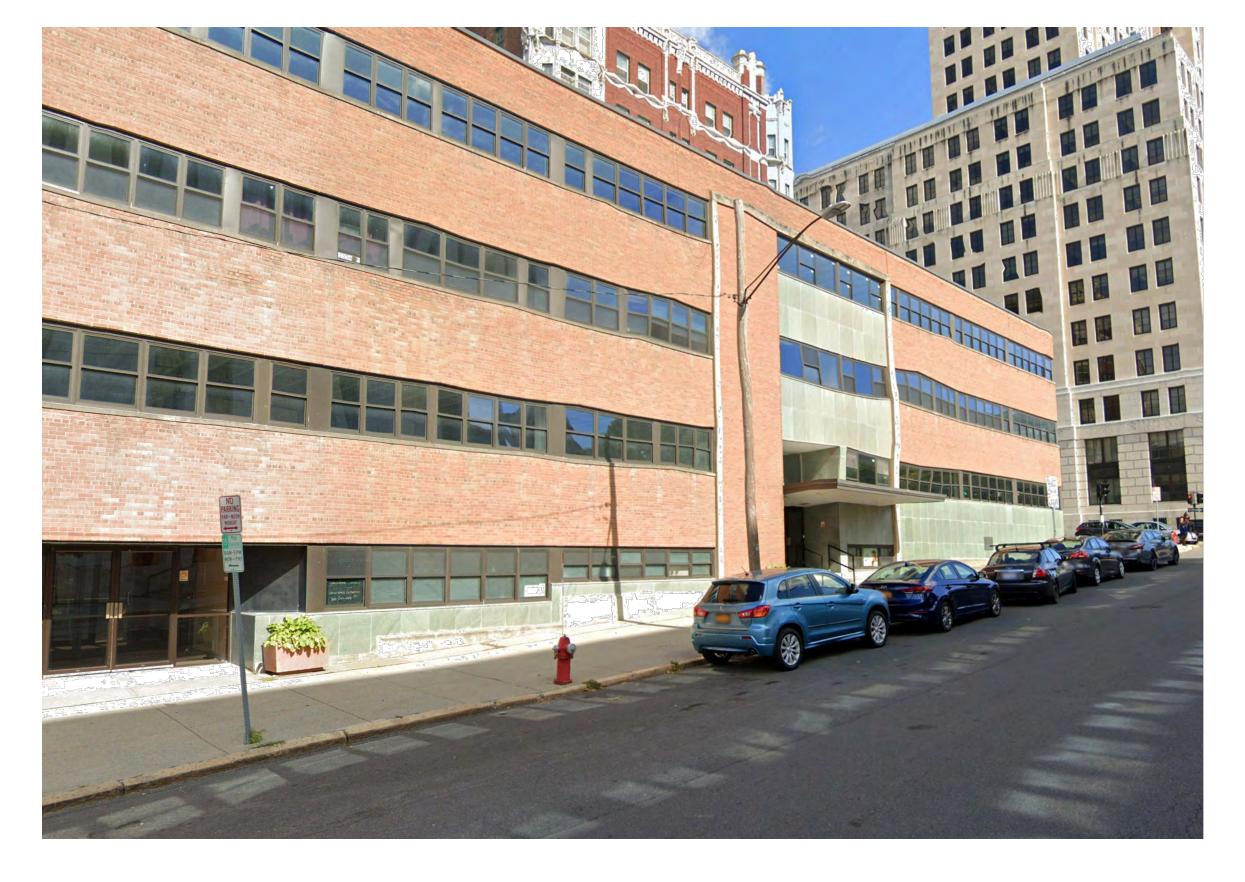

VIEW OF EXISTING BUILDING- S. SWAN STREET SCALE: N.T.S.

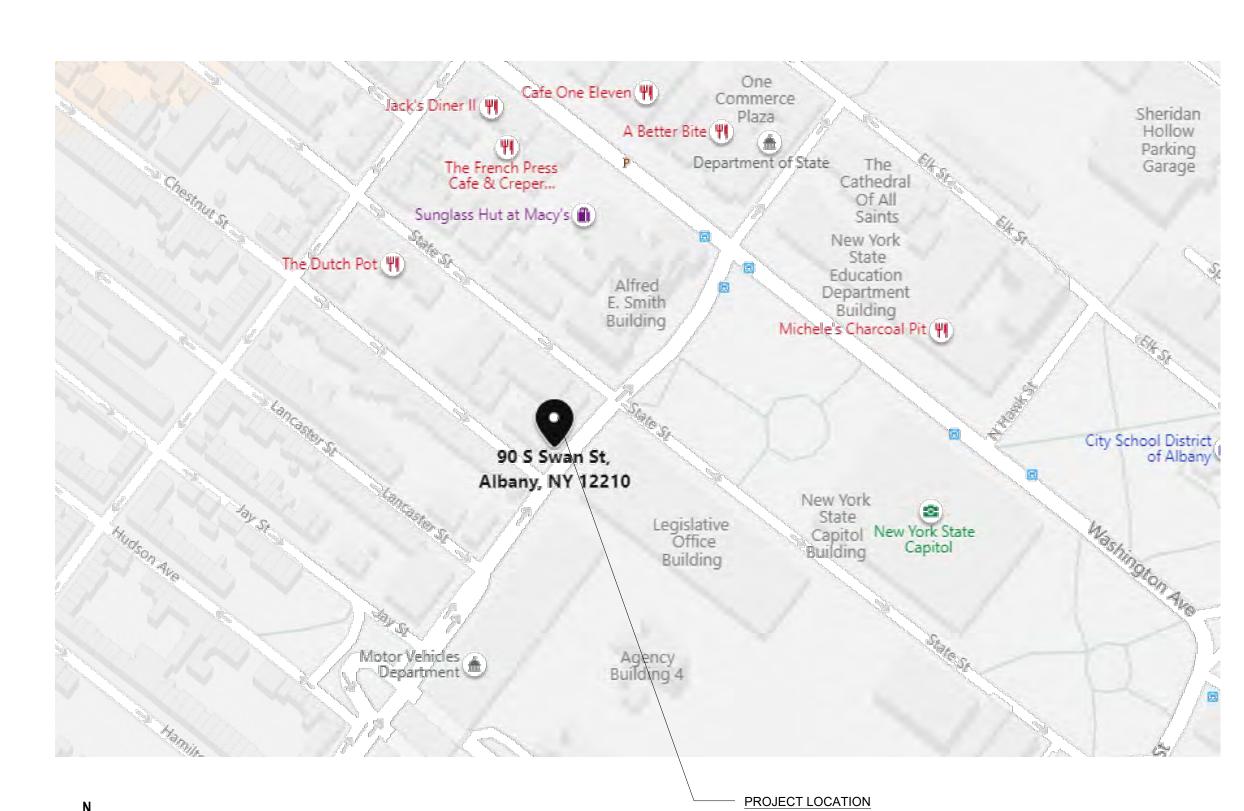





JRS

RICHARD E. NOLAN

NEW YORK STATE LICENSE

333 KINGSLEY ROAD • BURNT

WEBSITE: WWW.NOLAN-ENGINEERING.CO

4			333	WEE		
	BY:	JRS				
RECORD OF WORK:	DESCRIPTION:	1.12.22 RE-SUBMIT PLANNING SET				
	DATE:	1.12.22				

|--|

START DATE:

DATE: 5/19/20

PAGE CONTENT:

COVER SHEET

FILE:

DRAFTER: ENGINEER:
SINGER NOLAN

PAPER SIZE: SCALE:
AS SHOWN

SHEET:

G001

TAX PARCEL IDENTIFICATION

CITY OF ALBANY - COUNTY OF ALBANY - STATE OF NEW YORK SECTION 76.24 - BLOCK 7 - LOT 44 12,576.2± SQUARE FEET

MAP REFERENCE

MAP ENTITLED "MAP OF SURVEY OF LANDS AT 276 STATE STREET FOR ADVANTAGE PROPERTY SERVICES, LLC." PREPARED BY BETHLEHEM LAND SURVEYING PLLC. DATED MAY 26, 2015.

DEED REFERENCE

1. 90 SO. SWAN ST., LLC TO THE SANTO GROUP INC. BY DEED DATED MAY 01, 2013 AND FILED IN THE ALBANY COUNTY CLERK'S OFFICE IN DEED BOOK 3065 AT PAGE 1147.

TITLE REPORT REFERENCE

CERTIFICATE OF TITLE ISSUED BY OLD REPUBLIC NATIONAL TITLE INSURANCE COMPANY, PROVIDED BY LANDMARK ABSTRACT AGENCY LLC., TITLE COMMITMENT NO: LAA1778, EFFECTIVE DATE: OCTOBER 13, 2015.

SCALE 1 INCH = 20 FEET

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SURVEYOR'S NOTES

- 1. SURVEYED FROM RECORD DESCRIPTION AND AS IN POSSESSION.
- 2. SUBJECT TO COVENANTS, EASEMENTS, RESTRICTIONS, CONDITIONS AND AGREEMENTS OF RECORD.
- 3. SURVEY SUBJECT TO ANY UNDERGROUND UTILITIES CROSSING THIS PROPERTY.
- 4. DWELLING SHOWN HEREON SERVED BY UNDERGROUND UTILITIES.
- 5. THE LOCATION OF UNDERGROUND IMPROVEMENTS OR ENCROACHMENTS ARE NOT ALWAYS KNOWN AND OFTEN MUST BE ESTIMATED. LOCATION OF FACILITIES AND/OR STRUCTURES OUTSIDE OF LIMITS OF FIELD SURVEY ARE SUBJECT TO WHATEVER STATE OF FACTS A FIELD SURVEY MAY REVEAL. THEIR LOCATION IS NOT CERTIFIED BY THIS SURVEY.
- 6. CERTIFICATIONS INDICATED HEREON SIGNIFY THAT THIS SURVEY WAS PREPARED IN ACCORDANCE WITH THE EXISTING CODE OF PRACTICE FOR PROFESSIONAL LAND SURVEYORS AS ADOPTED BY THE NEW YORK STATE ASSOCIATION OF PROFESSIONAL LAND SURVEYORS. SAID CERTIFICATIONS ARE NOT TRANSFERABLE TO ADDITIONAL INSTITUTIONS, THEIR SUCCESSORS AND/OR ASSIGNS, OR SUBSEQUENT OWNERS.
- 7. NORTH ORIENTATION AND BEARINGS SHOWN HEREON ARE BASED ON MAP
- 8. PRINTED DIMENSIONS SHOWN ON THE MAP OF SURVEY SUPERSEDE SCALED DIMENSIONS. SOME ITEMS MAY HAVE BEEN DRAWN OUT OF SCALE TO GRAPHICALLY SHOW THEIR LOCATION.

Lands Now or Formerly of CAPITAL_SQUARE PROPERTIES LLC . 1/1 1/1 1/1 . Book 2998 Page 656 ORIGINAL SCALE IN INCHES Section 76.24 Block 7 Lot 45 67 CHESTNUT STREET 3 STORY BRICK BUILDING ,80.00' (deed) // // // // // // // CHESTNUT · N 37°09'40" E ‱ 81.37' (SURVEY) Lands Now or Formerly of RSA PROPERTIES LLC Book 2959 Page 258 Section 76.24 Block 7 Lot 43 248 STATE STREET ر. ک. ک 8 STORY BRICK BUILDING TREET ASPHALT PAVEMEN CONCRETE ∠SIDEWALK CONCRETE WALL CONCRETE 4 4 N 37°09'40" E 101.50 101.50' (SURVEY) [⊬]√ (deed) 17.2'± 3 STORY BRICK BUILDING 244 STATE STREET & 90 SOUTH SWAN STREET 17.1'± [⊲] . *TS* . "181.50' (SURVEY) " S 37°09'46"4W 181.50' (deed)

LEGEND

C

E

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TS

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V

TSP O

SUBJECT PROPERTY LINE

ADJACENT PROPERTY LINE **FENCE**

OVERHEAD WIRES

SQUARE CATCH BASIN

DECIDUOUS TREE

ELECTRIC MANHOLE

TELEPHONE MANHOLE

TRAFFIC SIGNAL CONTROL BOX

TRAFFIC SIGNAL POLE

UTILITY POLE

GUY WIRE

WATER SHUT OFF VALVE

WATER VALVE

HYDRANT

CONCRETE SURFACE

PORCH/COVERED AREA

WOOD SURFACE


BLACKTOP SURFACE

SO. SWAN STREET

CERTIFIED TO: MAN REALTY LLC, SHARESTATES INVESTMENTS, LLC, AMTRUST TITLE INSURANCE COMPANY and ATLANTIS NATIONAL SERVICES, INC.

DRAWN BY: JRP DATE FIELD SURVEY COMPLETED: NOV. 4, 2015 CHECKED BY: JRP DATE SURVEY MAP COMPLETED: JOB NO.: 2015-155 NOV. 4, 2015 1 07/19/18 UPDATED SURVEY, REVISED CERTIFICATIONS J.R.P. NO. DATE:

Jason R. Peterson, PLS 273 KENWOOD AVENUE DELMAR, NEW YORK 12054 (518) 813-0059

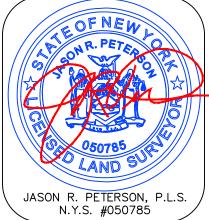

UNAUTHORIZED ALTERATION OR ADDITION TO A SURVEY MAP BEARING ADDITION TO A SURVEY MAP BEARING A LICENSED LAND SURVEYOR'S SEAL IS A VIOLATION OF SECTION 7209, SUBDIVISION 2 OF THE NEW YORK STATE EDUCATION LAW. ONLY COPIES MADE FROM THE ORIGINAL OF THIS DRAWING BEARING AN ORIGINAL INKED OR EMBOSSED SEAL AND SIGNATURE SHALL BE CONSIDERED TO BE VALID TRUE COPIES. I HEREBY CERTIFY THAT THIS SURVEY MAP IS BASED ON AN ACTUAL FIELD SURVEY CONDUCTED ON NOV. 4, 2015 AND THAT THIS SURVEY MAP WAS MADE BY ME OR UNDER MY DIRECTION, AND CONFORMS WITH THE MINIMUM STANDARD OF PRACTICE ADOPTED BY STANDARD OF PRACTICE ADOPTED BY THE NEW YORK STATE ASSOCIATION OF PROFESSIONAL LAND SURVEYORS.


MAP OF SURVEY OF


Lands at 244 State Street & 90 So. Swan Street


- SITUATE -


CITY OF ALBANY ALBANY COUNTY


NEW YORK

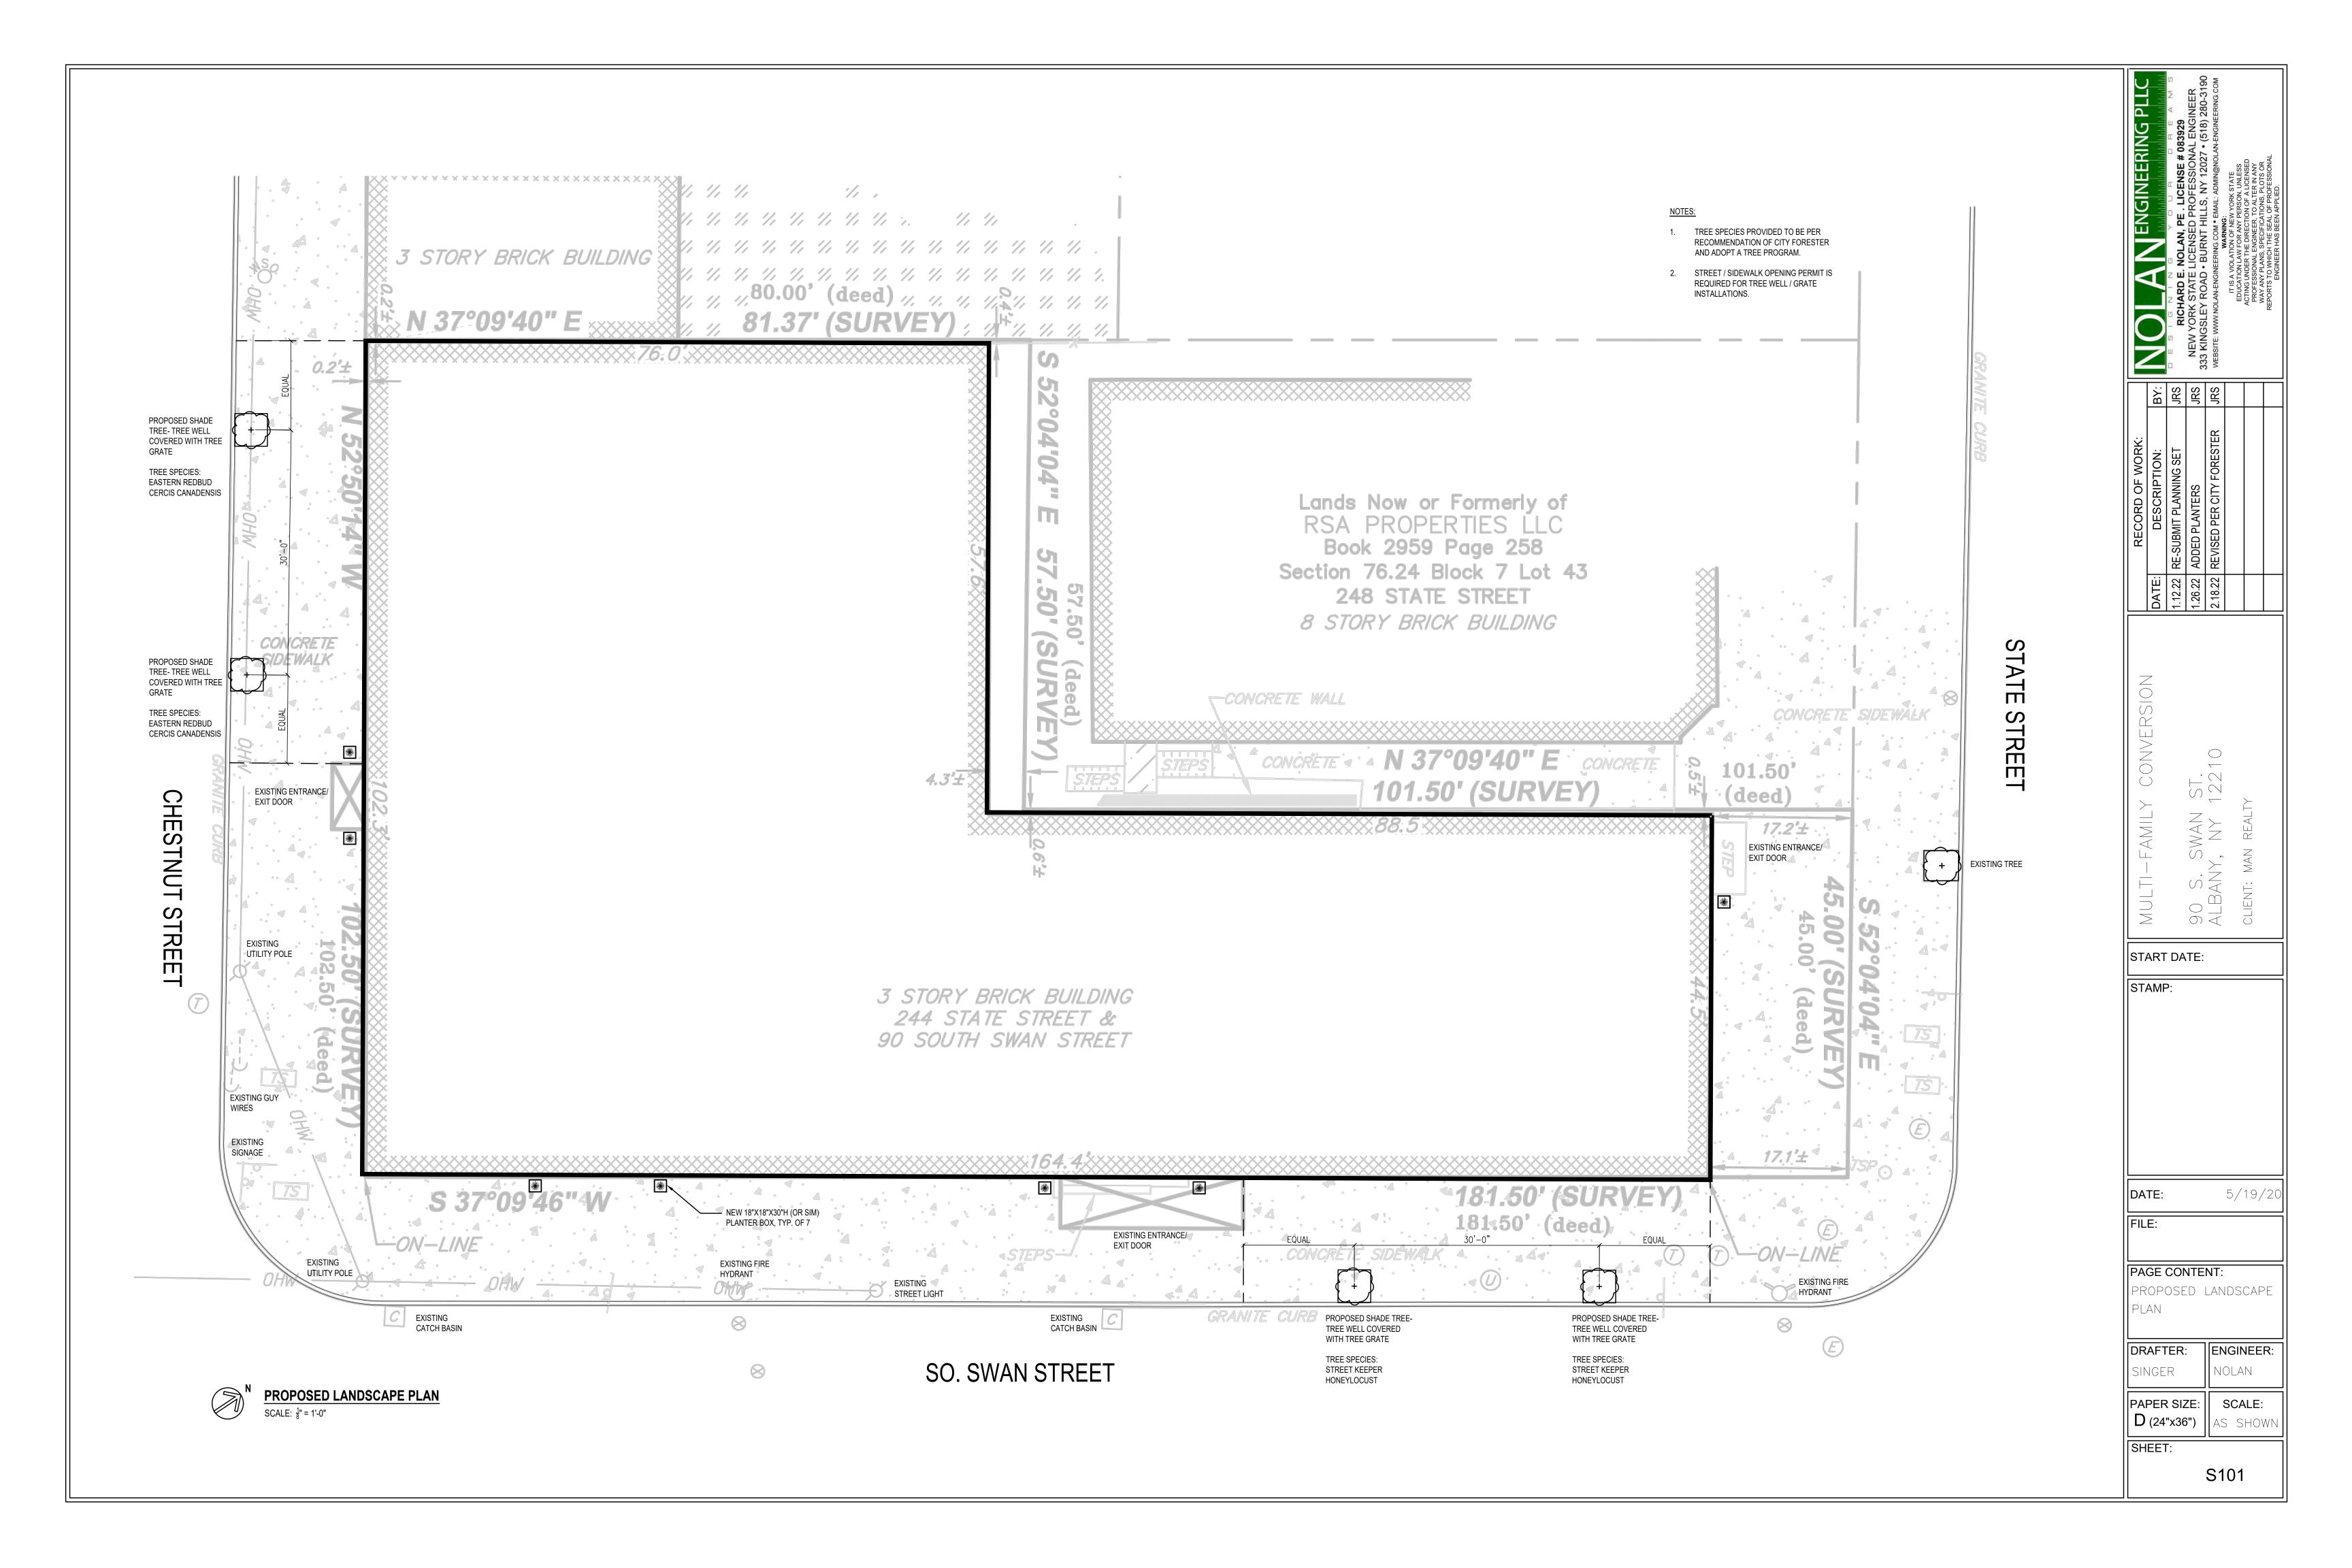


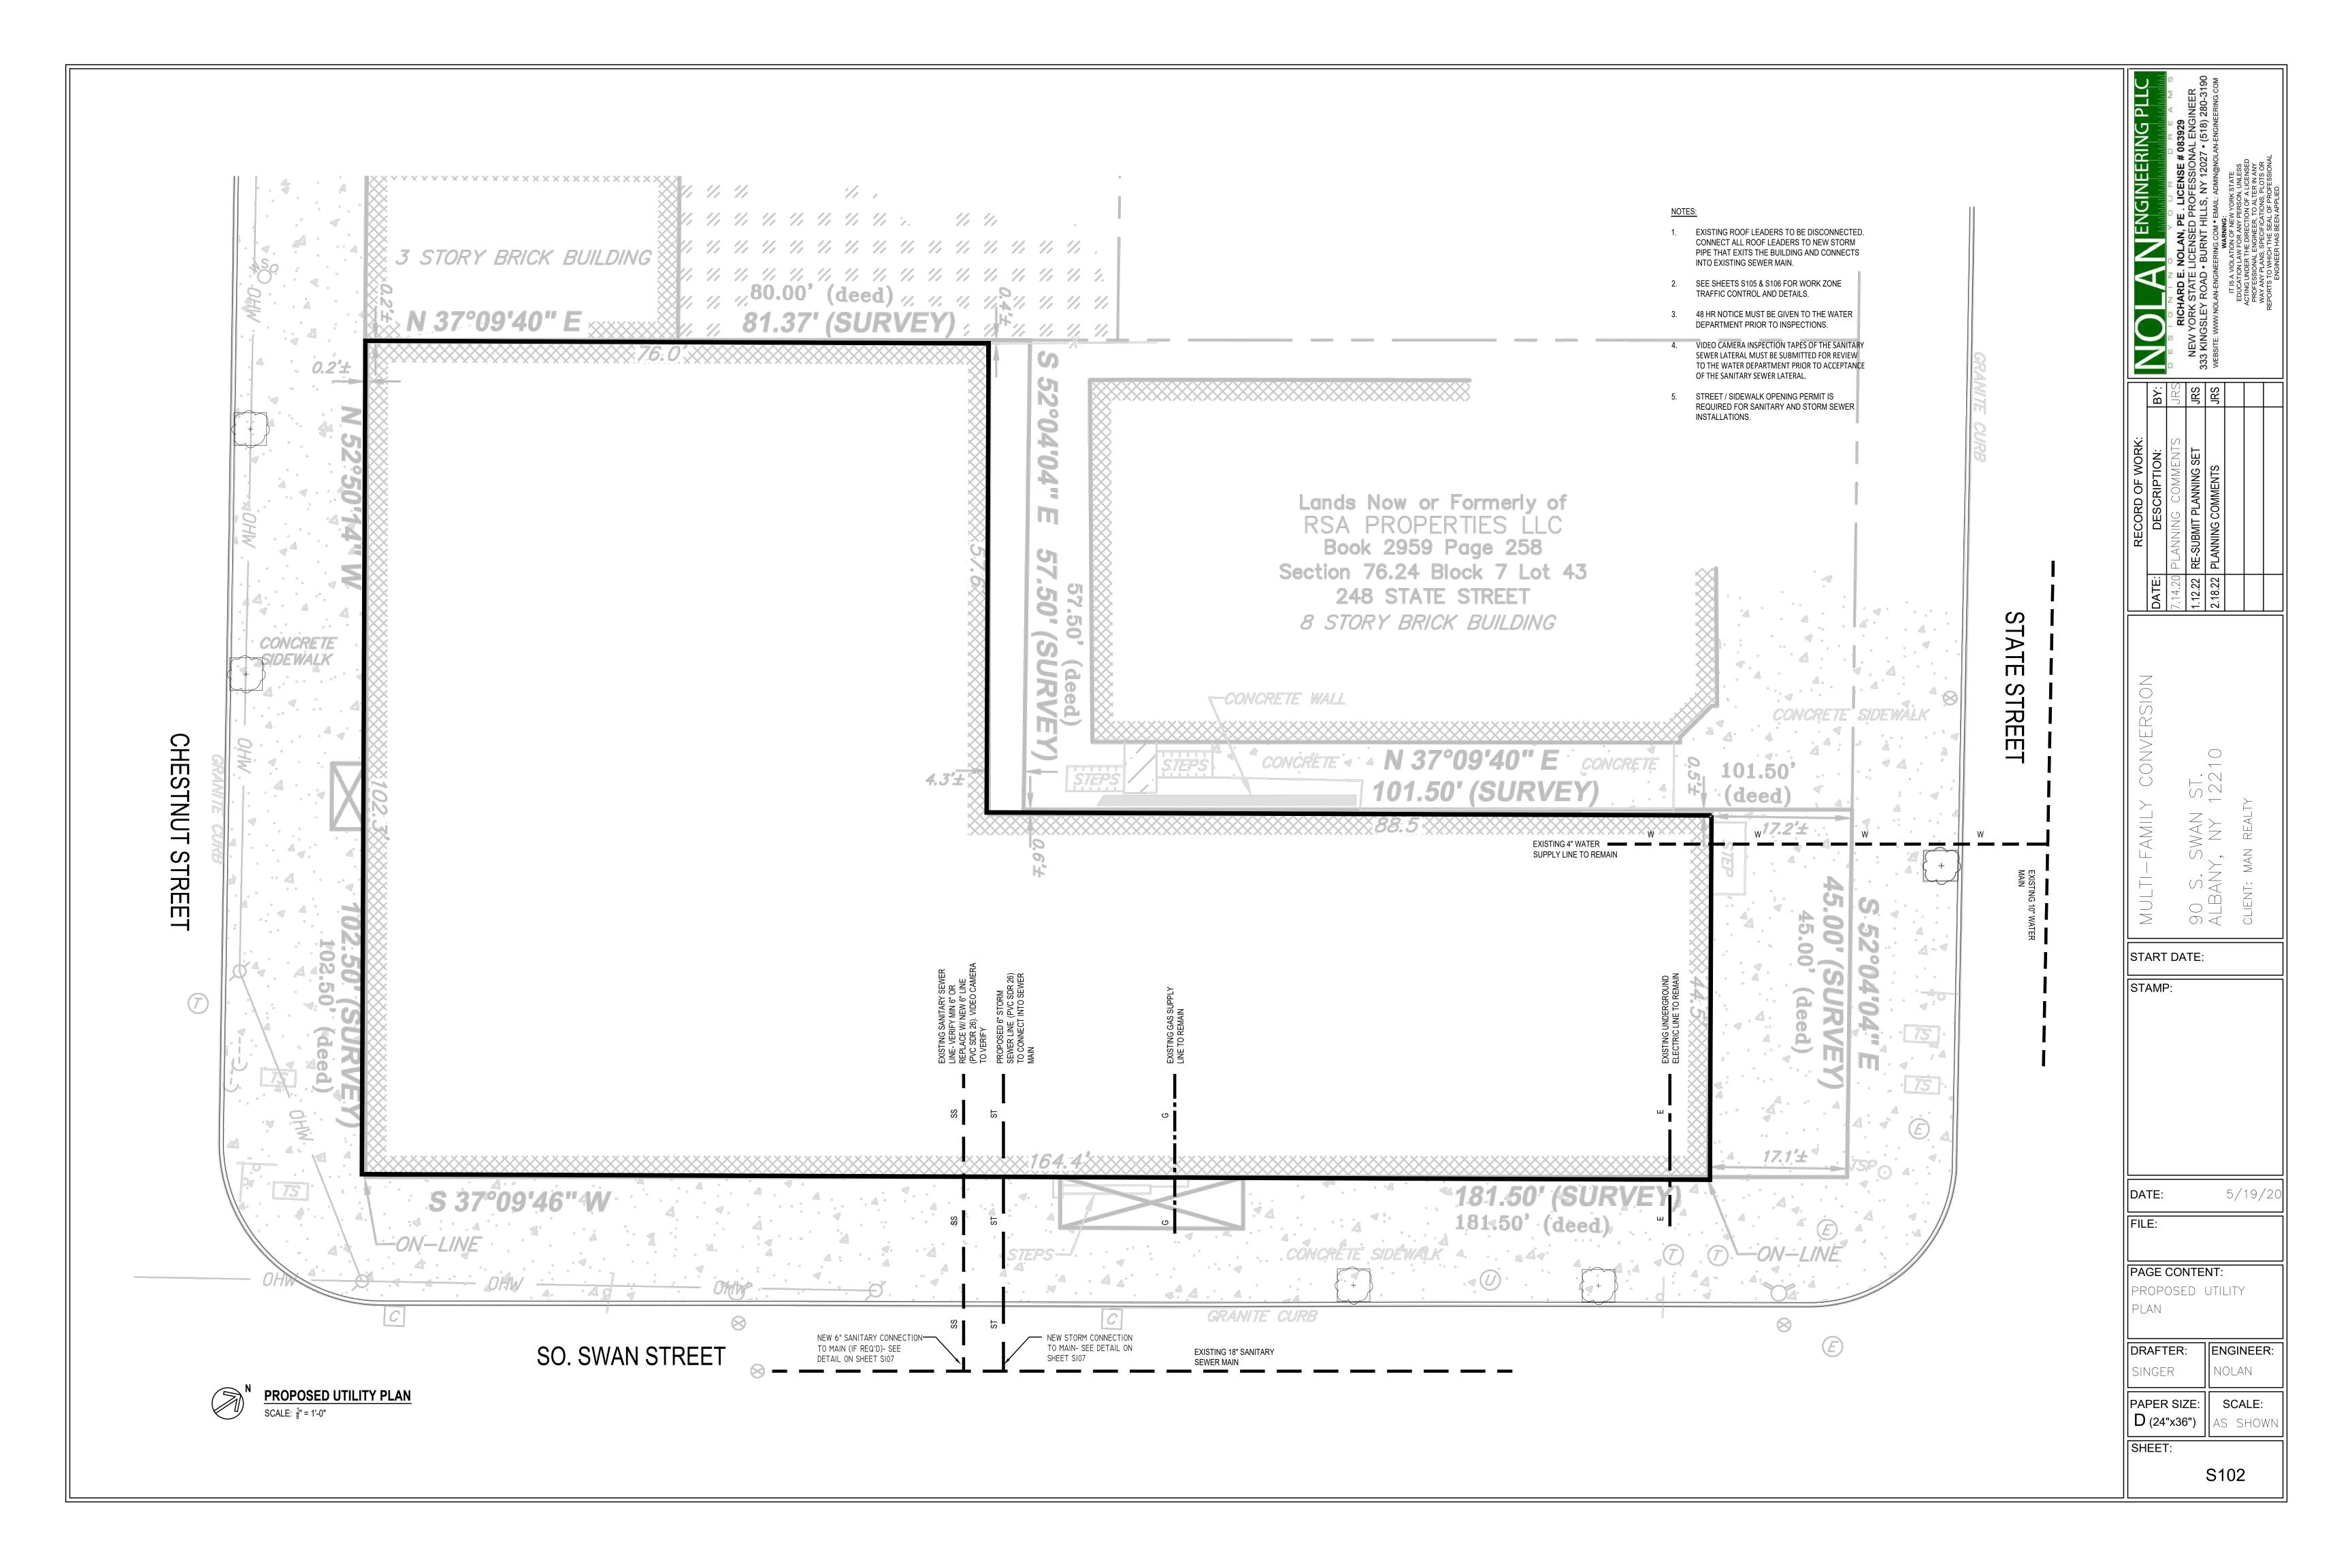

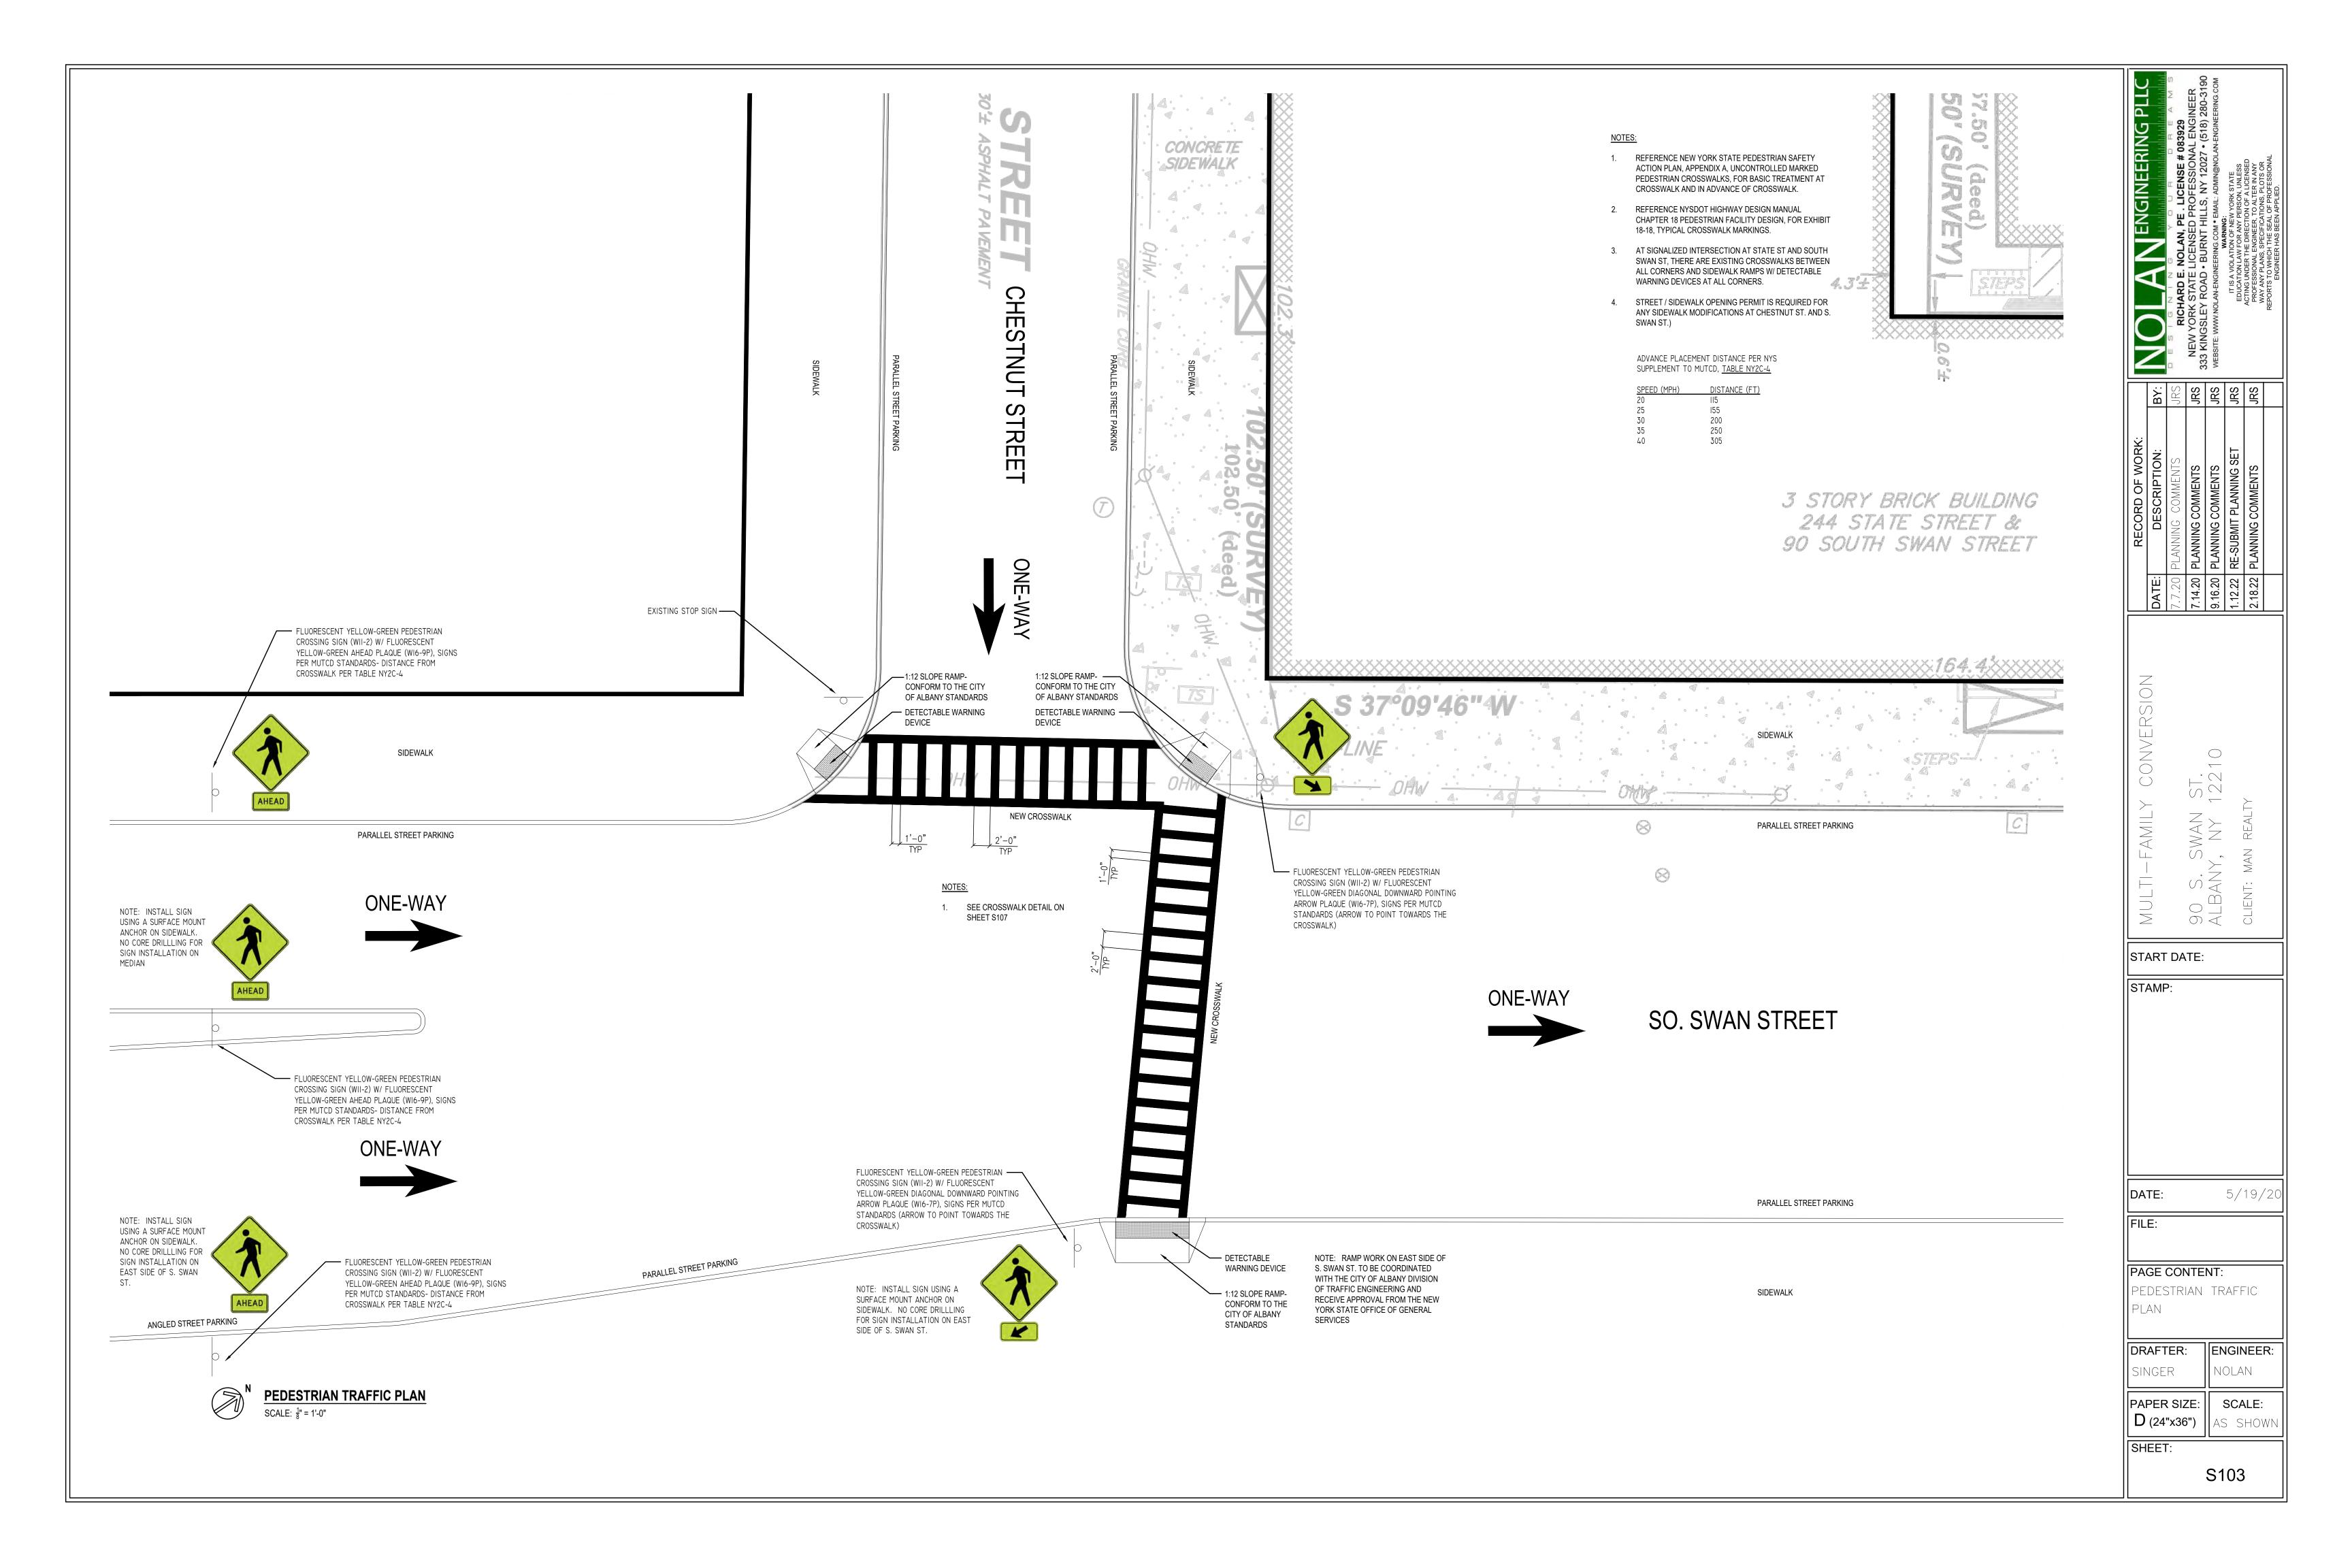

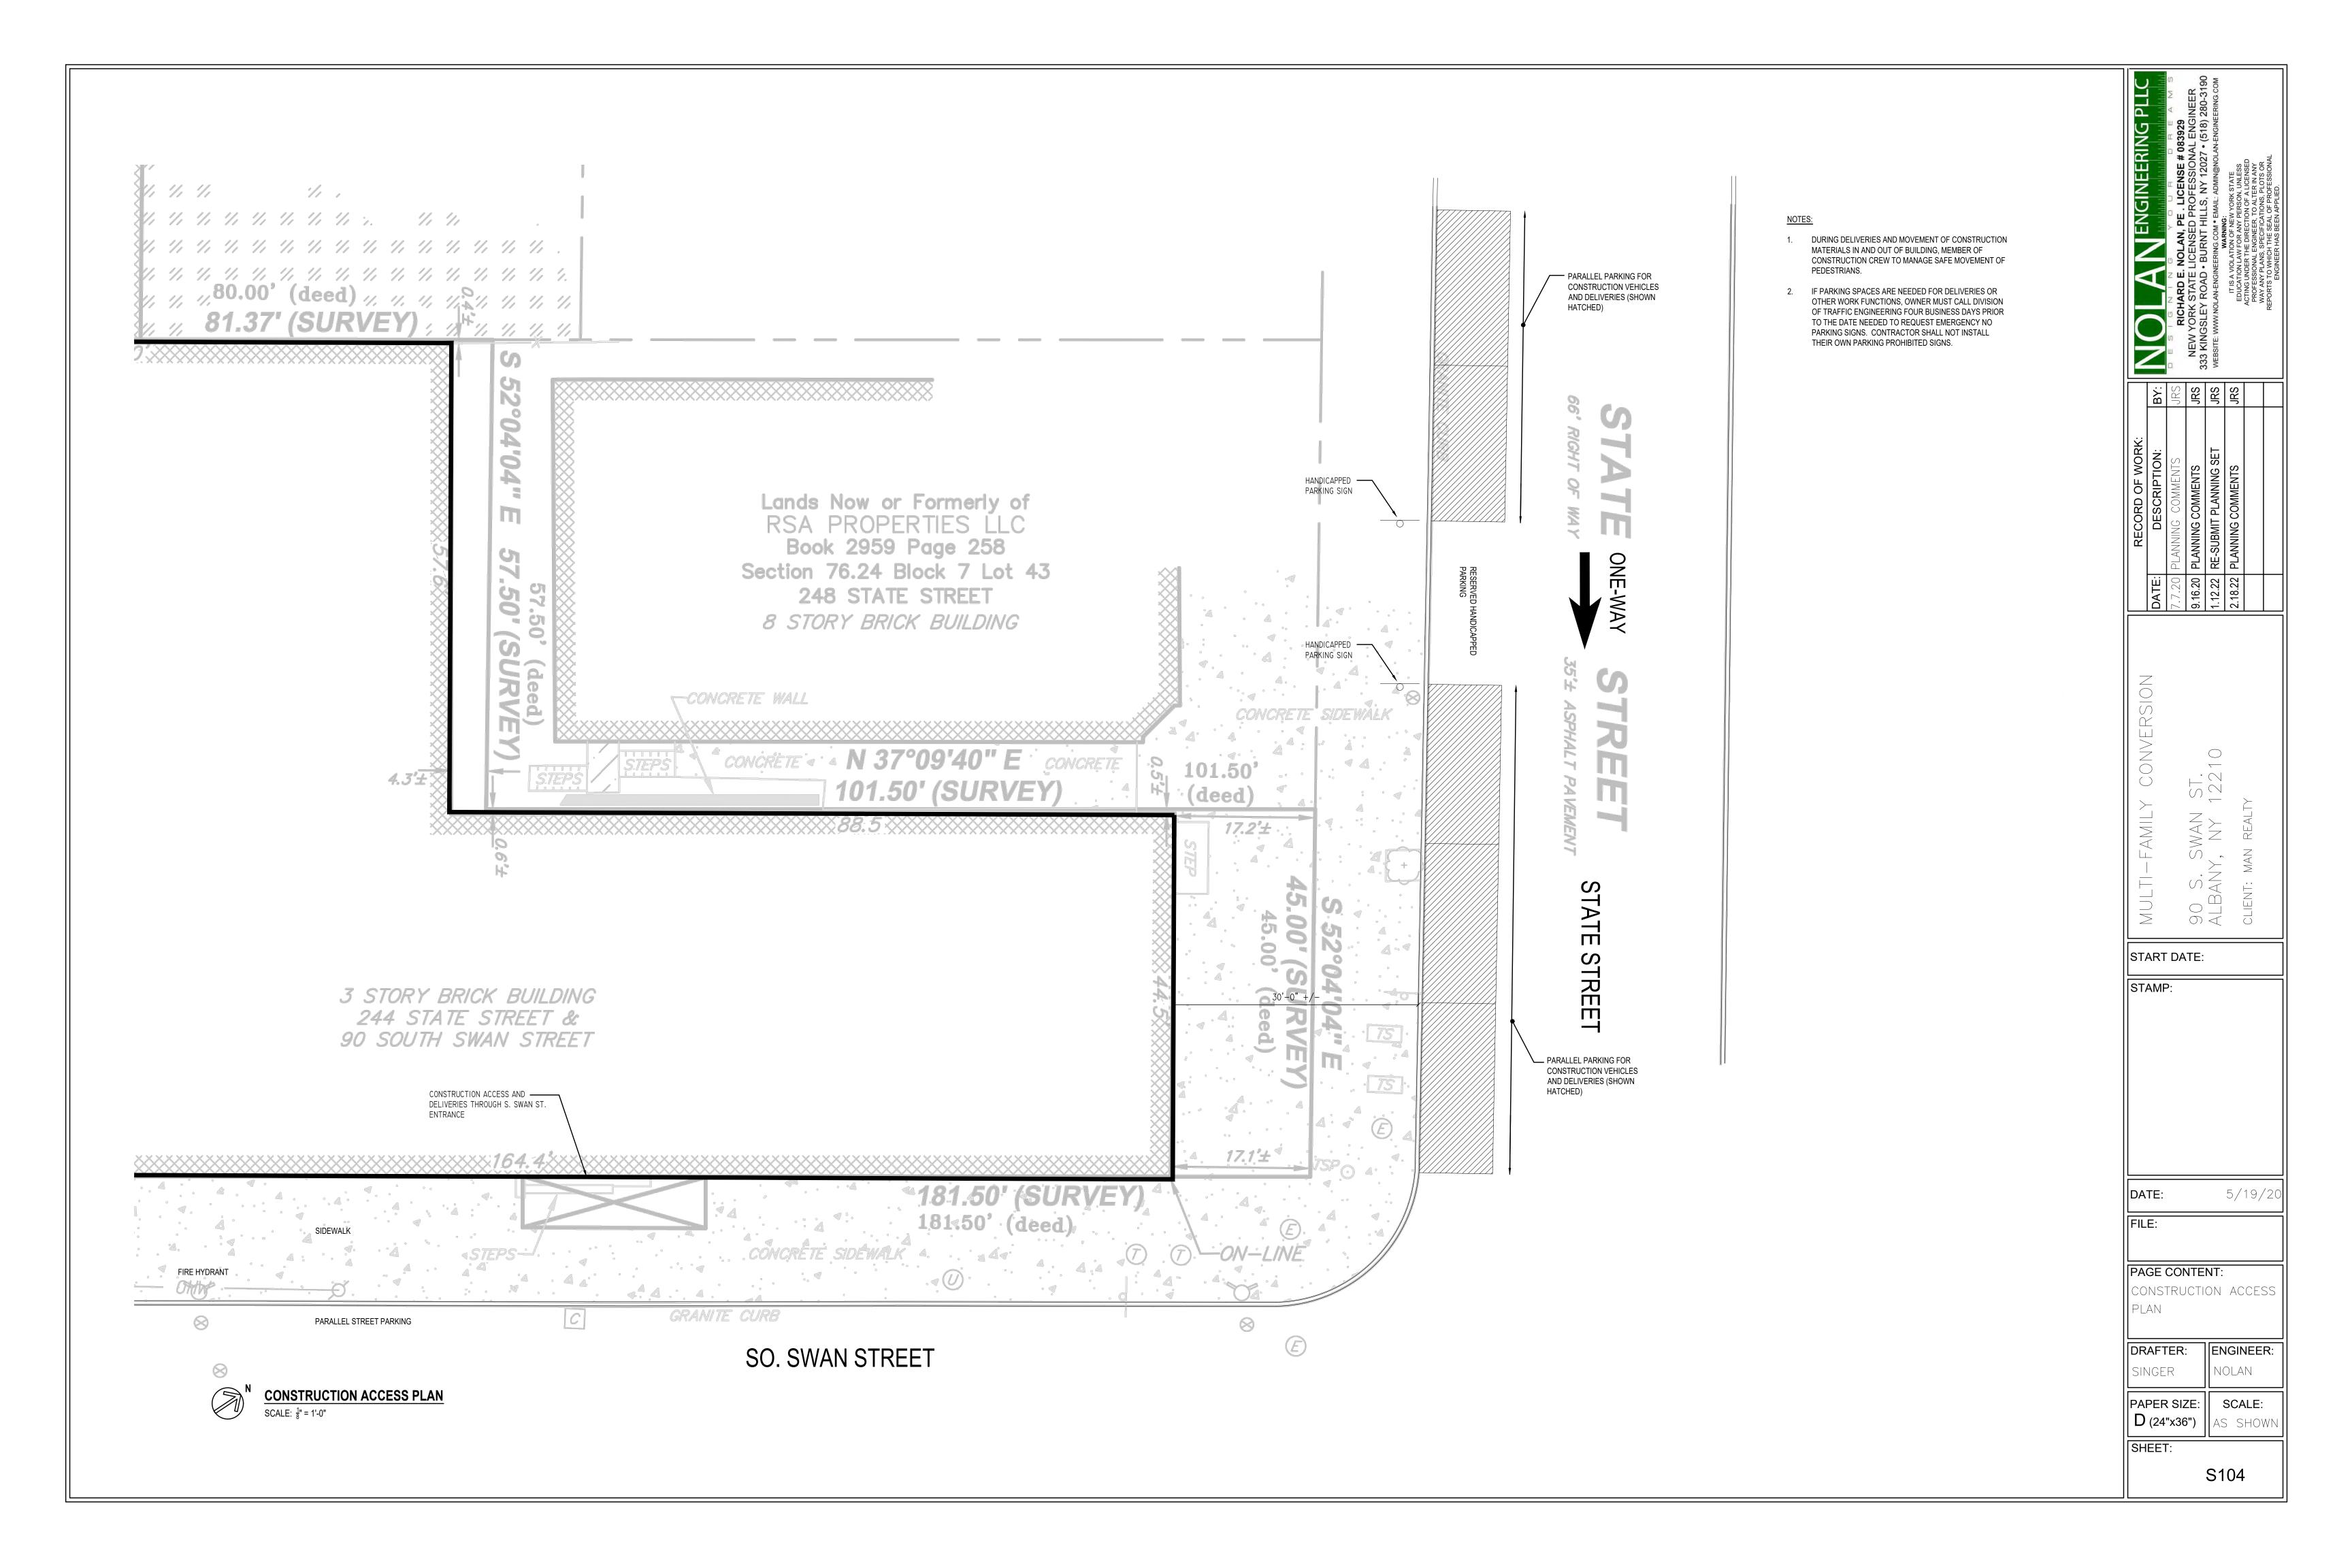

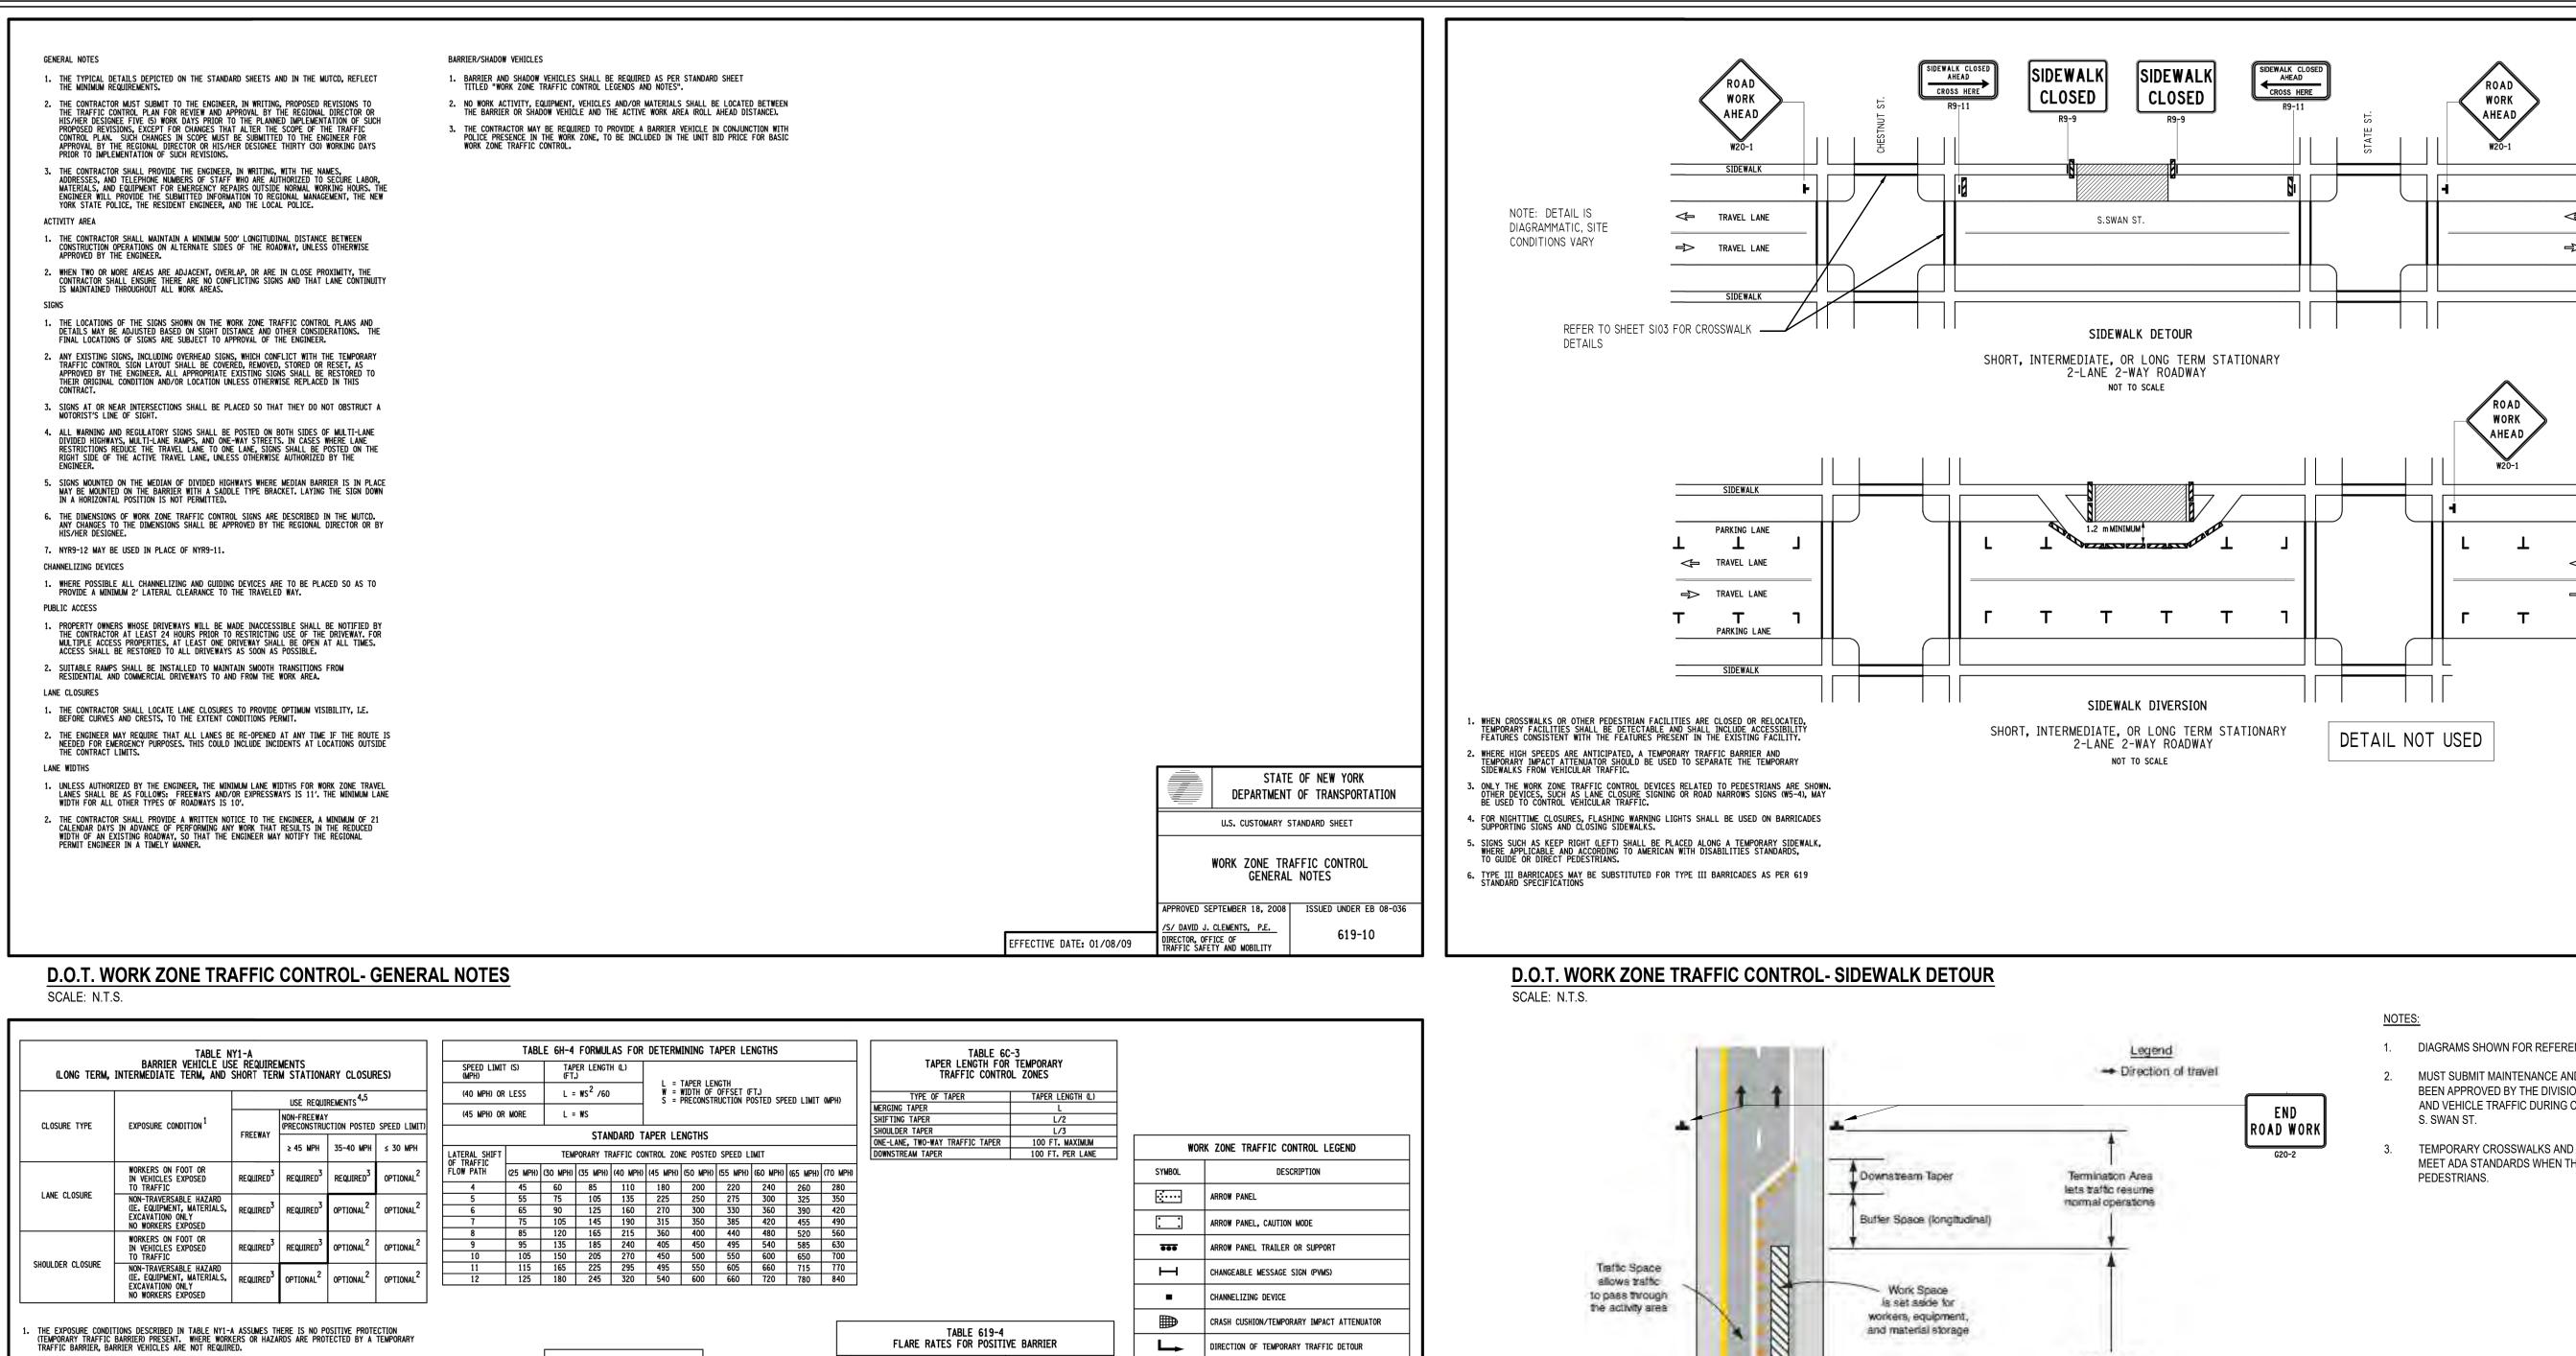

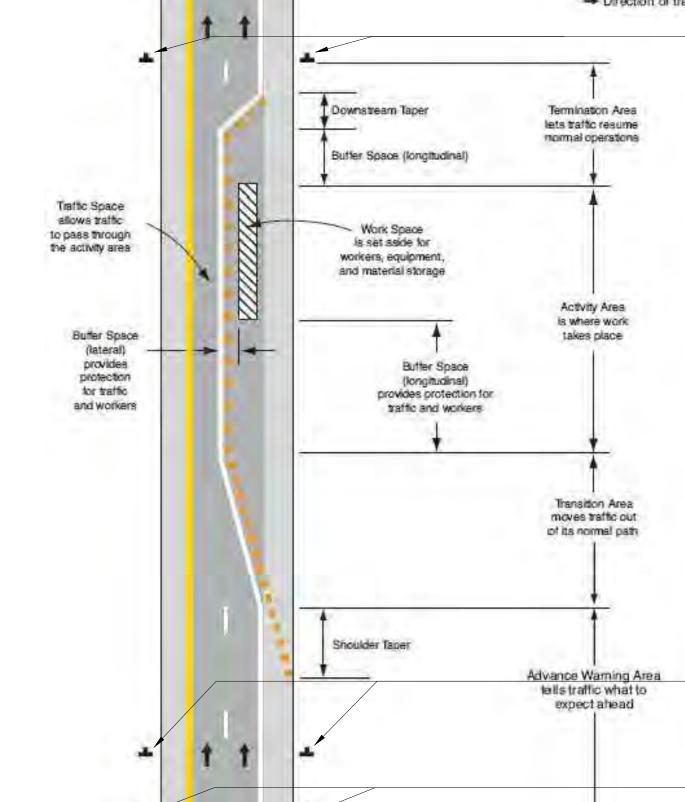

D.O.T. WORK ZONE TRAFFIC CONTROL- ONE LANE CLOSURE

SCALE: $\frac{1}{8}$ " = 1'-0"

1. DIAGRAMS SHOWN FOR REFERENCE. ACTUAL SITE CONDITIONS MAY VARY.

SEE LEGEND & TABLES STANDARD SHEET (M619-11) FOR LEGEND OF SYMBOLS AND/OR LETTER CODES USED IN THIS DRAWING.

ALL DIMENSIONS IN METERS UNLESS OTHERWISE NOTED

WORK ZONE TRAFFIC CONTROL SIDEWALK DETOUR OR DIVERSION

DEPUTY CHIEF ENGINEER

STATE OF NEW YORK

DEPARTMENT OF TRANSPORTATION

- MUST SUBMIT MAINTENANCE AND PROTECTION OF TRAFFIC PLAN THAT HAS BEEN APPROVED BY THE DIVISION OF TRAFFIC ENGINEERING FOR PEDESTRIAN AND VEHICLE TRAFFIC DURING CONSTRUCTION, AND FOR THE SEWER TIE IN AT
- TEMPORARY CROSSWALKS AND SIDEWALK CLOSURES MUST BE IN PLACE AND MEET ADA STANDARDS WHEN THE S. SWAN ST. SIDEWALKS ARE CLOSED TO

APPROVED MAY 16, 2008 ISSUED UNDER EB 08-006 $\bigcirc \bigcirc \triangleleft$ START DATE: STAMP: DATE: |FILE: PAGE CONTENT: WORK ZONE TRAFFIC CONTROL DRAFTER: SINGER

. A MOBILE CLOSURE SHALL BE USED FOR ANY WORK ACTIVITY THAT MOVES CONTINUOUSLY OR INTERMITTENTLY ALONG THE TRAVELED WAY OR SHOULDER SLOWER THAN THE PREVAILING SPEED OF TRAFFIC. CHANNELIZING DEVICES ARE NOT USED FOR MOBILE CLOSURES. SHADOW VEHICLES SHALL BE EQUIPPED WITH AN APPROVED REAR MOUNTED ATTENUATOR (TRUCK MOUNTED OR TRAILER MOUNTED) FOR THE FOLLOWING MOBILE CLOSURES: LANE CLOSURES ON FREEWAYS, LANE CLOSURES ON NON-FREEWAY ROADWAYS HAVING A PRE-CONSTRUCTION POSTED SPEED LIMIT OF 35 MPH OR MORE, SHOULDER CLOSURES ON FREEWAYS, AND SHOULDER CLOSURES ON NON-FREEWAY ROADWAYS HAVING A PRE-CONSTRUCTION SPEED LIMIT OF 45 MPH OR MORE.

. WHERE THE REQUIREMENT IS "OPTIONAL", EITHER A BARRIER VEHICLE OR THE STANDARD LONGITUDINAL BUFFER SPACE (TABLE 6C-2) SHALL BE PROVIDED.

3. REQUIREMENTS SHALL INCLUDE PROVIDING A SEPARATE BARRIER VEHICLE FOR EACH CLOSED LANE AND EACH CLOSED PAVED SHOULDER 8' OR GREATER IN WIDTH. IF THE WORK SPACE MOVES WITHIN THE STATIONARY CLOSURE, THE BARRIER VEHICLE SHALL BE REPOSITIONED ACCORDINGLY. BARRIER VEHICLES PROTECTING NON-TRANSVERSABLE HAZARDS SHALL REMAIN IN PLACE DURING BOTH WORKING AND NON-WORKING HOURS UNTIL THE HAZARD NO LONGER EXISTS. EXCEPTIONS TO THESE REQUIREMENTS MAY BE MADE, AS APPROVED BY THE REGIONAL DIRECTOR OR HIS/HER DESIGNEE WHERE BARRIER VEHICLE PLACEMENT WOULD BE INEFFECTIVE OR WOULD INTERFERE WITH THE SAFE OPERATION OF TRAFFIC.

BARRIER VEHICLES ARE NOT REQUIRED FOR MILLING AND/OR PAYING OPERATIONS, BUT THE STANDARD LONGITUDINAL BUFFER SPACE (TABLE 6C-2) SHALL BE PROVIDED.

5. BARRIER VEHICLES ARE NOT REQUIRED FOR FLAGGING OPERATIONS, BUT THE STANDARD LONGITUDINAL BUFFER SPACE (TABLEGC-2) SHALL BE PROVIDED.

TABLE NY1-B SHADOW VEHICLE USE REQUIREMENTS (MOBILE CLOSURES)

WHEN ANY WORKER, VEHICLE, OR OTHER HAZARD IS EXPOSED TO TRAFFIC REQUIRED^{2,4} REQUIRED^{2,4} REQUIRED^{2,4} REQUIRED^{2,4}

WHEN ANY WORKER, VEHICLE, OR OTHER HAZARD IS EXPOSED TO TRAFFIC REQUIRED^{2,4} REQUIRED^{2,4} REQUIRED^{2,4} REQUIRED^{2,4}

EXPOSURE CONDITION

CLOSURE TYPE

LANE CLOSURE

3. FOR MOBILE LANE CLOSURES ON NON-FREEWAY ROADWAYS HAVING A PRE-CONSTRUCTION POSTED SPEED LIMIT OF 30 MPH OR LESS AND MOBILE SHOULDER CLOSURES ON NON-FREEWAY ROADWAYS HAVING A PRE-CONSTRUCTION SPEED LIMIT OF 40 MPH OR LESS, SHADOW VEHICLES ARE NOT REQUIRED TO BE EQUIPPED WITH A REAR MOUNTED ATTENUATOR. . A SHADOW VEHICLE IS USED TO PROTECT EXPOSED WORKERS (ON FOOT OR IN A VEHICLE) AND SHALL BE REQUIRED FOR ALL MOBILE CLOSURES. SHADOW VEHICLE REQUIREMENTS SHALL INCLUDE PROVIDING A SEPARATE SHADOW VEHICLE FOR EACH CLOSED LANE AND EACH CLOSED PAVED SHOULDER 8' OR GREATER IN WIDTH. ADDITIONAL SHADOW VEHICLES MAY BE REQUIRED TO PROMOTE THE SAFE OPPRATION OF TRAFFIC AND THE INCREASED PROTECTION OF EXPOSED WORKERS, AS DIRECTED BY THE REGIONAL DIRECTOR OR HIS/HER DESIGNEE.

TABLE 6C-2 LONGITUDINAL BUFFER SPACE PRECONSTRUCTION DISTANCE POSTED SPEED LIMIT (MPH)

TABLE NY2-A
PLACEMENT DISTANCE FOR BARRIER VEHICLES PRECONSTRUCTION
POSTED

BARRIER VEHICLES*

SPEED LIMIT
(MPH)

MINIMUM MAXIMUM MINIMUM MAXIMUM

> 55 100 FT. 200 FT. 100 FT. 200 FT.

45 - 55 100 FT. 200 FT. 85 FT. 165 FT.

< 45 85 FT. 165 FT. 50 FT. 100 FT. * AS DEFINED IN NYSDOT STANDARD SPECIFICATION 619:

MINIMUM DISTANCE SHOWN REFLECTS THE ACTUAL ROLL AHEAD DISTANCE FROM MANUFACTURER.

MINIMUM DISTANCE SHOWN REFLECTS THE ACTUAL ROLL AHEAD DISTANCE FROM MANUFACTURER.

TABLE NY2-B
PLACEMENT DISTANCE FOR SHADOW VEHICLES PLACEMENT DISTANCE (FT.)
POSTED SHADOW VEHICLES**

(18000 LBS.) (24000 LBS.)

MINIMUM MAXIMUM MINIMUM MAXIMUM

> 55 230 FT. 330 FT. 180 FT. 280 FT.

45 - 55 180 FT. 280 FT. 150 FT. 250 FT.

< 45 100 FT. 200 FT. 100 FT. 200 FT. PRECONSTRUCTION
POSTED
SPEED LIMIT (1800
(MPH) MINIMIM * AS DEFINED IN NYSDOT STANDARD SPECIFICATION 619: SHADOW VEHICLE - VEHICLE USED FOR MOBILE OR SHORT DURATION WORK OPERATIONS.

WORK DURATION DEFINITIONS LONG-TERM STATIONARY IS WORK THAT OCCUPIES A LOCATION MORE THAN 3 CONSECUTIVE DAYS. INTERMEDIATE-TERM STATIONARY IS WORK THAT OCCUPIES A LOCATION MORE THAN ONE DAYLIGHT PERIOD UP TO 3 CONSECUTIVE DAYS, OR NIGHTTIME WORK LASTING MORE THAN 1 HOUR. SHORT-TERM STATIONARY IS DAYTIME WORK THAT OCCUPIES A LOCATION FOR MORE THAN 1 HOUR WITHIN A SINGLE DAYLIGHT PERIOD. SHORT DURATION IS WORK THAT OCCUPIES A LOCATION UP TO 1 HOUR. MOBILE IS WORK THAT MOVES INTERMITTENTLY OR CONTINUOUSLY.

TABLE 619-4 FLARE RATES FOR POSITIVE BARRIER

TABLE NY6H-3

ADVANCE WARNING SIGN SPACING

URBAN (≤ 30 MPH*) 100 100 100 AHEAD AHEAD
URBAN (35-40 MPH*) 200 200 200 AHEAD AHEAD
URBAN (≥ 45 MPH*) 350 350 350 1000 FT. AHEAD
RURAL 500 500 500 1500 FT. 1000 FT.

EXPRESSWAY / FREEWAY 1000 1500 2640 1 MILE ½ MILE

URBAN: (MEETS MORE THAN 1 OF THE FOLLOWING CRITERIA)
SIDEWALKS, BICYCLE USAGE, CURBING, CLOSED DRAINAGE SYSTEMS,
DRIVEWAY DENSITIES GREATER THAN 24 DRIVEWAYS PER MILE, MINOR
COMMERCIAL DRIVEWAY DENSITIES OF 10 DRIVEWAYS PER MILE OR
GREATER, MAJOR COMMERCIAL DRIVEWAYS, NUMEROUS RIGHT OF WAY
CONSTRAINTS, HIGH DENSITY OF CROSS STREETS, 85TH PERCENTILE
SPEEDS OF 45 MPH OR LESS.

RURAL: ANY AREA NOT EXHIBITING MORE THAN ONE OF THE ABOVE CHARACTERISTICS.

* PRECONSTRUCTION POSTED SPEED LIMIT

DISTANCE BETWEEN SIGNS SIGN LEGEND

A (FT.) B (FT.) C (FT.) XX YY

EXPRESSWAY: DIVIDED HIGHWAYS FOR TRAFFIC WITH FULL OR PARTIAL CONTROL OF ACCESS AND GENERALLY WITH GRADE SEPARATIONS AT MAJOR CROSSROADS. WORK VEHICLE WORK VEHICLE WITH TRUCK MOUNTED ATTENUATOR FREEWAYS/INTERSTATE: LOCAL OR INTER REGIONAL HIGH-SPEED, DIVIDED, HIGH-VOLUME FACILITIES WITH FULL OR PARTIAL CONTROL OF ACCESS. STATE OF NEW YORK DEPARTMENT OF TRANSPORTATION U.S. CUSTOMARY STANDARD SHEET WORK ZONE TRAFFIC CONTROL LEGENDS AND NOTES APPROVED SEPTEMBER 18, 2008 | ISSUED UNDER EB 08-036 S/ DAVID J. CLEMENTS, P.E. DIRECTOR, OFFICE OF TRAFFIC SAFETY AND MOBILITY

DIRECTION OF TEMPORARY TRAFFIC DETOUR

DIRECTION OF TRAFFIC

PAVEMENT MARKINGS THAT SHALL BE REMOVED FOR A LONG TERM PROJECT

TEMPORARY BARRIER WITH WARNING LIGHTS

○► TRAFFIC OR PEDESTRIAN SIGNAL

 \Rightarrow

■ FLAGGER

● LUMINAIRE

FLAG TREE

SIGN, TEMPORARY TEMPORARY BARRIER

TYPE III BARRICADE

WORK SPACE

EFFECTIVE DATE: 01/08/09

D.O.T. WORK ZONE TRAFFIC CONTROL- LEGENDS & NOTES SCALE: $\frac{1}{8}$ " = 1'-0"

NON-FREEWAY (PRECONSTRUCTION POSTED SPEED LIMIT

≥ 45 MPH | 35-40 MPH | ≤ 30 MPH

1. LEFT LANE CLOSURES ARE SYMMETRICAL TO RIGHT LANE CLOSURES. SUBSTITUTE LEFT LANE CLOSED SIGN (W20-5) AND THE CORRESPONDING LANE ENDS SIGN (W4-2L). 2. NO WORK ACTIVITY, EQUIPMENT, OR STORAGE OF VEHICLES, OR MATERIAL SHALL OCCUR WITHIN THE BUFFER SPACE AT ANY TIME.

(SEE NOTE 1)

RIGHT LANE CLOSED YY

(SEE NOTE 1)

ROAD

WORK

AHEAD

CHANNELIZING DEVICE SPACING (CENTER TO CENTER) SHALL NOT EXCEED 12 m IN THE ACTIVE WORK SPACE.

TRANSVERSE DEVICES SHALL BE REQUIRED (AS PER 619 STANDARD SPECIFICATIONS) WHEN A PAVED SHOULDER HAVING A WIDTH OF 2.4 m OR GREATER IS CLOSED FOR A DISTANCE GREATER THAN 450 m.

5. FOR BARRIER VEHICLE USE REQUIREMENTS SEE TABLES NY1-A AND NY2-A ON THE LEGEND AND TABLES DRAWING (M619-11).

6. WHEN PAYED SHOULDERS HAVING A WIDTH OF 2.4 m OR MORE ARE CLOSED, CHANNELIZING DEVICES SHALL BE USED TO CLOSE THE SHOULDER IN ADVANCE TO DELINEATE THE BEGINNING OF THE WORK SPACE AND TO DIRECT VEHICULAR TRAFFIC TO REMAIN IN THE TRAVELED WAY.

D (24"x36") SHEET:

PAPER SIZE:

S105


||ENGINEER:


NOLAN


SCALE:

AS SHOWN

5/19/2

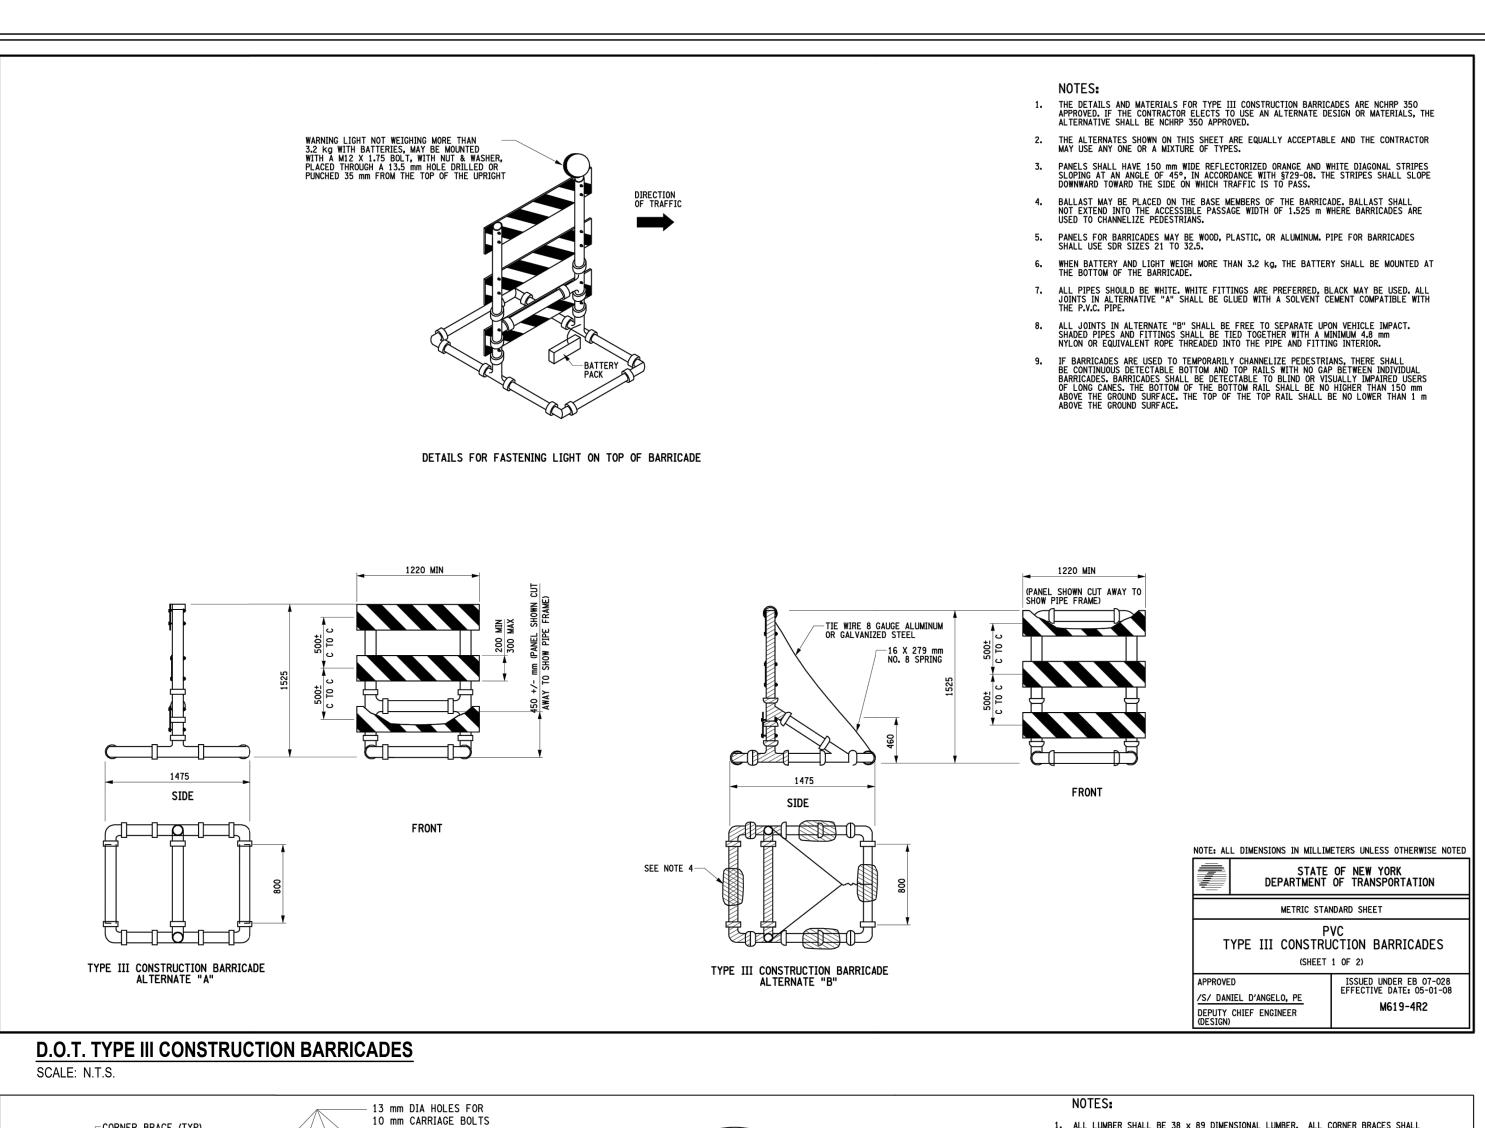


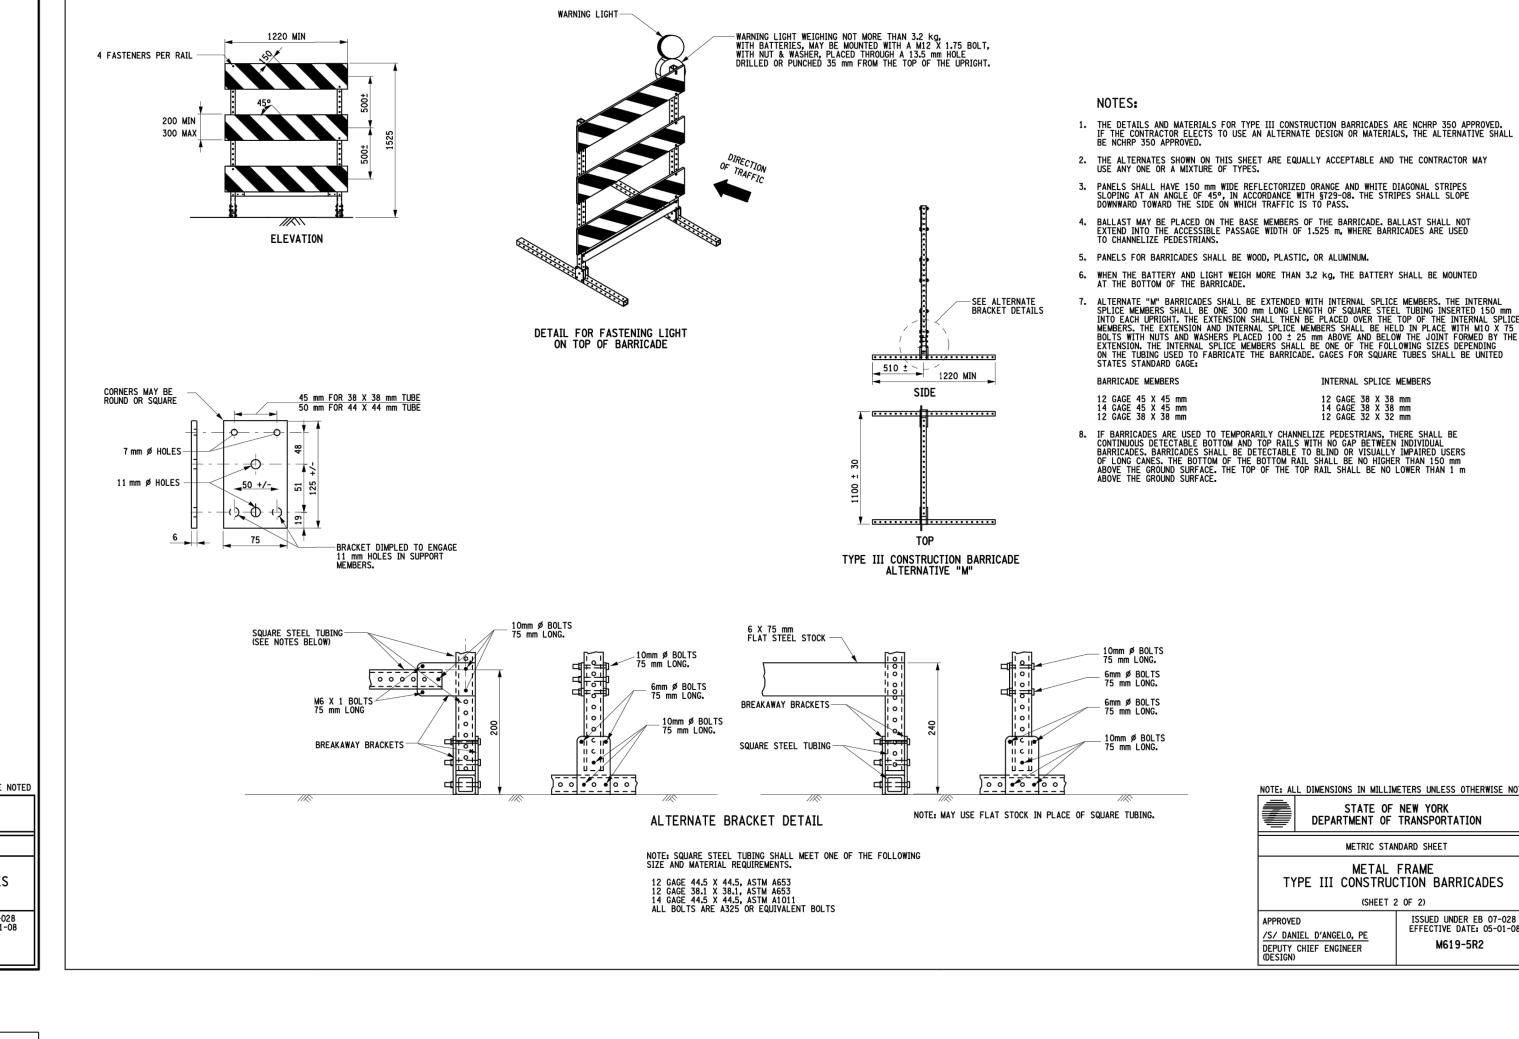

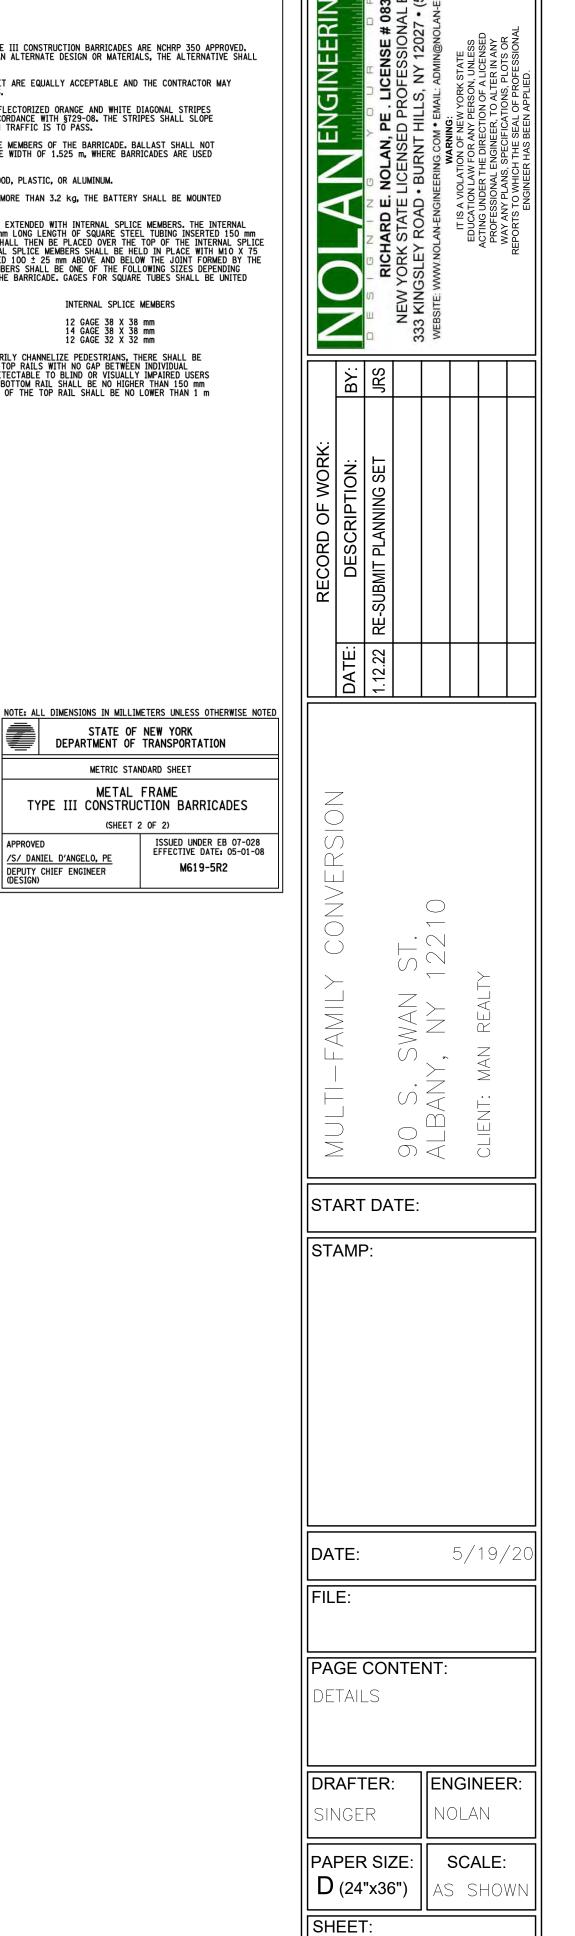

S106

DEPUTY CHIEF ENGINEER (DESIGN)

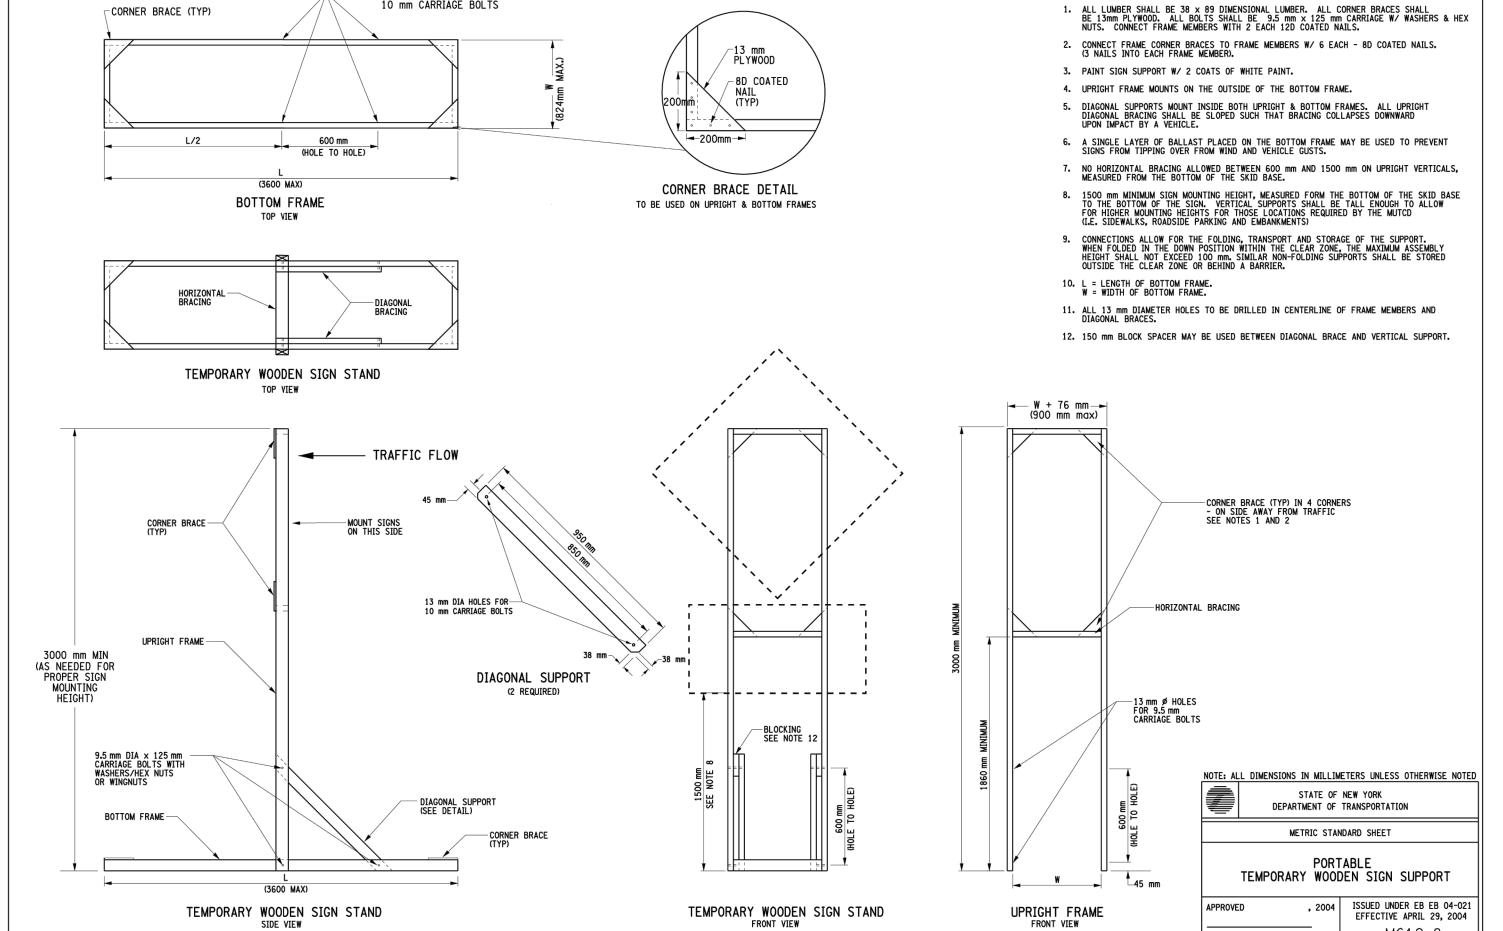



D.O.T. PORTABLE TEMPORARY WOODEN SIGN SUPPORT

SCALE: $\frac{1}{8}$ " = 1'-0"

DEPUTY CHIEF ENGINEER (DESIGN)

M619-8

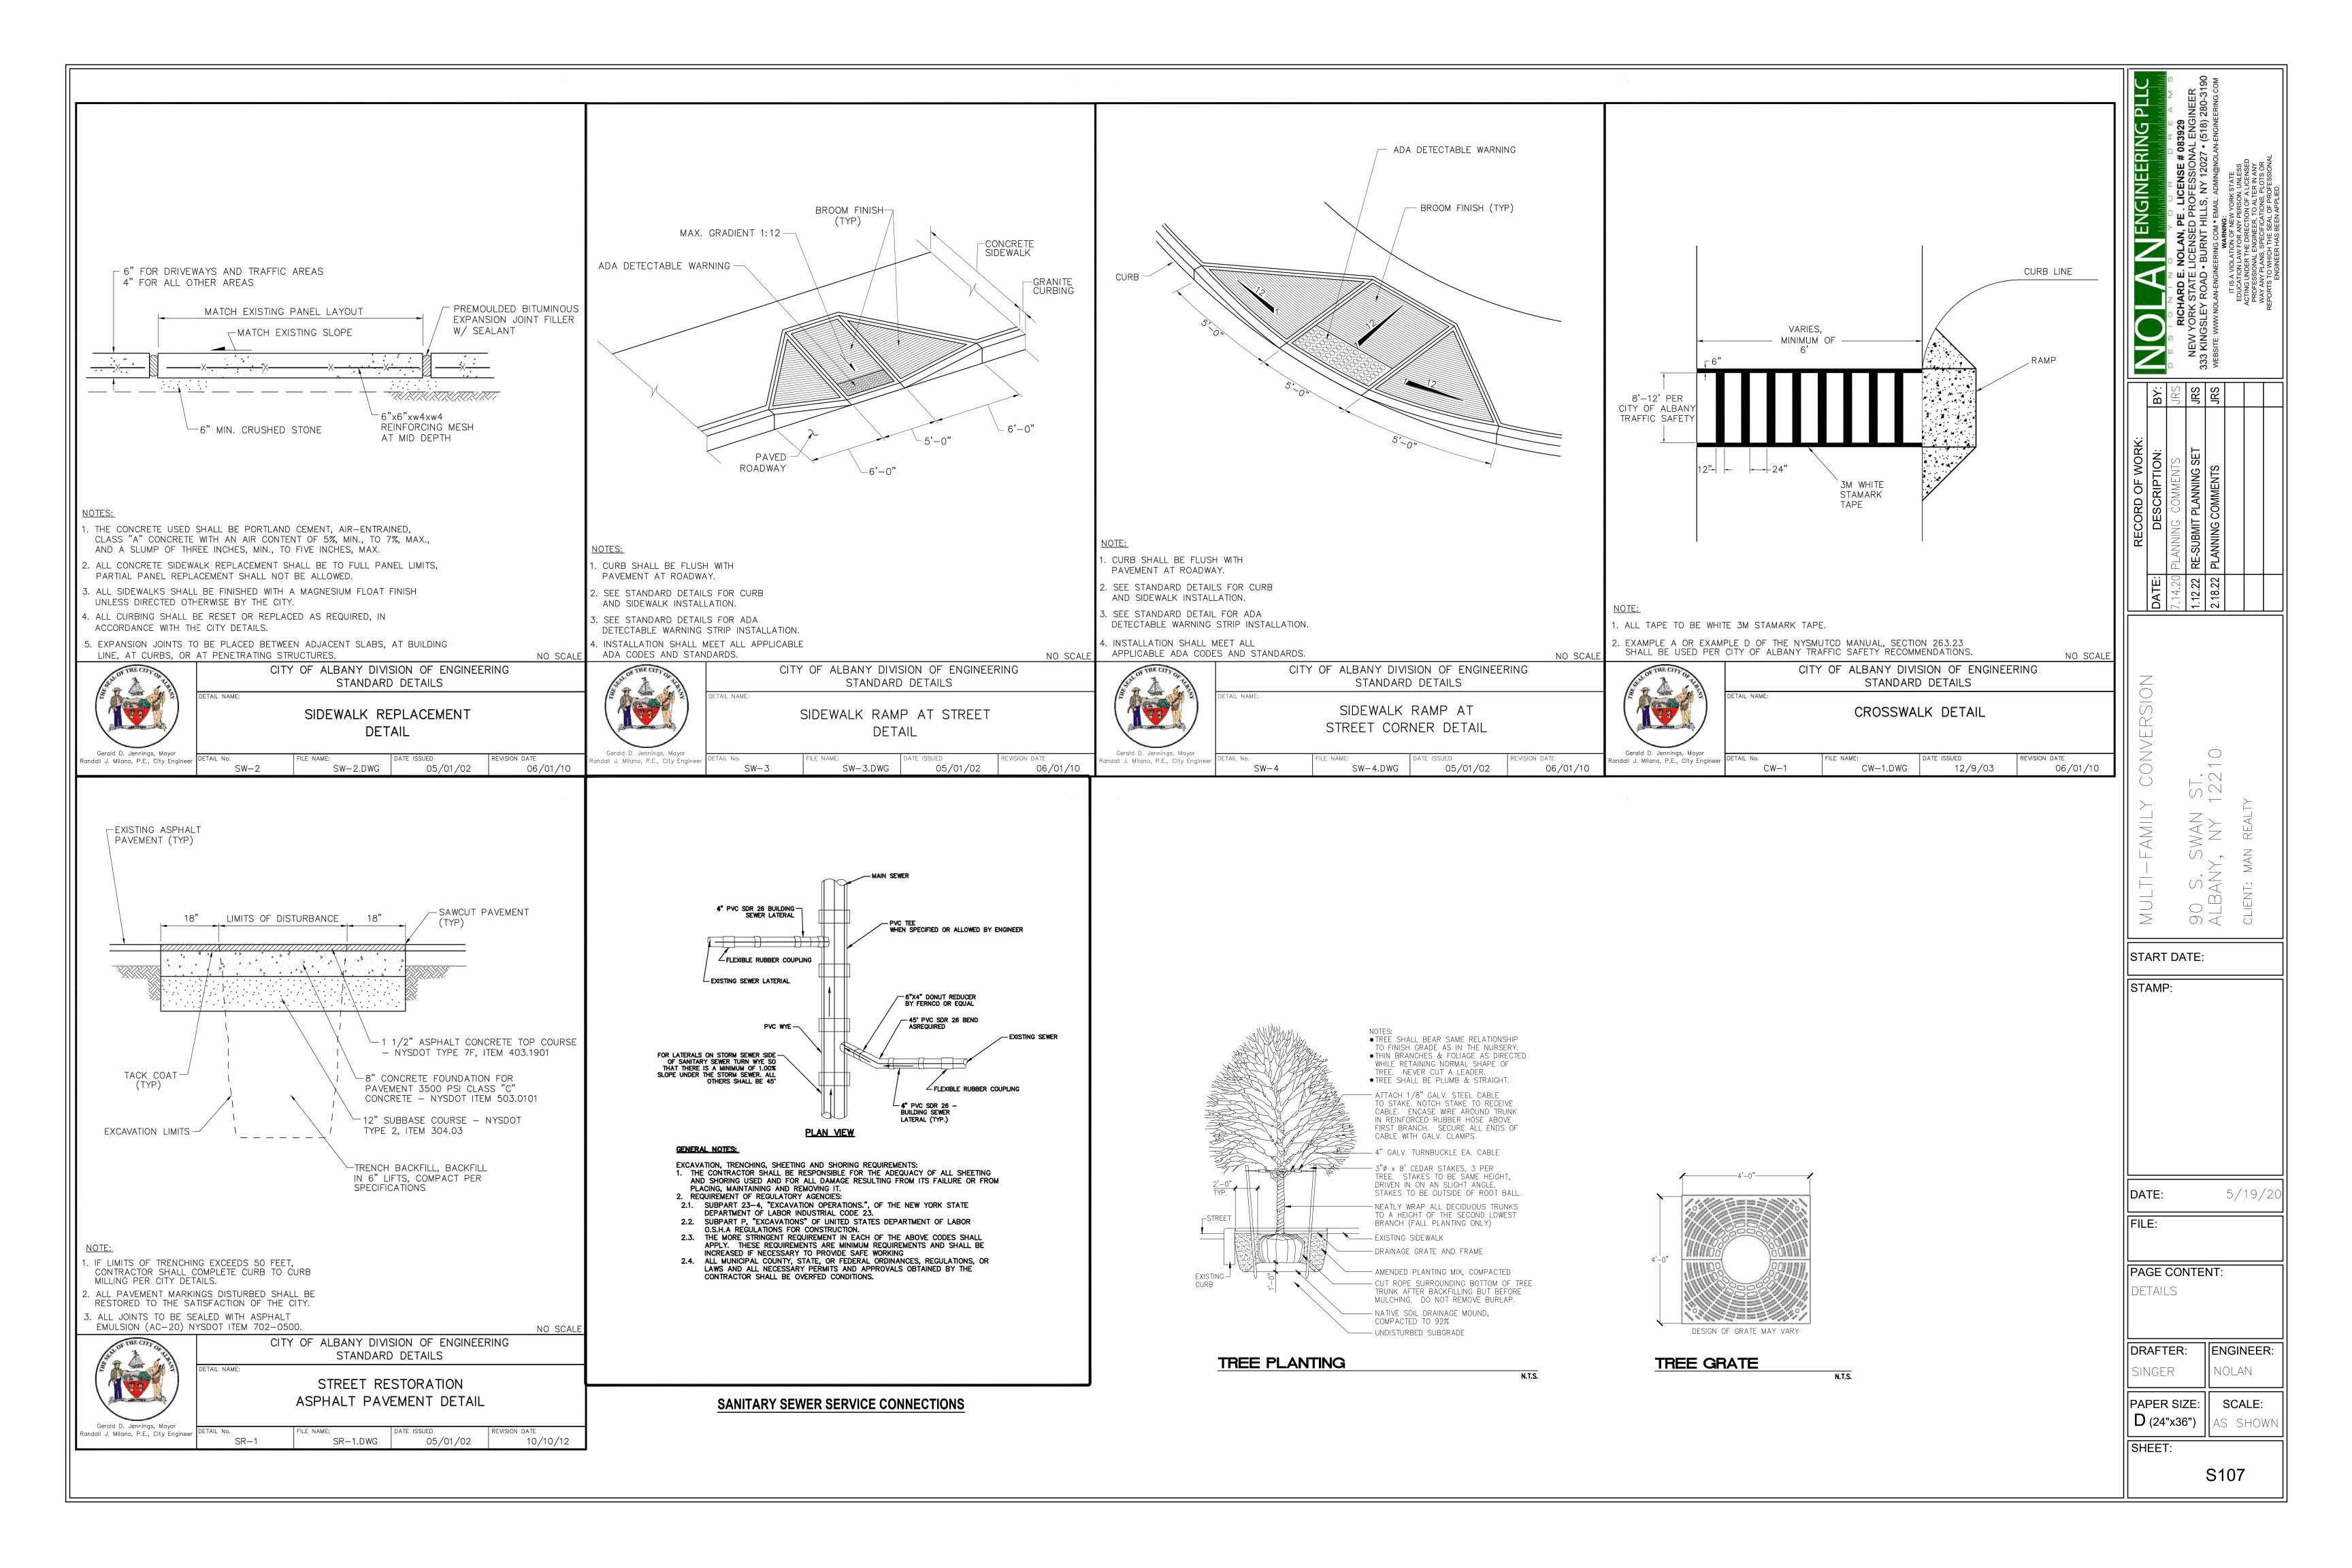

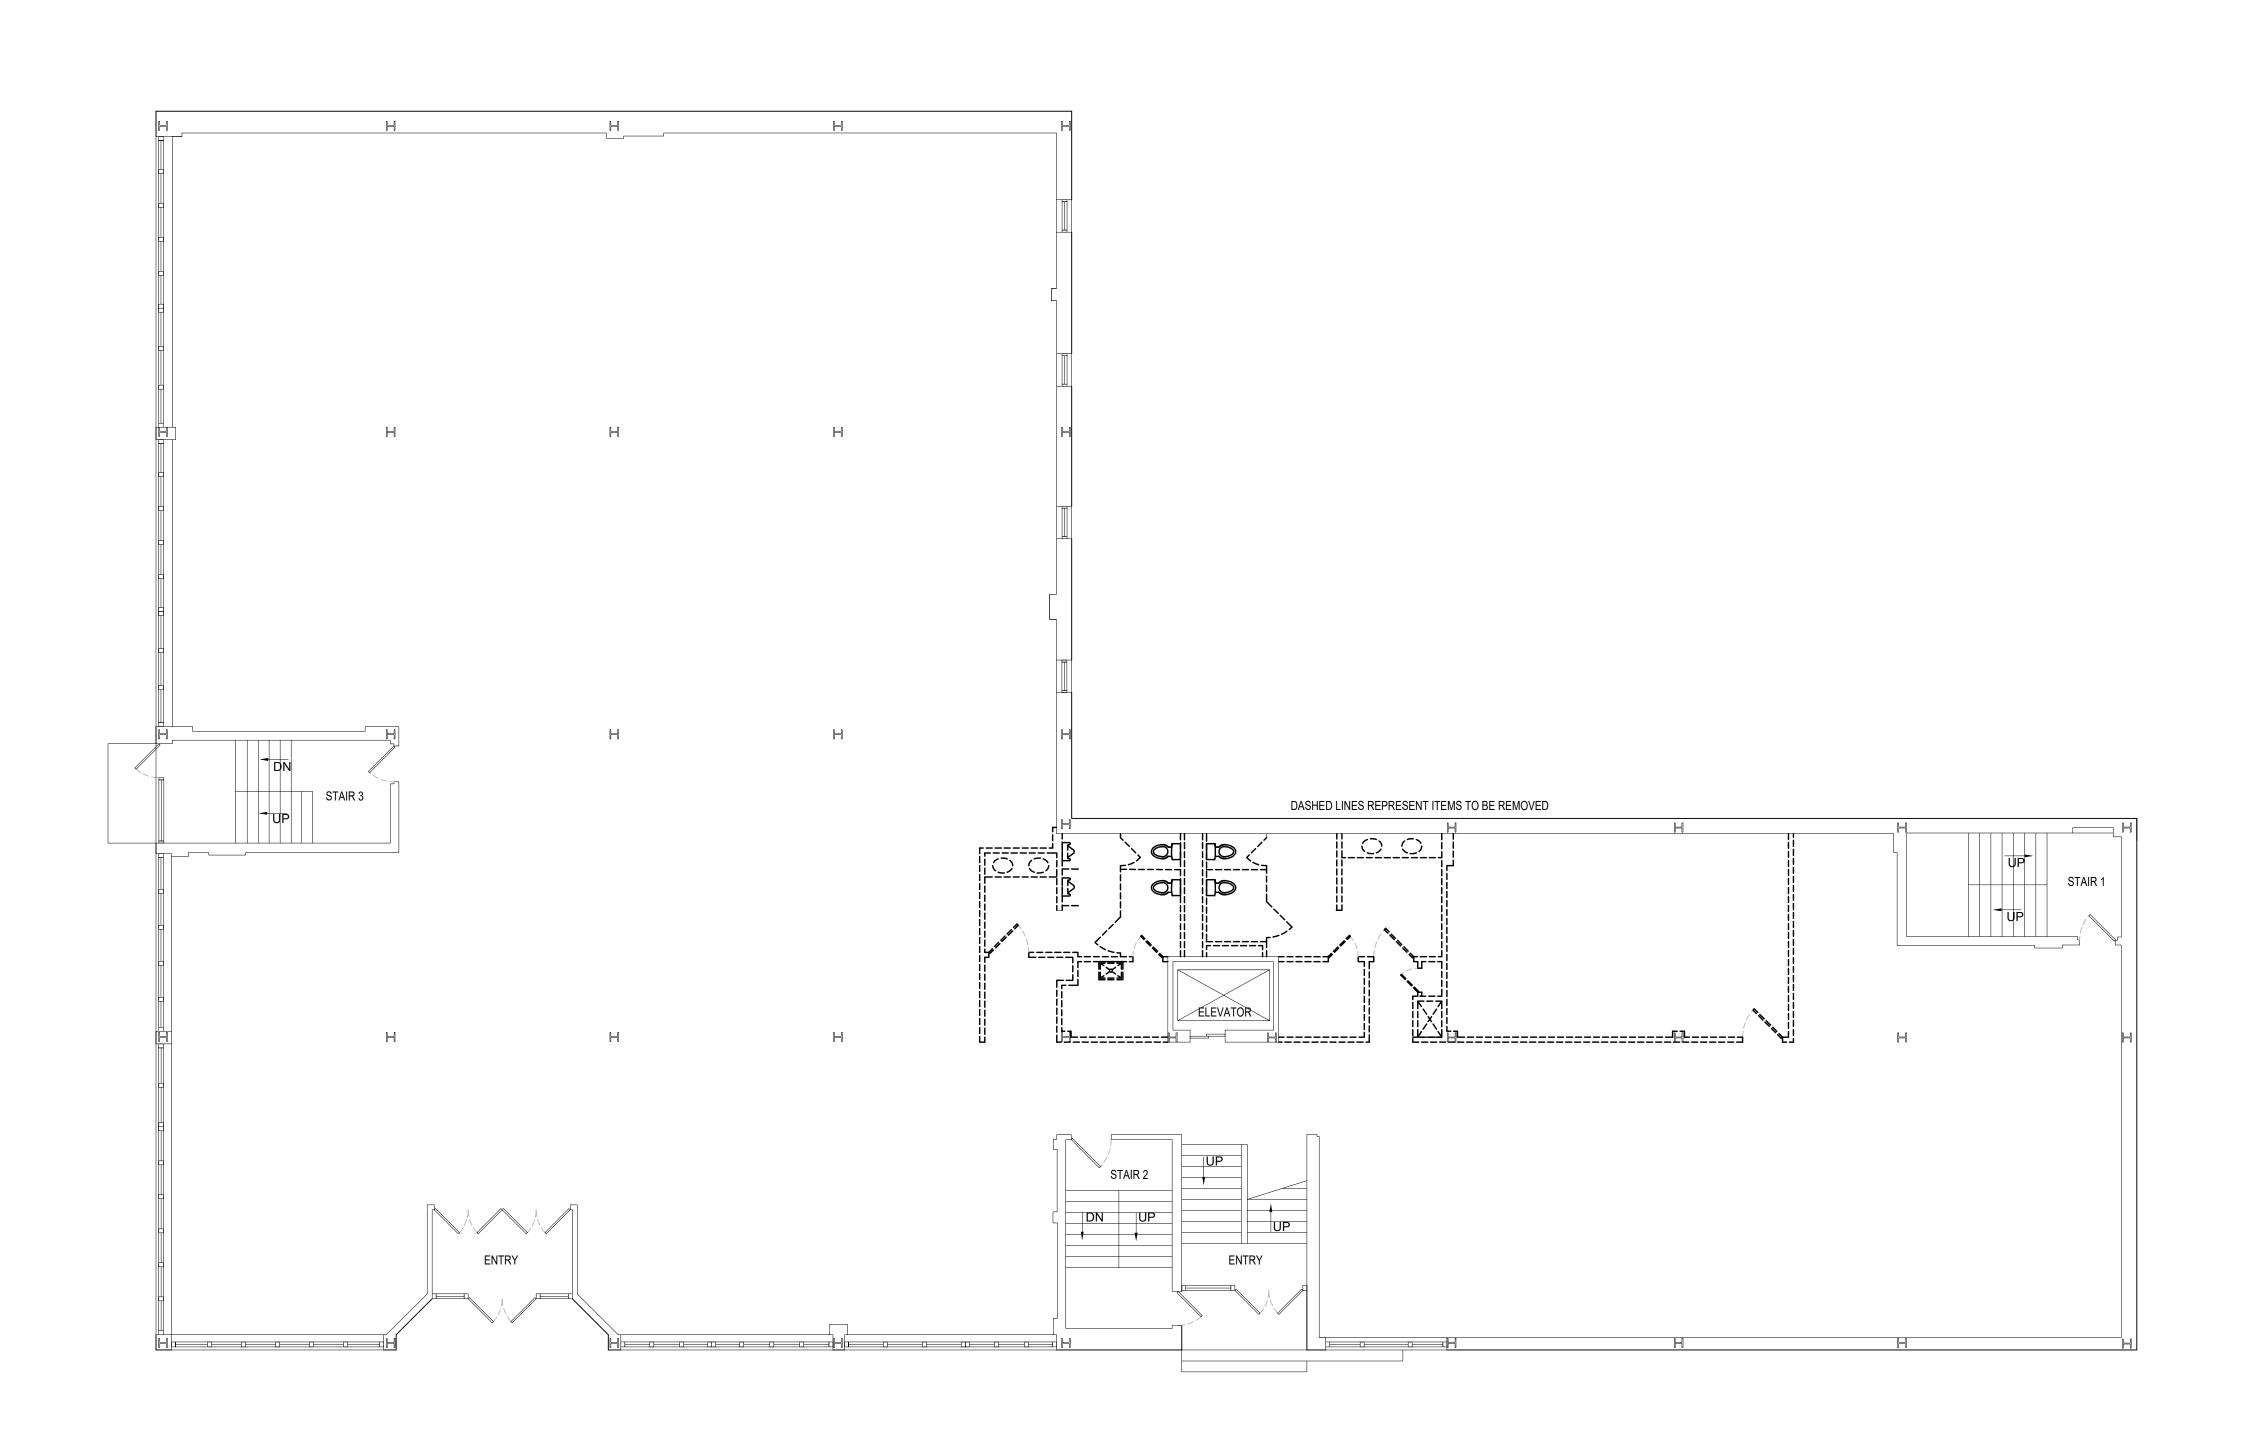


START DATE: STAMP: 5/19/20 DATE: FILE: PAGE CONTENT: EXISTING FIRST FLOOR PLAN DRAFTER: ENGINEER: PAPER SIZE: SCALE: **D** (24"x36") AS SHOWN

SHEET:

A101

N EXISTING FIRST FLOOR PLAN SCALE: $\frac{1}{8}$ " = 1'-0"

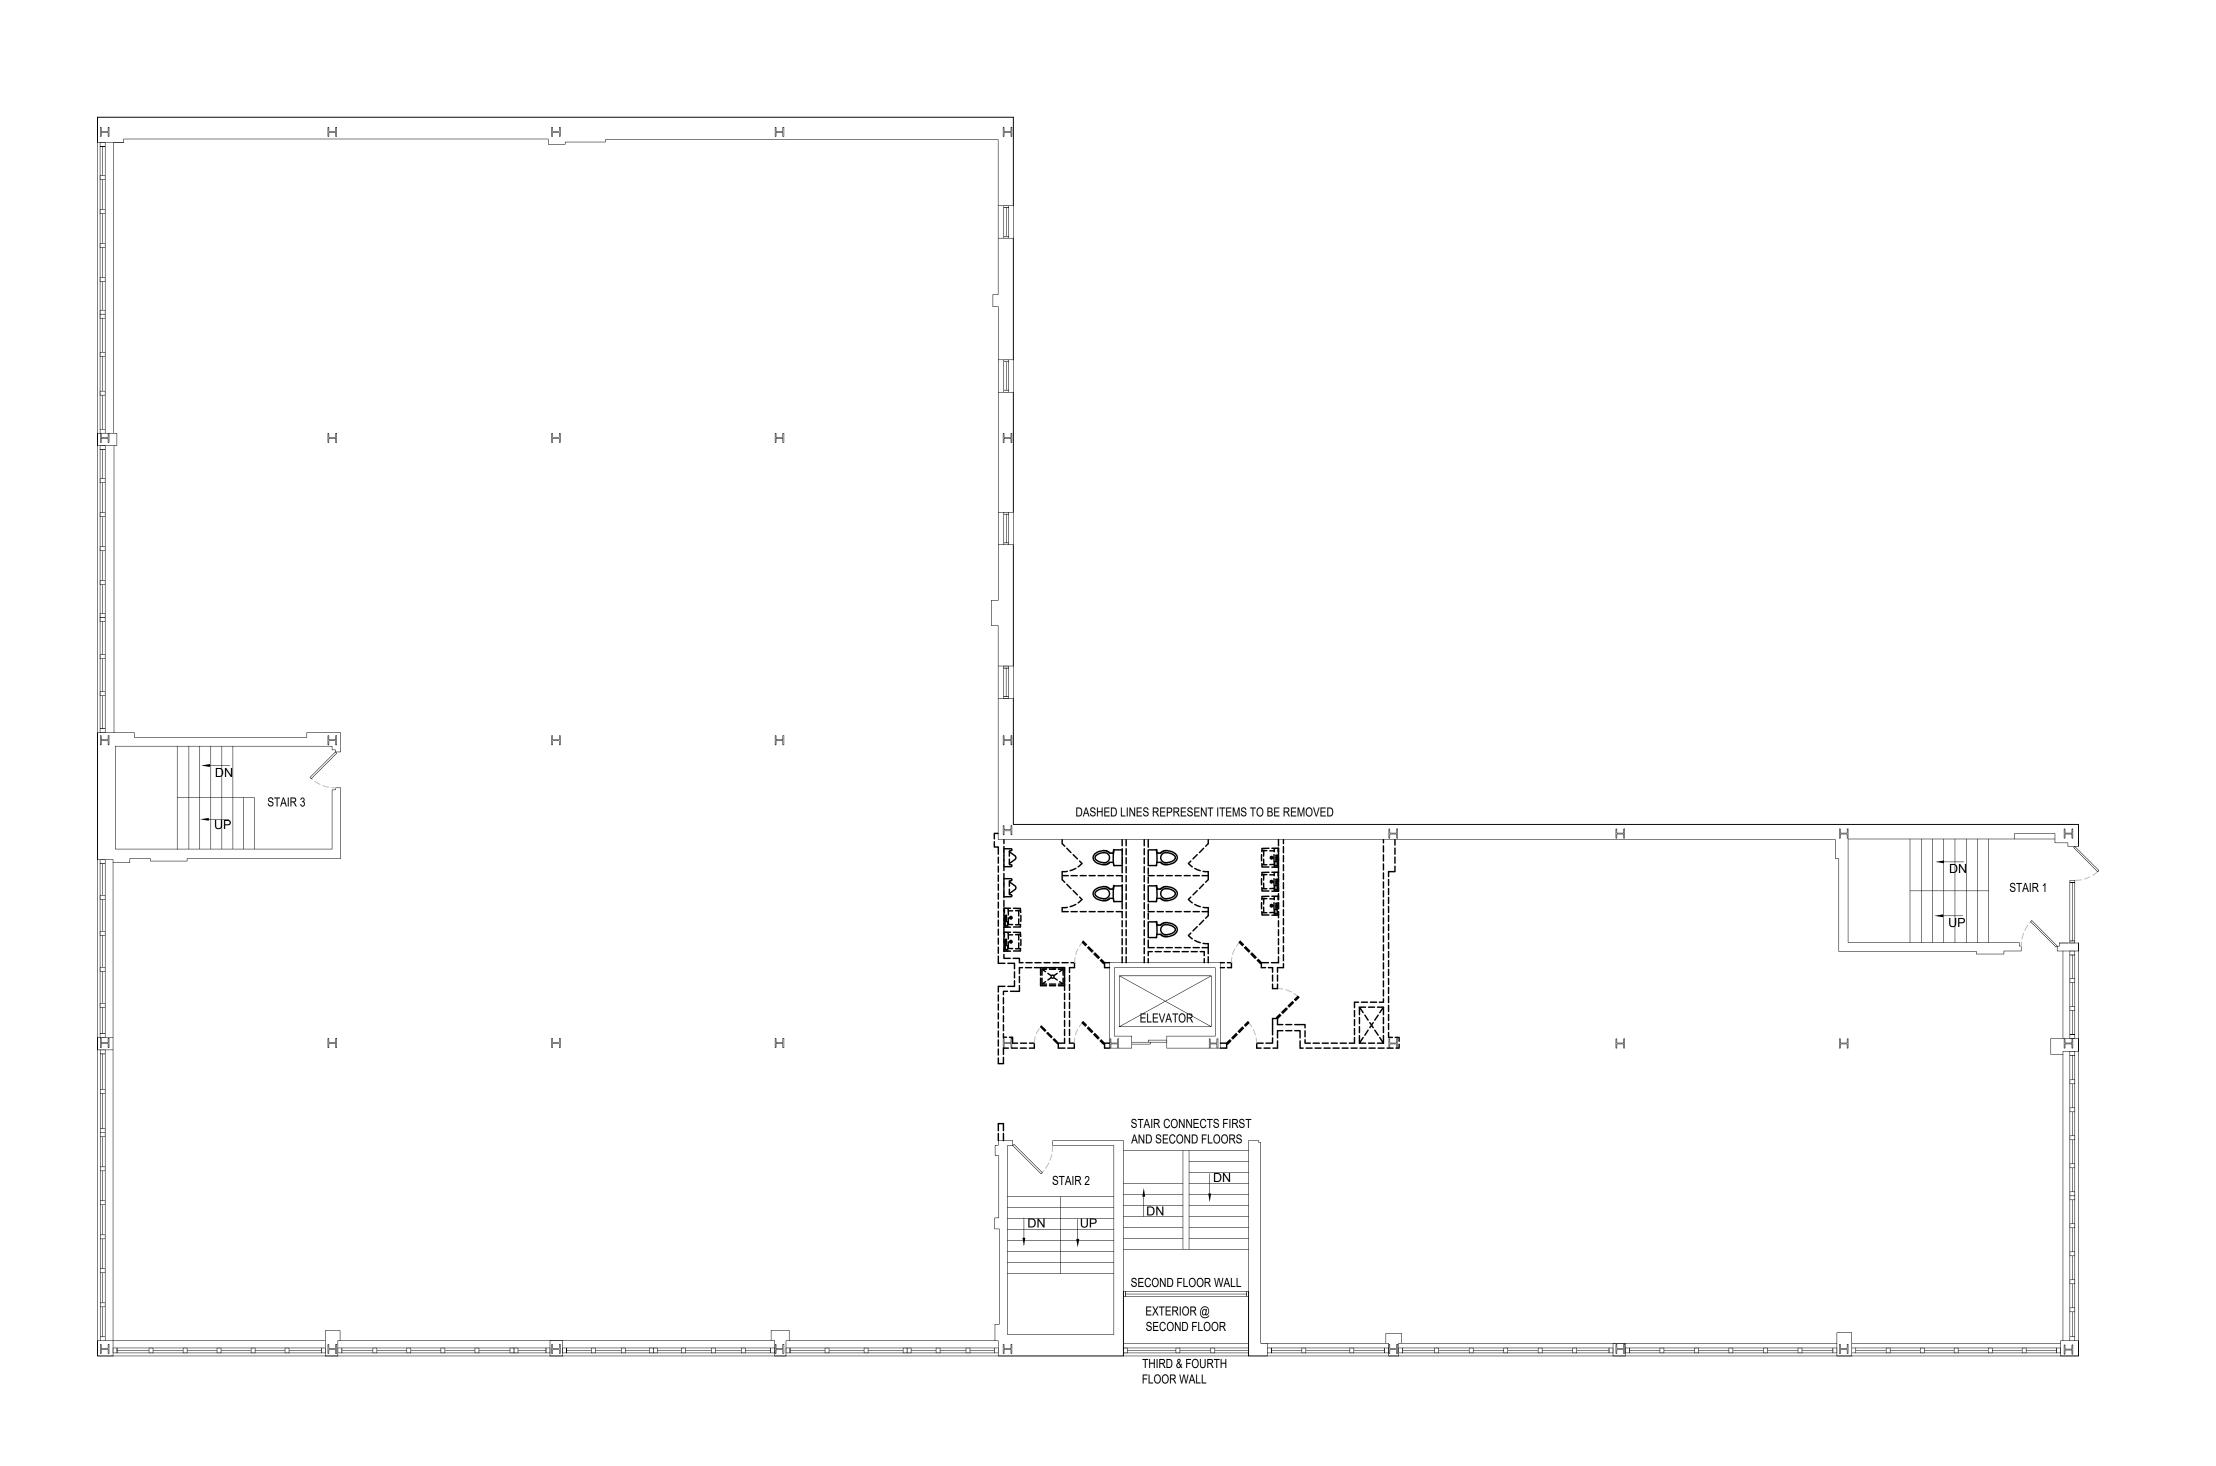


START DATE: STAMP: 5/19/20 DATE: FILE: PAGE CONTENT: EXISTING 2ND-4TH FLOOR PLAN DRAFTER: ENGINEER: ||PAPER SIZE: || SCALE: **D** (24"x36") AS SHOWN

SHEET:

A102

 $\frac{\text{EXISTING SECOND - FOURTH FLOOR PLAN}}{\text{SCALE: } \frac{1}{8}" = 1'-0"}$

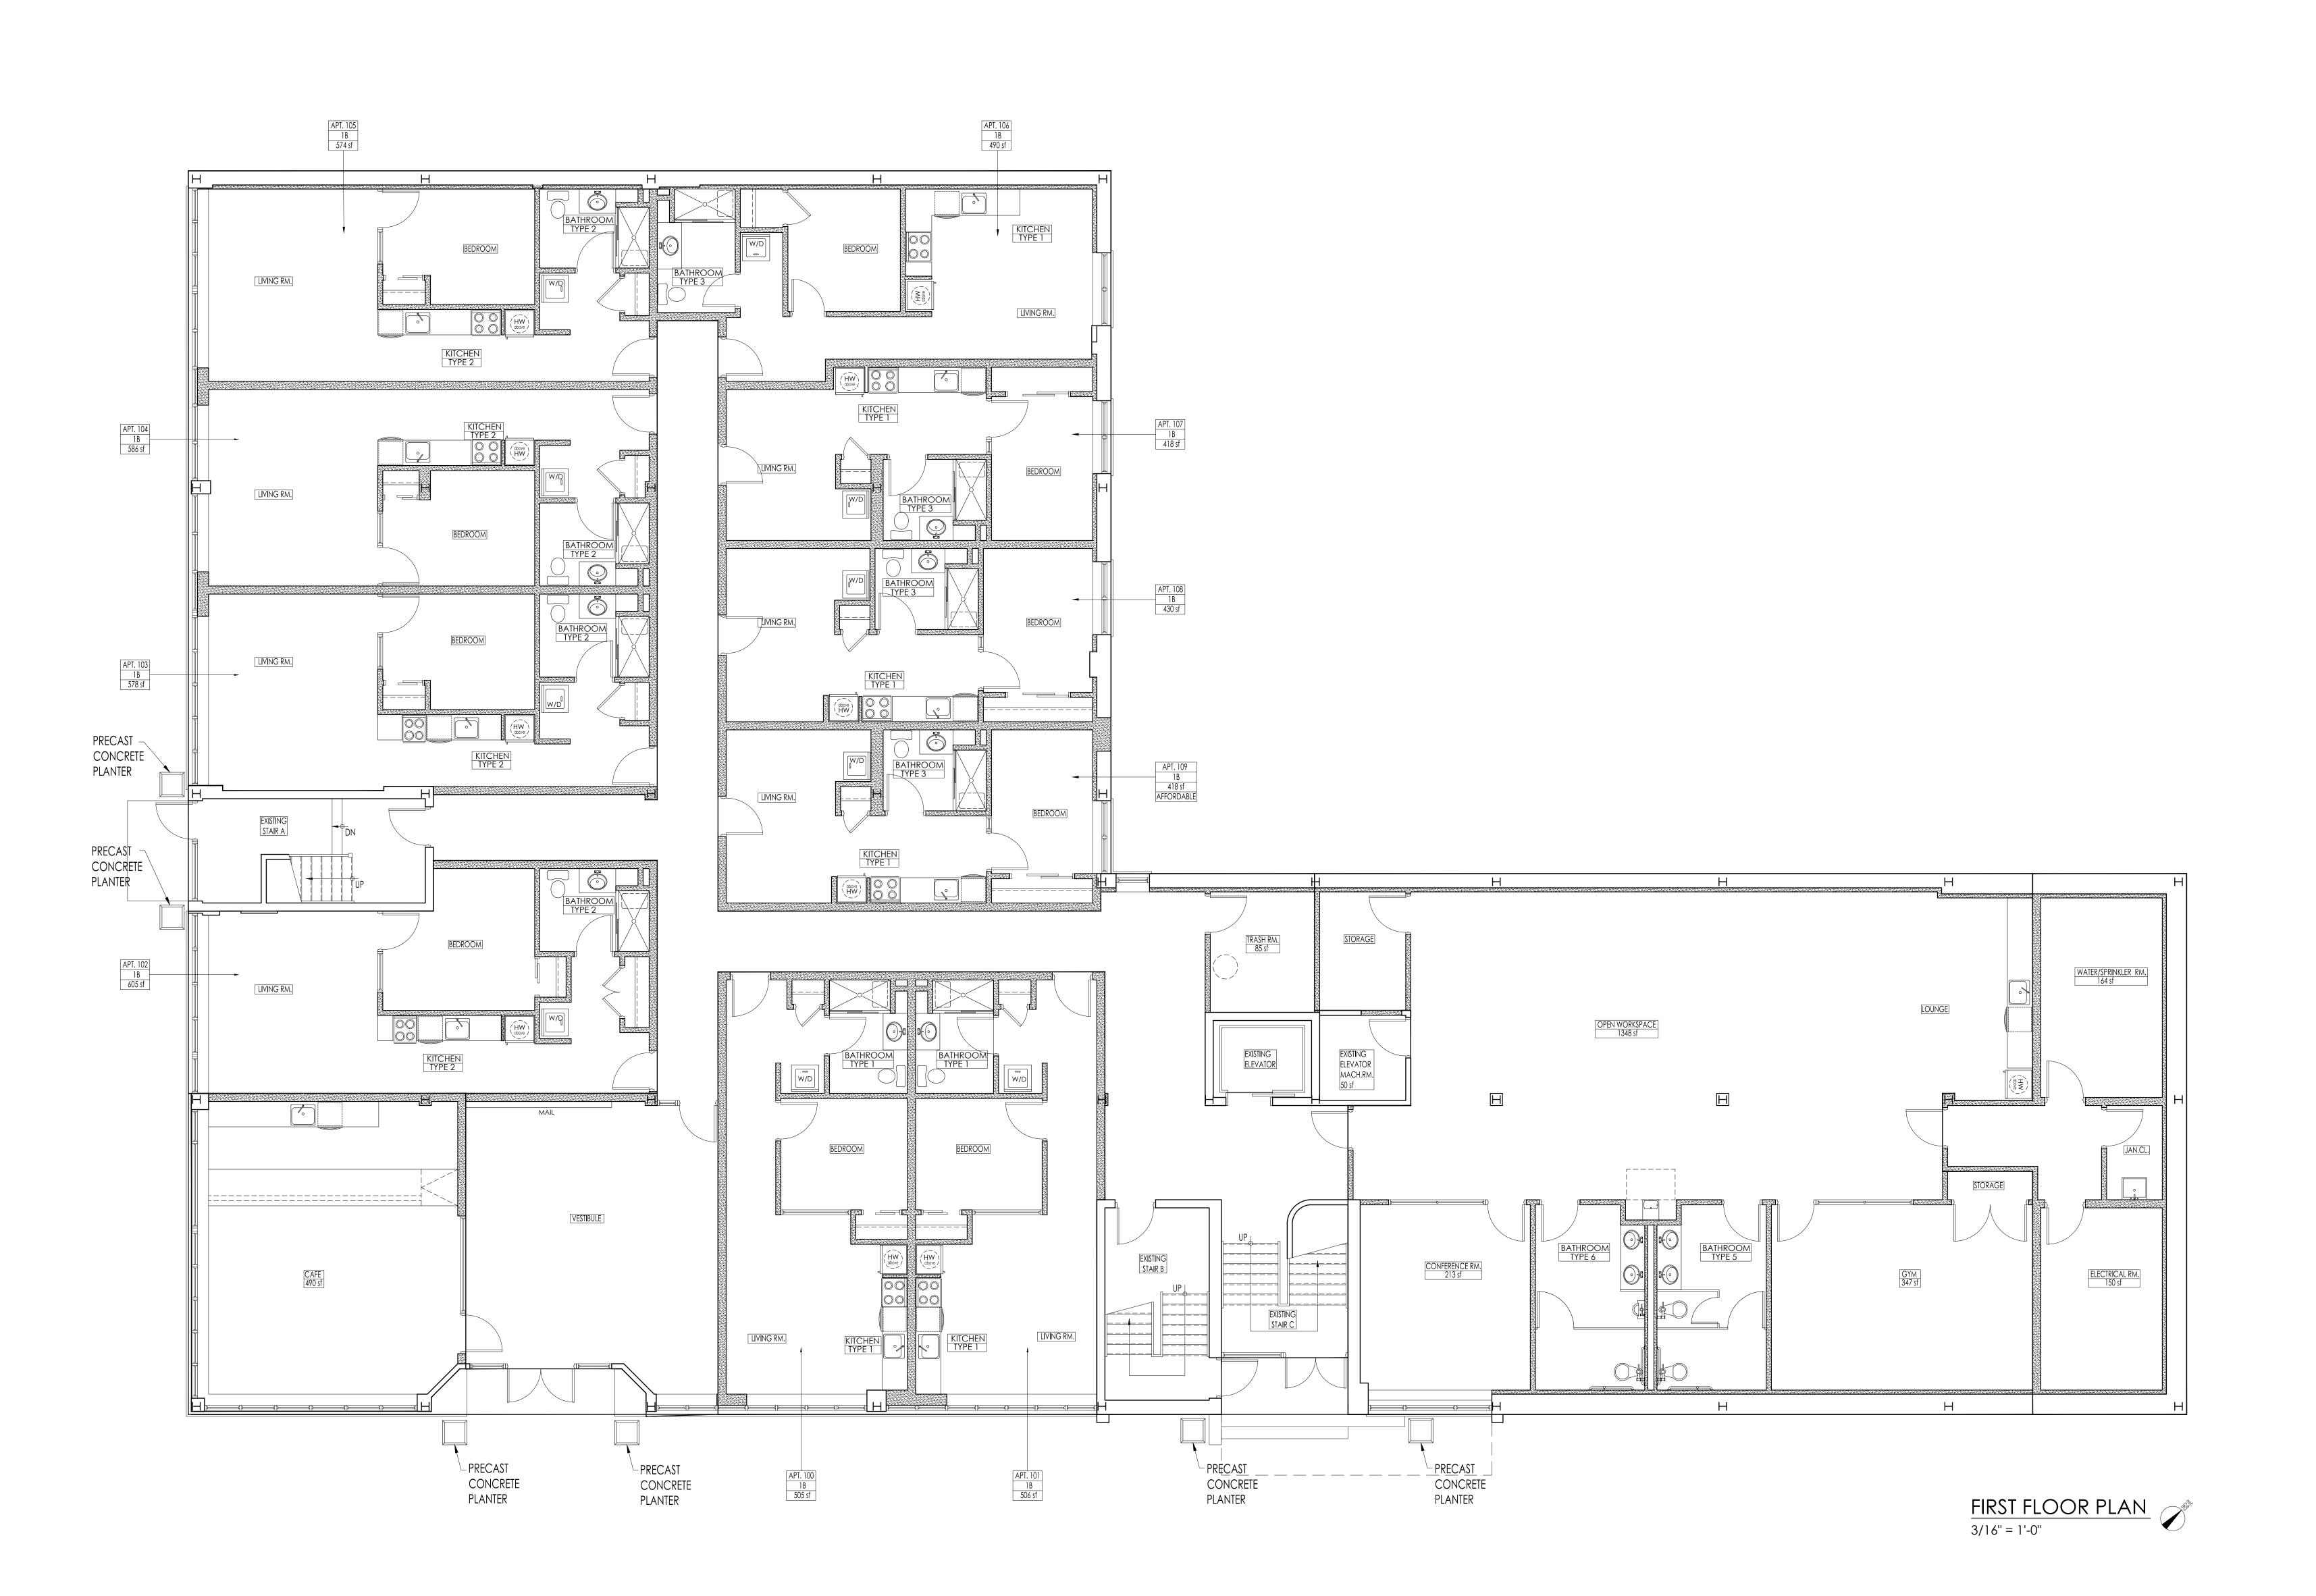

Adaptive Re-Use

90 S. Swan Street Albany, N.Y.

Block: 7 Lot: 44

ARCHITECT:

JOHN SARACCO ARCHITECT L.L.C.
PO BOX 245
BOONTON, N.J. 07005
t: 973.299.4428
e: office@saracco.us

2.10.22 Planning Board
No: Date: Revision:

First Floor Plan

SCALE: AS NOTED

DATE: AS NOTED

PROJECT NO.: 432cd

DRAWN BY: DW

CHECKED BY: JS

DRAWING NO.: 8 OF 25

JOHN SARACCO NY Lic # 018356



Adaptive Re-Use

90 S. Swan Street Albany, N.Y.


Block: 7 Lot: 44

ARCHITECT: JOHN SARACCO ARCHITECT L.L.C.
PO BOX 245
BOONTON, N.J. 07005
t: 973.299.4428
e: office@saracco.us

DOB SCAN CODE:

Second Floor Plan

SEAL & SIGNATURE: DRAWING NO.: 9 OF 25 JOHN SARACCO NY Lic # 018356

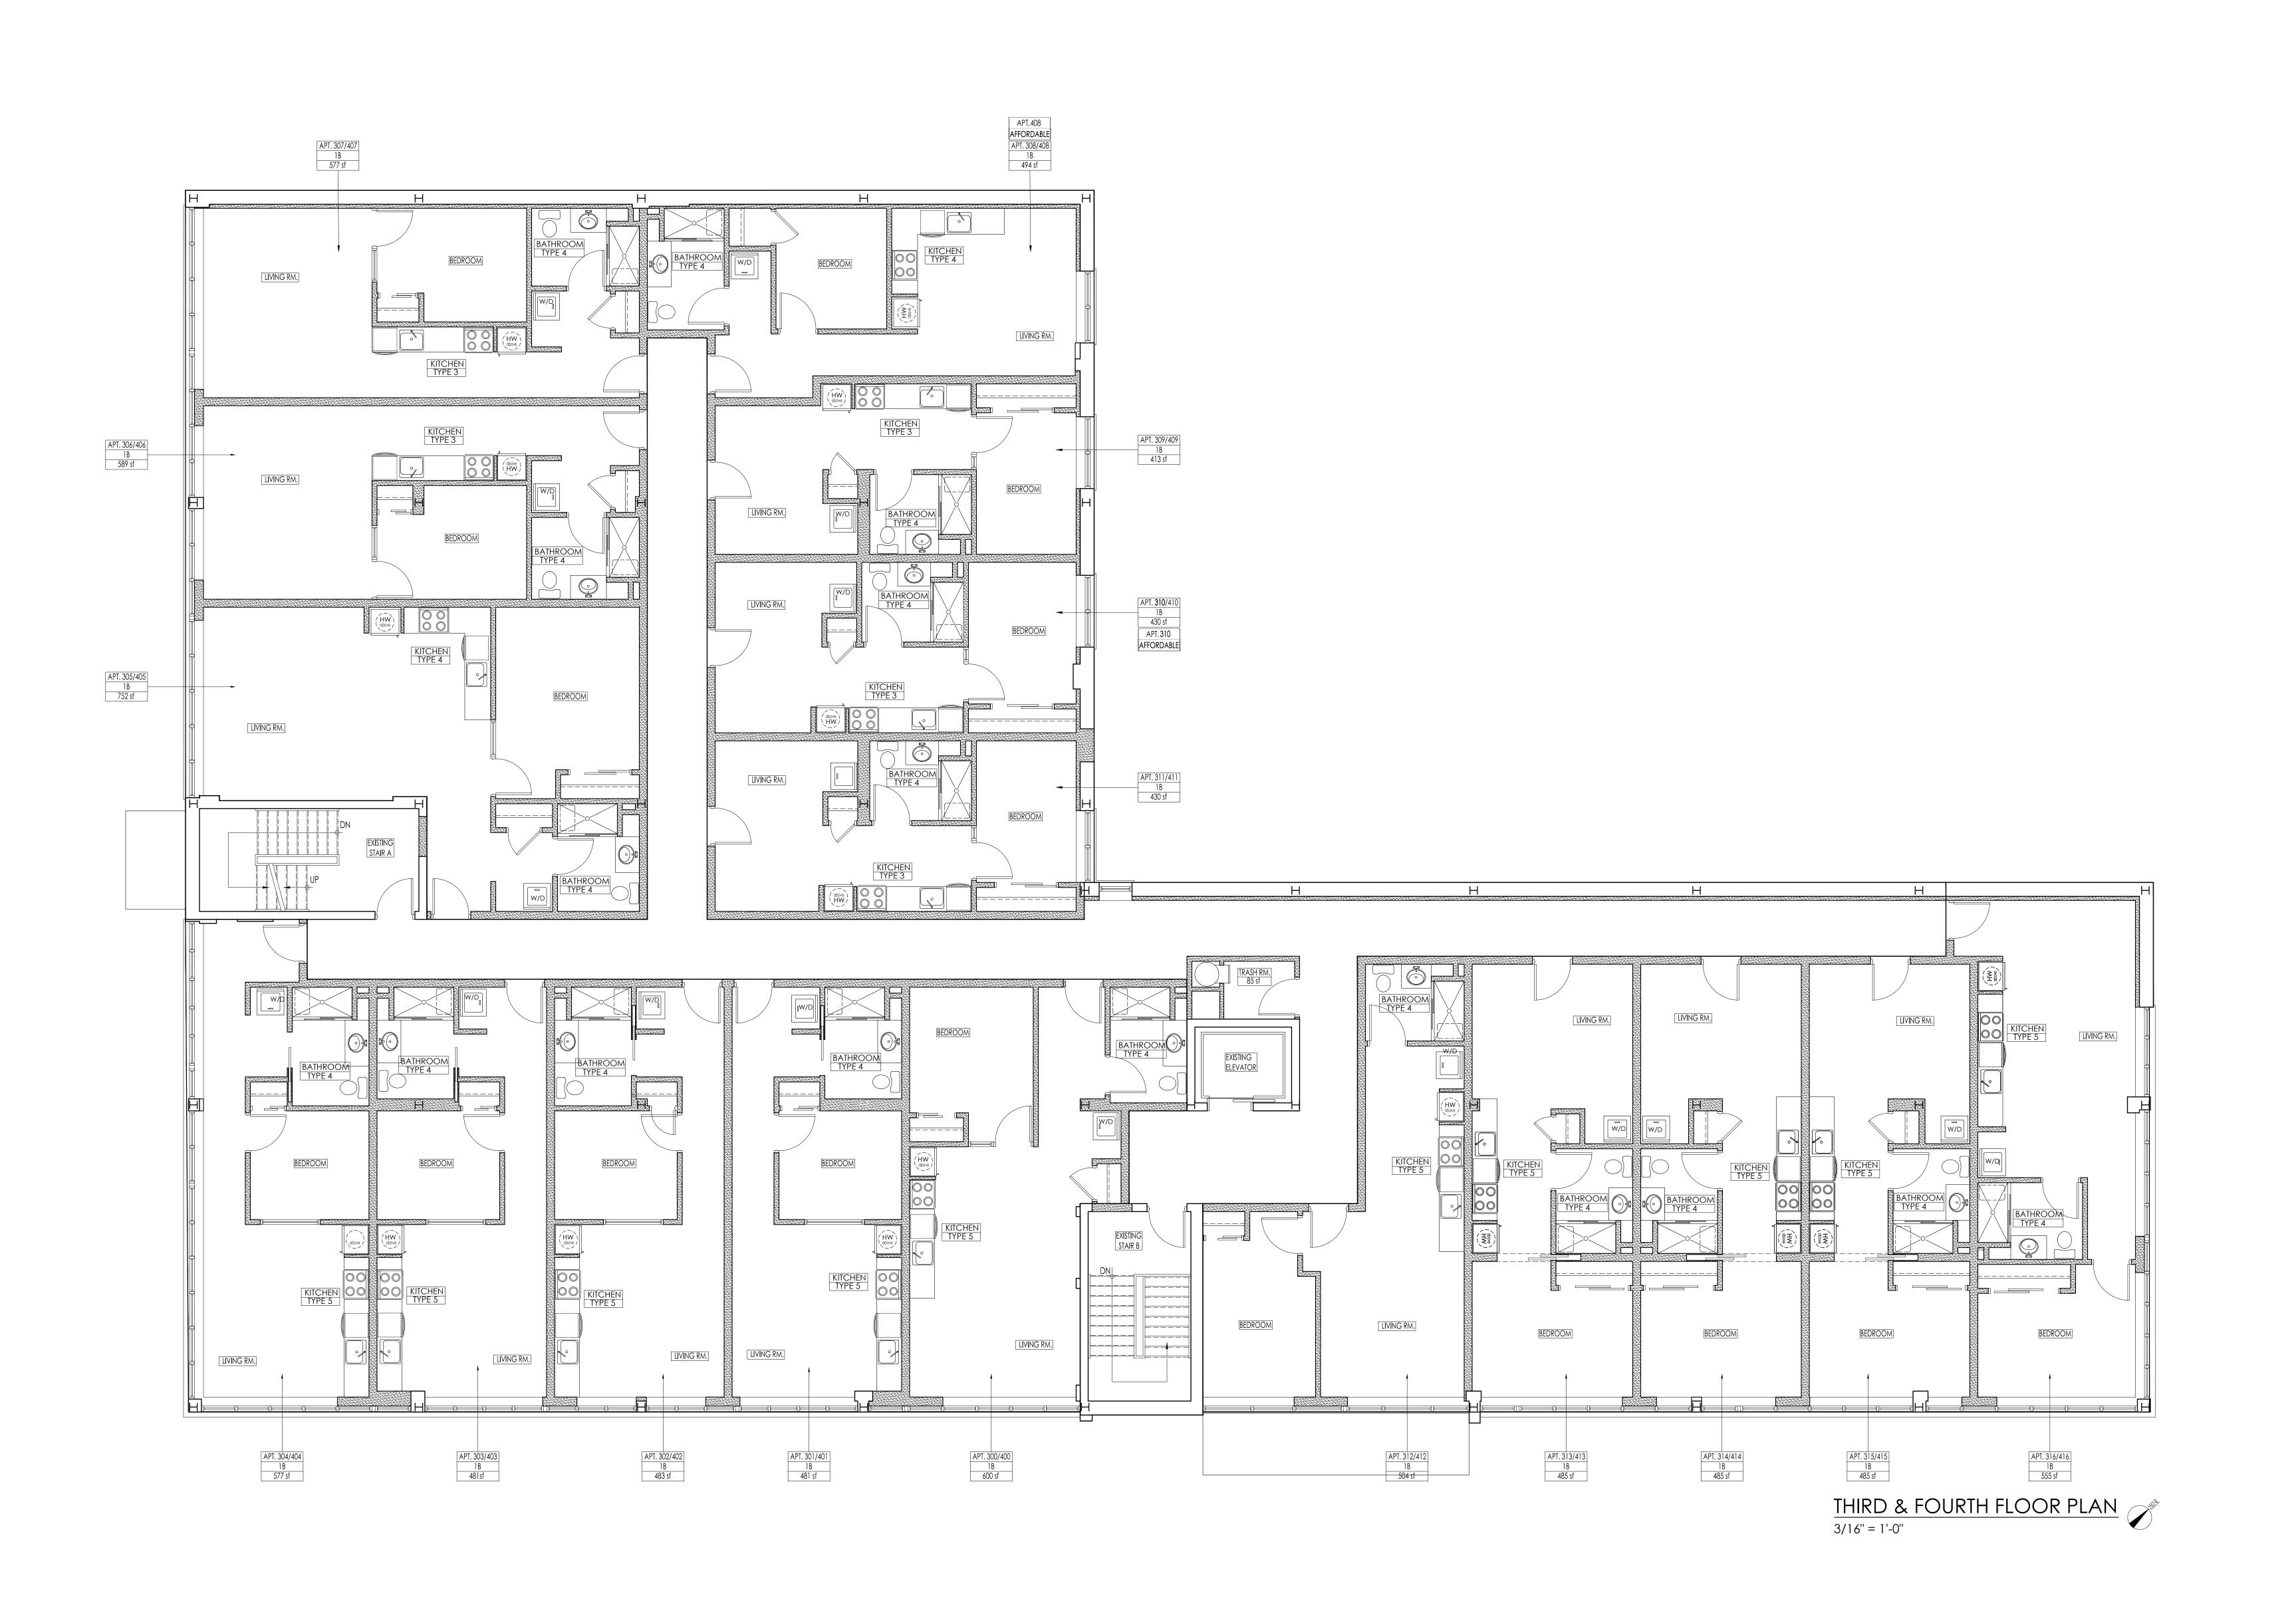

Adaptive Re-Use

90 S. Swan Street Albany, N.Y.


Block: 7 Lot: 44

ARCHITECT:

JOHN SARACCO ARCHITECT L.L.C.
PO BOX 245
BOONTON, N.J. 07005
t: 973.299.4428
e: office@saracco.us

2.10.22 Planning Board
No: Date: Revision:

Third & Fourth Floor Plan

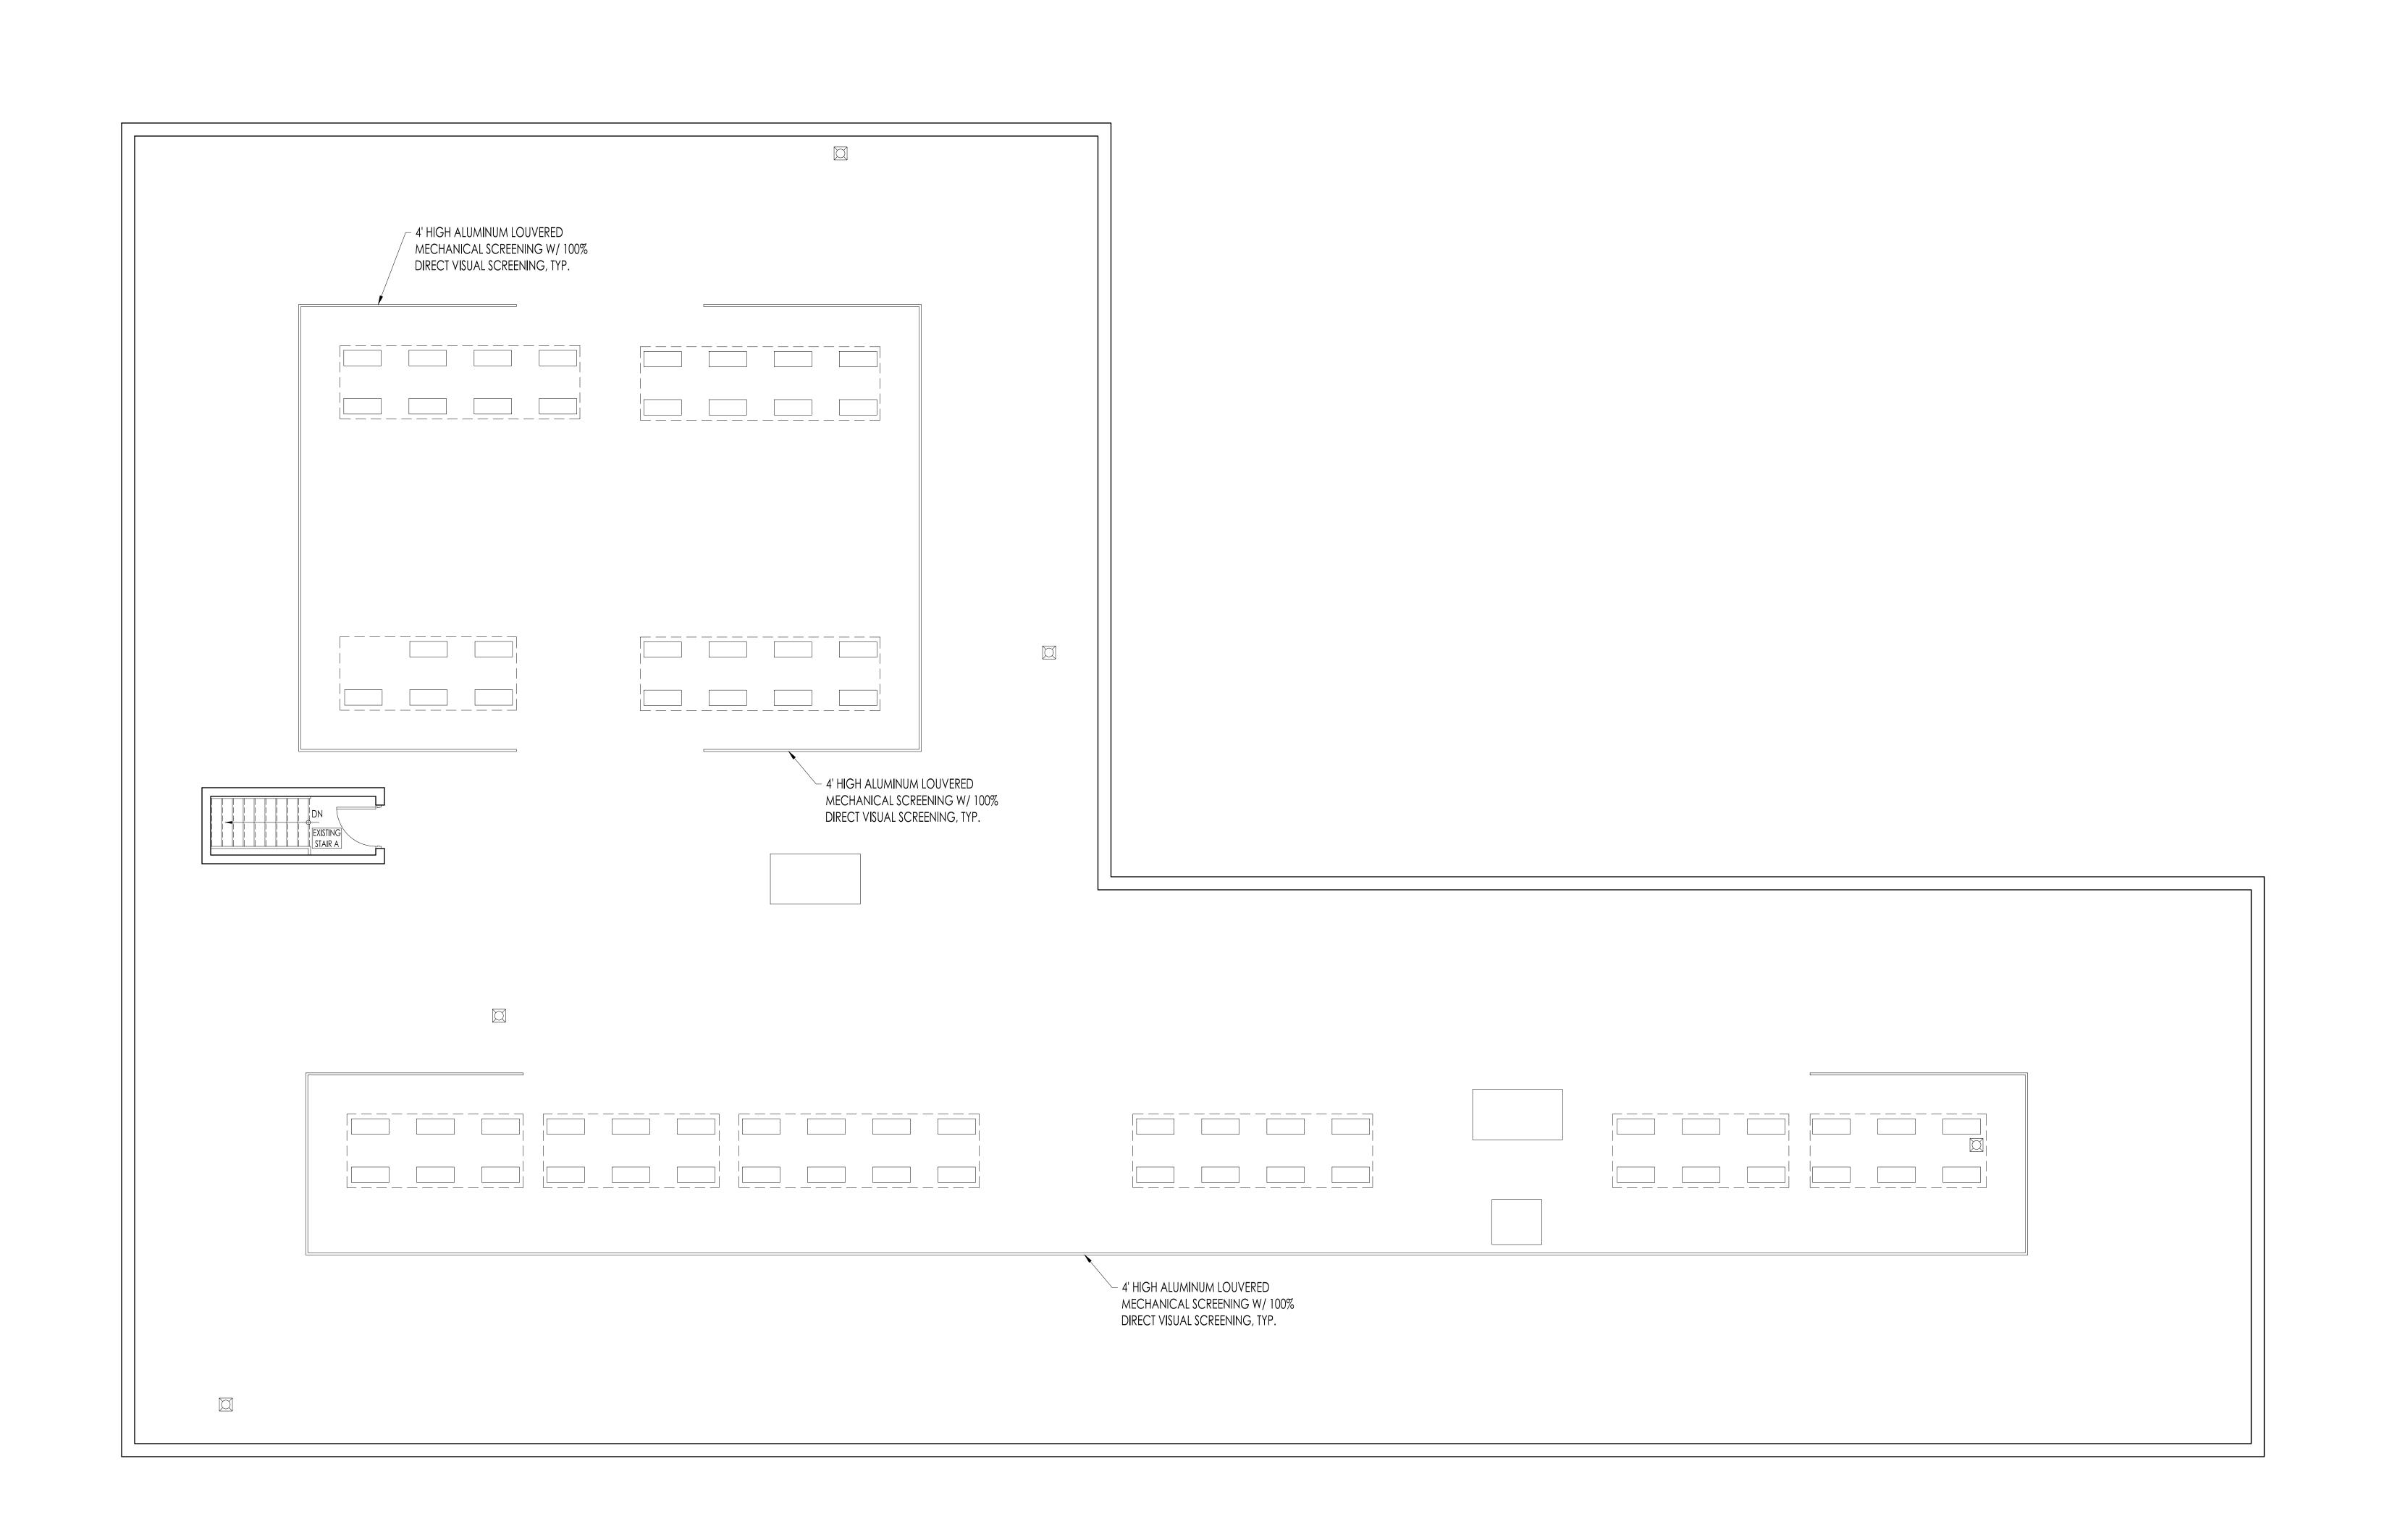

Adaptive Re-Use

90 S. Swan Street Albany, N.Y.

Block: 7 Lot: 44

ARCHITECT:

JOHN SARACCO ARCHITECT L.L.C.
PO BOX 245
BOONTON, N.J. 07005
t: 973.299.4428
e: office@saracco.us

2.10.22 Planning Board
No: Date: Revision:

DOB SCAN CODE:

Roof Plan

SCALE: AS NOTED

DATE: AS NOTED

PROJECT NO.: 432cd

DRAWN BY: DW

CHECKED BY: JS

DRAWING NO.: 11 OF 25

1. HATCH AT WINDOWS REPRESENTS OPAQUE FILM TO BE INSTALLED ON INTERIOR FACE OF GLASS WHERE UNIT

- SCREENING SHALL BE PROVIDED AROUND NEW ROOFTOP UNITS VISIBLE FROM PUBLIC RIGHT OF WAY OF SUFFICIENT HEIGHT AND IN ACCORDANCE WITH USDO SECTION 375-4(F)(9)(b) ADJACENT 3-STORY BRICK BUILDING

NOTE: NO CHANGES TO THE EXISTING ELEVATION

SOUTHWEST ELEVATION (CHESTNUT ST.) SCALE: $\frac{1}{8}$ " = 1'-0"

SCREENING SHALL BE PROVIDED AROUND NEW —

WAY OF SUFFICIENT HEIGHT AND IN ACCORDANCE

ROOFTOP UNITS VISIBLE FROM PUBLIC RIGHT OF

WITH USDO SECTION 375-4(F)(9)(b)

NOTE: NO CHANGES TO THE EXISTING ELEVATION

WITH USDO SECTION 375-4(F)(9)(b)

SCREENING SHALL BE PROVIDED AROUND NEW -

ROOFTOP UNITS VISIBLE FROM PUBLIC RIGHT OF

WAY OF SUFFICIENT HEIGHT AND IN ACCORDANCE

SCREENING SHALL BE PROVIDED AROUND NEW — ROOFTOP UNITS VISIBLE FROM PUBLIC RIGHT OF WAY OF SUFFICIENT HEIGHT AND IN ACCORDANCE WITH USDO SECTION 375-4(F)(9)(b)

NORTHEAST ELEVATION (STATE ST.) SCALE: $\frac{1}{8}$ " = 1'-0"

NOTE: NO CHANGES TO THE EXISTING ELEVATION

DEMISING WALL OCCURS.

90 S. SWAN ALBANY, NY CLIENT: MAN REAL

START DATE:

STAMP:

|FILE:

5/19/20 DATE:

PAGE CONTENT:

EXTERIOR ELEVATIONS

DRAFTER: ENGINEER: NOLAN

PAPER SIZE: SCALE: D (24"x36") AS SHOWN

A301

SHEET:

SOUTHEAST ELEVATION (S. SWAN ST.) SCALE: $\frac{1}{8}$ " = 1'-0"

NORTHWEST ELEVATION (CHESTNUT ST.)

SCALE: $\frac{1}{8}$ " = 1'-0"

NOTE: NO CHANGES TO THE EXISTING ELEVATION