
Maria College Campus Development Plan Application

700 NEW SCOTLAND AVENUE ALBANY, NEW YORK

> April 26, 2019 Planning Board # XX.XXX

SHEET INDEX:

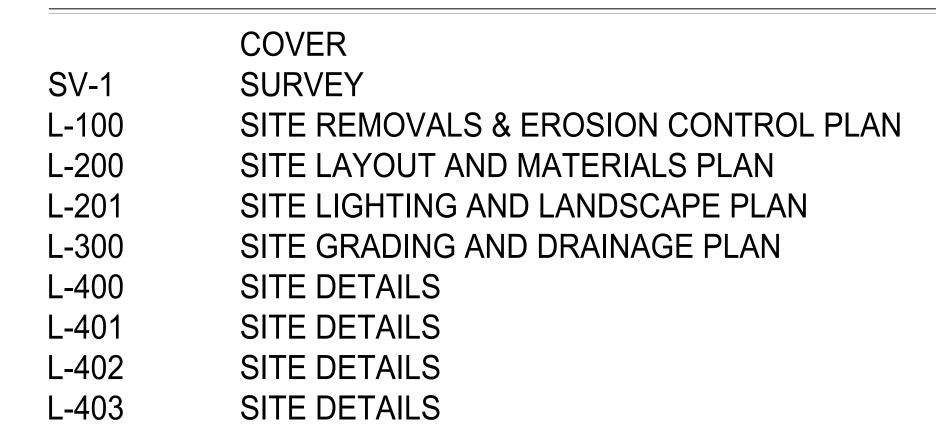

SITE STATISTICS

PROJECT AREA: ± 2.05 AC. ± 4.52 AC. PARCEL SIZE: TAX MAP PARCEL NUMBER: 64.80-1-1

MIXED-USE CAMPUS / INSTITUTIONAL (MU-CI) **EXISTING ZONING:**

INSTITUTIONAL

DIMENSIONS AND BULK REGULATIONS

LOT STANDARDS:

PROPOSED USE:

REQUIRED PROPOSED 80 FT MIN. 222 FT. (EXISTING / NO CHANGE) LOT WIDTH:

IMPERVIOUS LOT COVERAGE:

63% PHASE 1: 60% MAXIMUM TOTAL DISTRICT: ±53% 60% MAXIMUM

YARD SETBACK (FT.)

The LA GROUP

20 FT. MAXIMUM 34 FT. (EXISTING / NO CHANGE) 0 FT. MINIMUM 0 FT. (EXISTING / NO CHANGE) REAR: 15 FT. MINIMUM* 15' FT.

*= ADJACENT TO RESIDENTIAL DISTRICT

VEHICULAR PARKING INFORMATION

EXISTING PARKING: 130 PARKING SPACES (INCLUDING 6 HC SPACES) *

PROPOSED PARKING: 104 NEW PARKING SPACES* 234 PARKING SPACES TOTAL:

* = 100 EXISTING PARKING PARKING SPACES ARE TO BE REMOVED IN FULL BUILD OUT OF DISTRICT PLAN

BICYCLE PARKING INFORMATION


REQUIRED BICYCLE PARKING: 21 BICYCLE PARKING SPACES (7 OF WHICH ARE ENCLOSED) (104 VEHICULAR PARKING SPACES X 20%) 16 BICYCLE PARKING SPACES (0 OF WHICH ARE ENCLOSED) * PROPOSED BICYCLE PARKING:

* = ADDITIONAL BICYCLE PARKING (INCLUDING ENCLOSED SPACES) TO BE PROVIDED IN FULL BUILD OUT OF DISTRICT PLAN

PREPARED BY: SITE / CIVIL MEP ENGINEER **ARCHITECT**






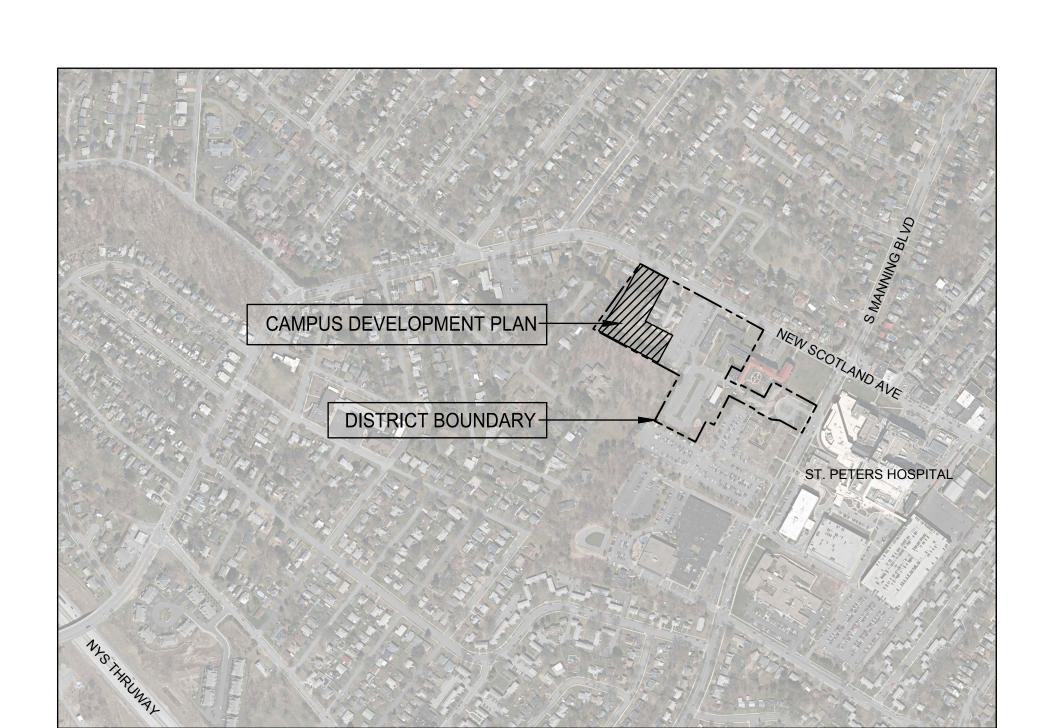






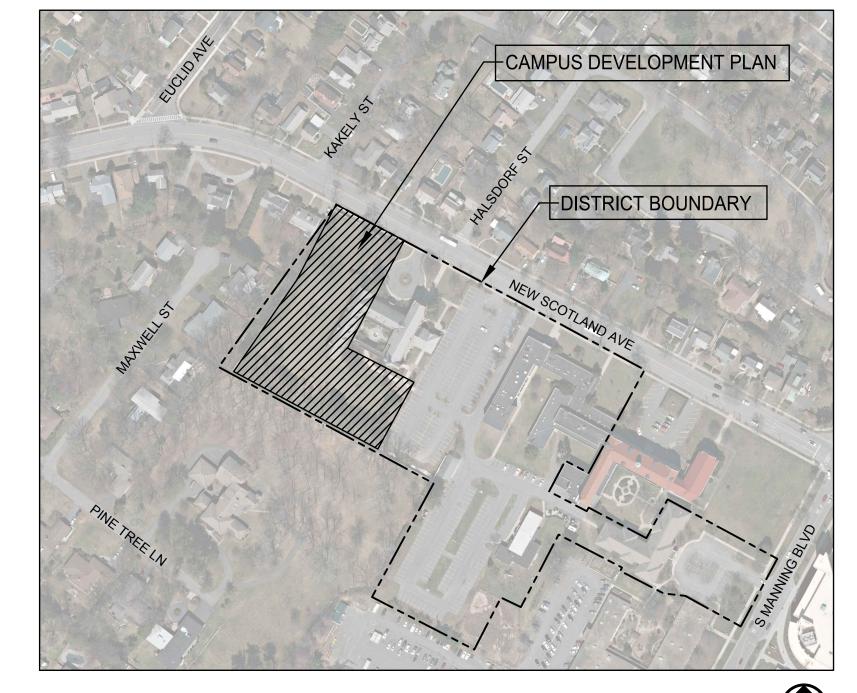

PROJECT VICINITY MAP:




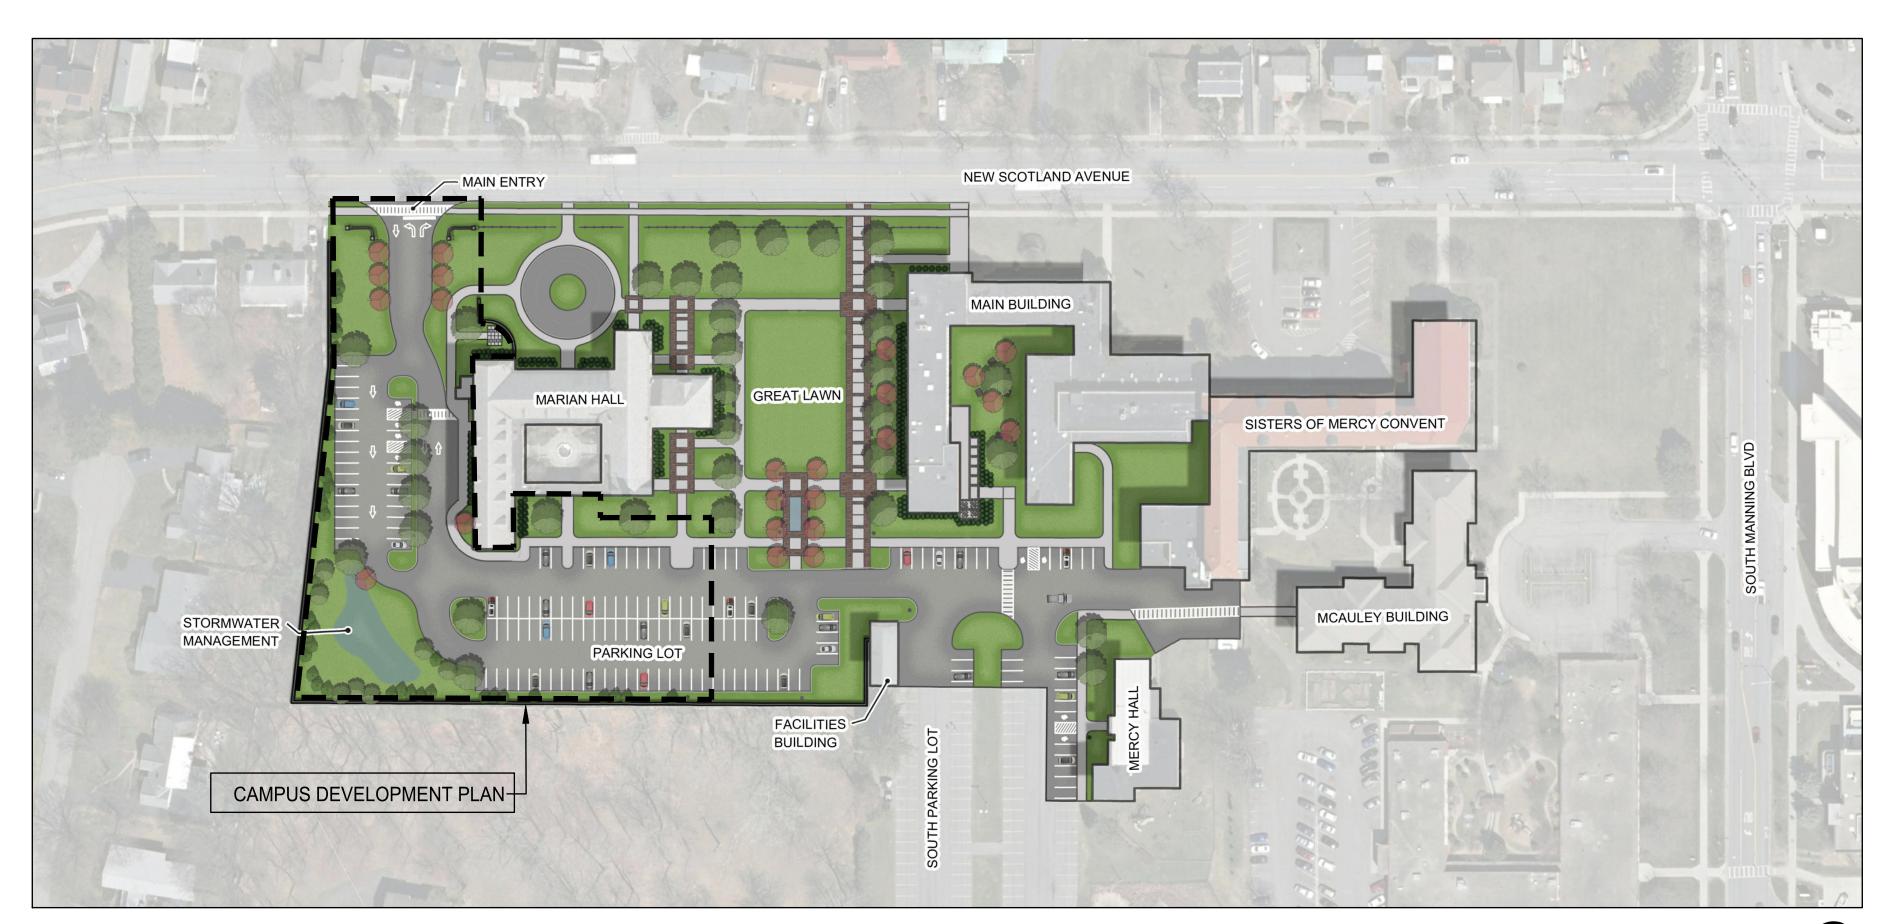


DISTRICT PLAN (MASTER PLAN)



SCALE: N.T.S.

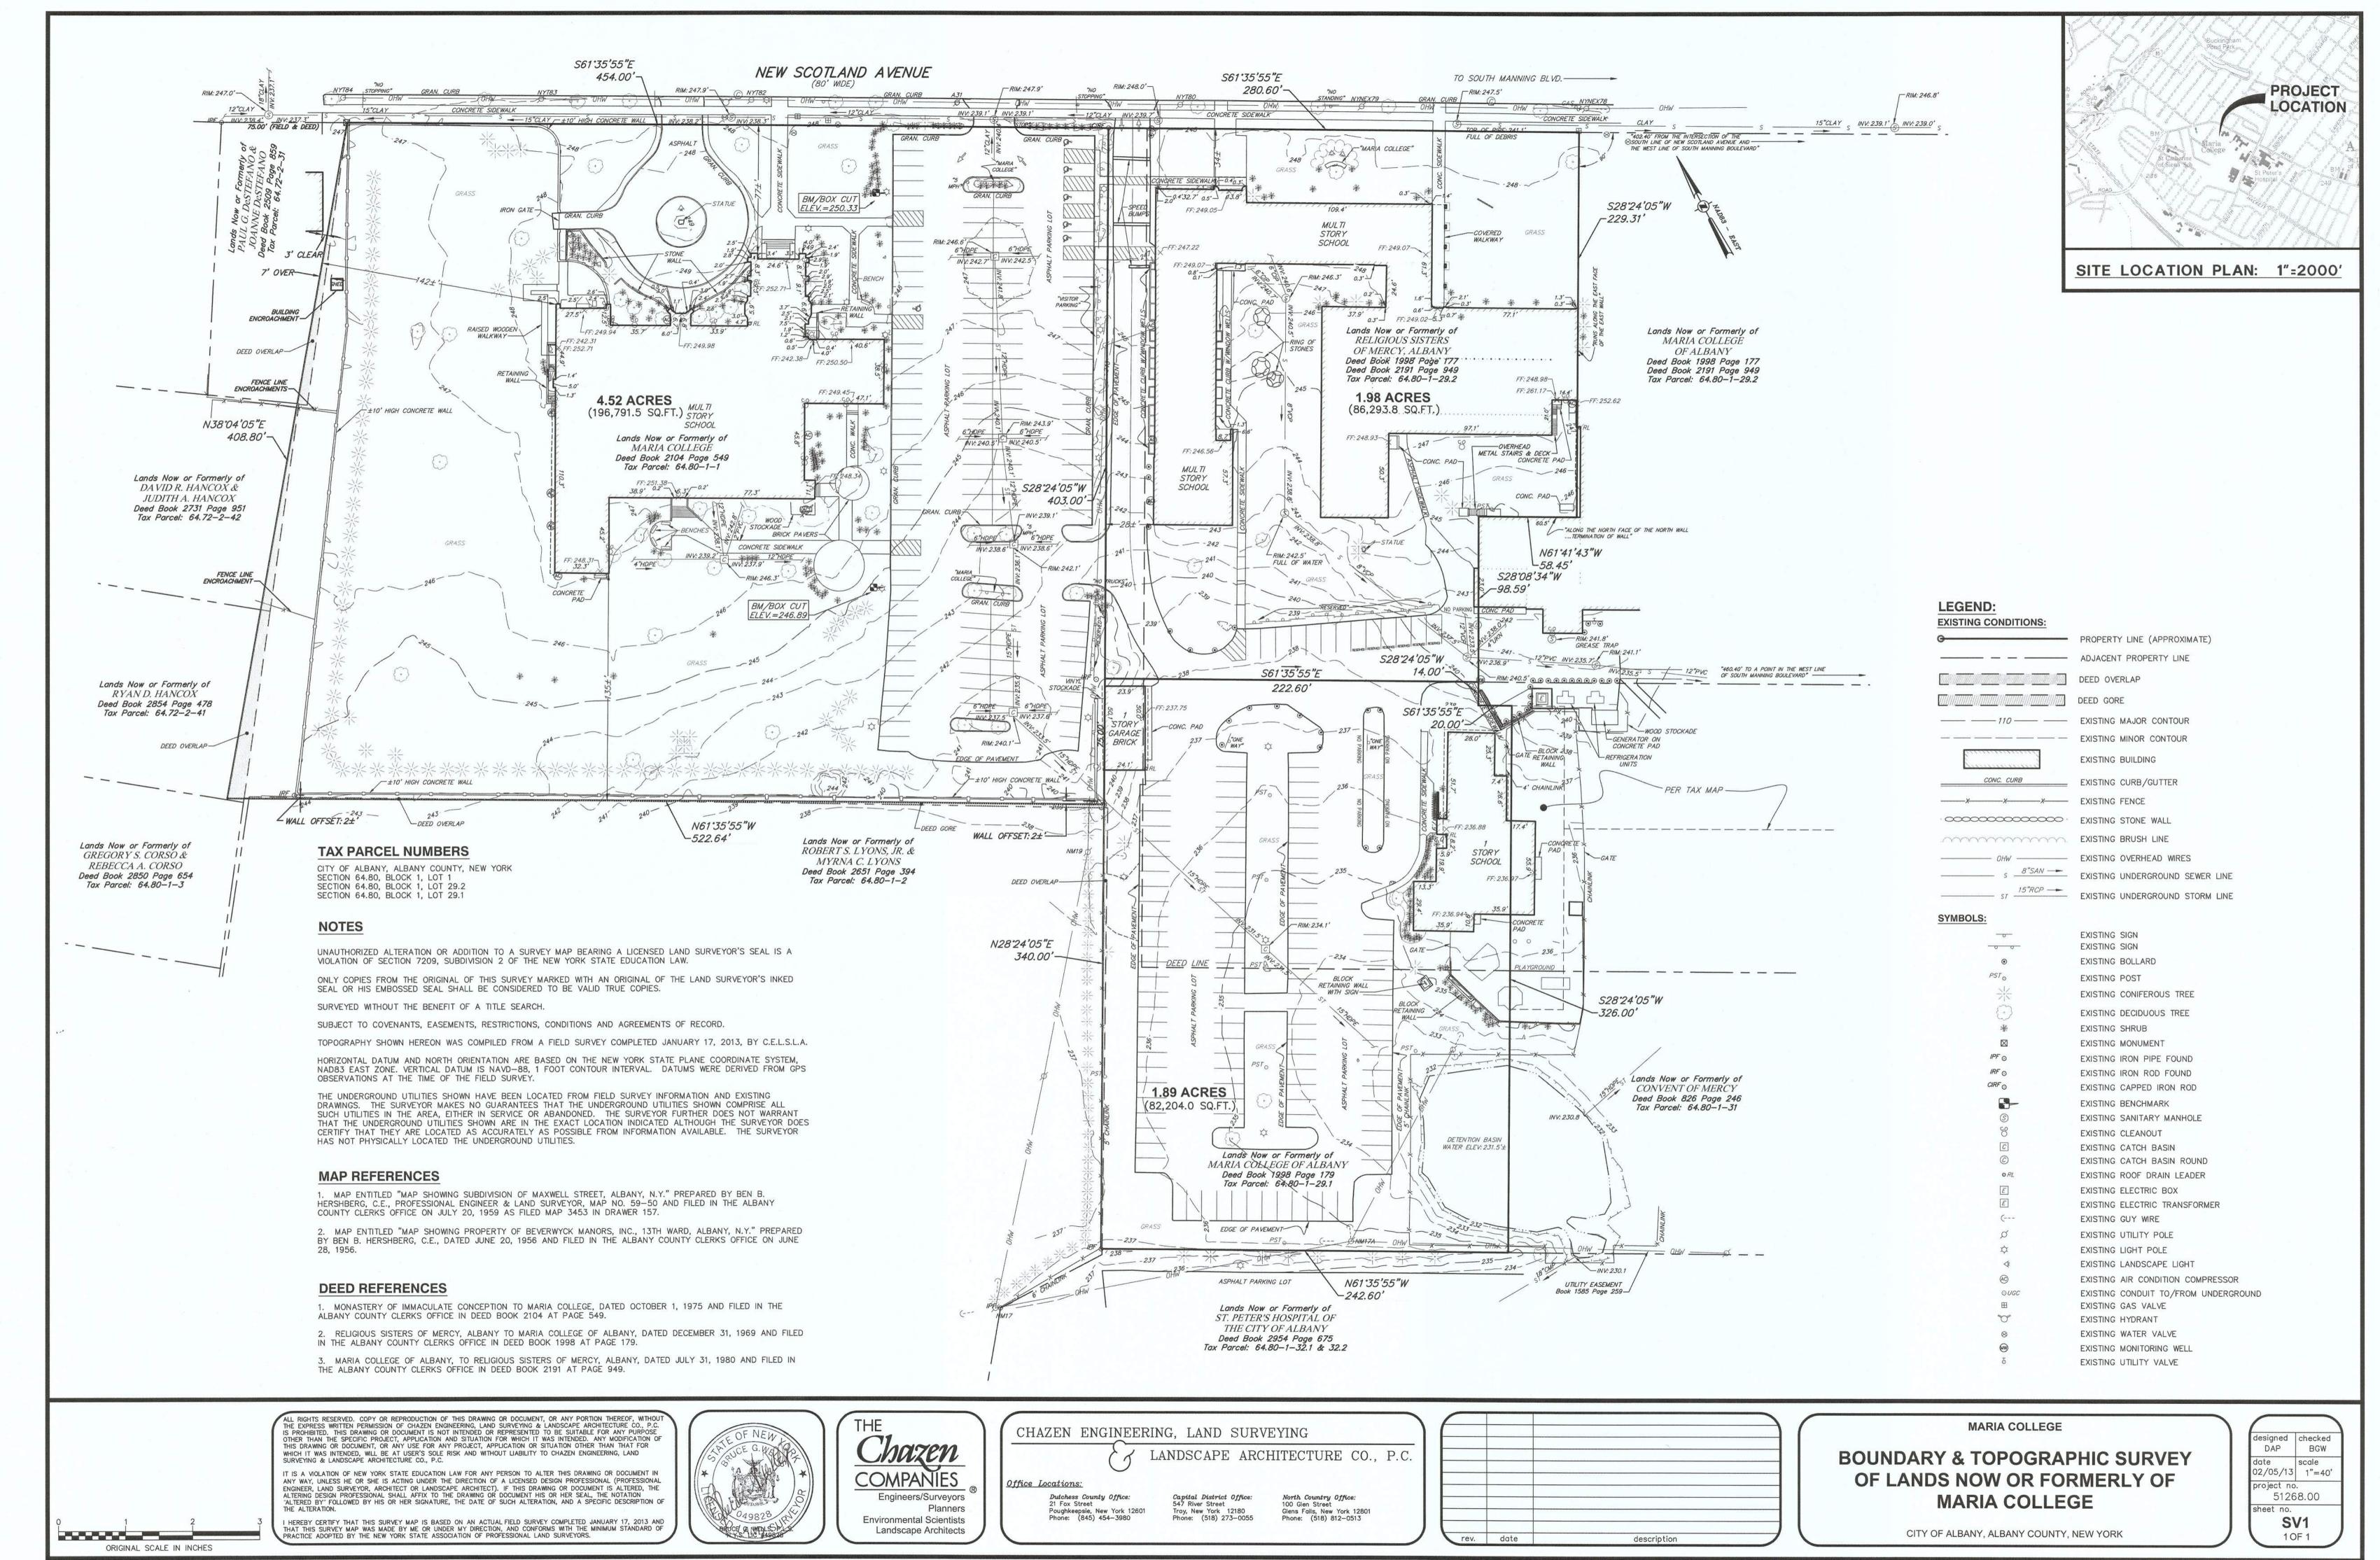

Drawing Name: S:\5\51200-51299\51268.00 Maria College - 12-21-2012\SURVEY\dwg\SV1_51268-00.dwg
Xref's Attached: XBASE_SVY_51268-00
Date Printed: Feb 07, 2013, 4:47pm

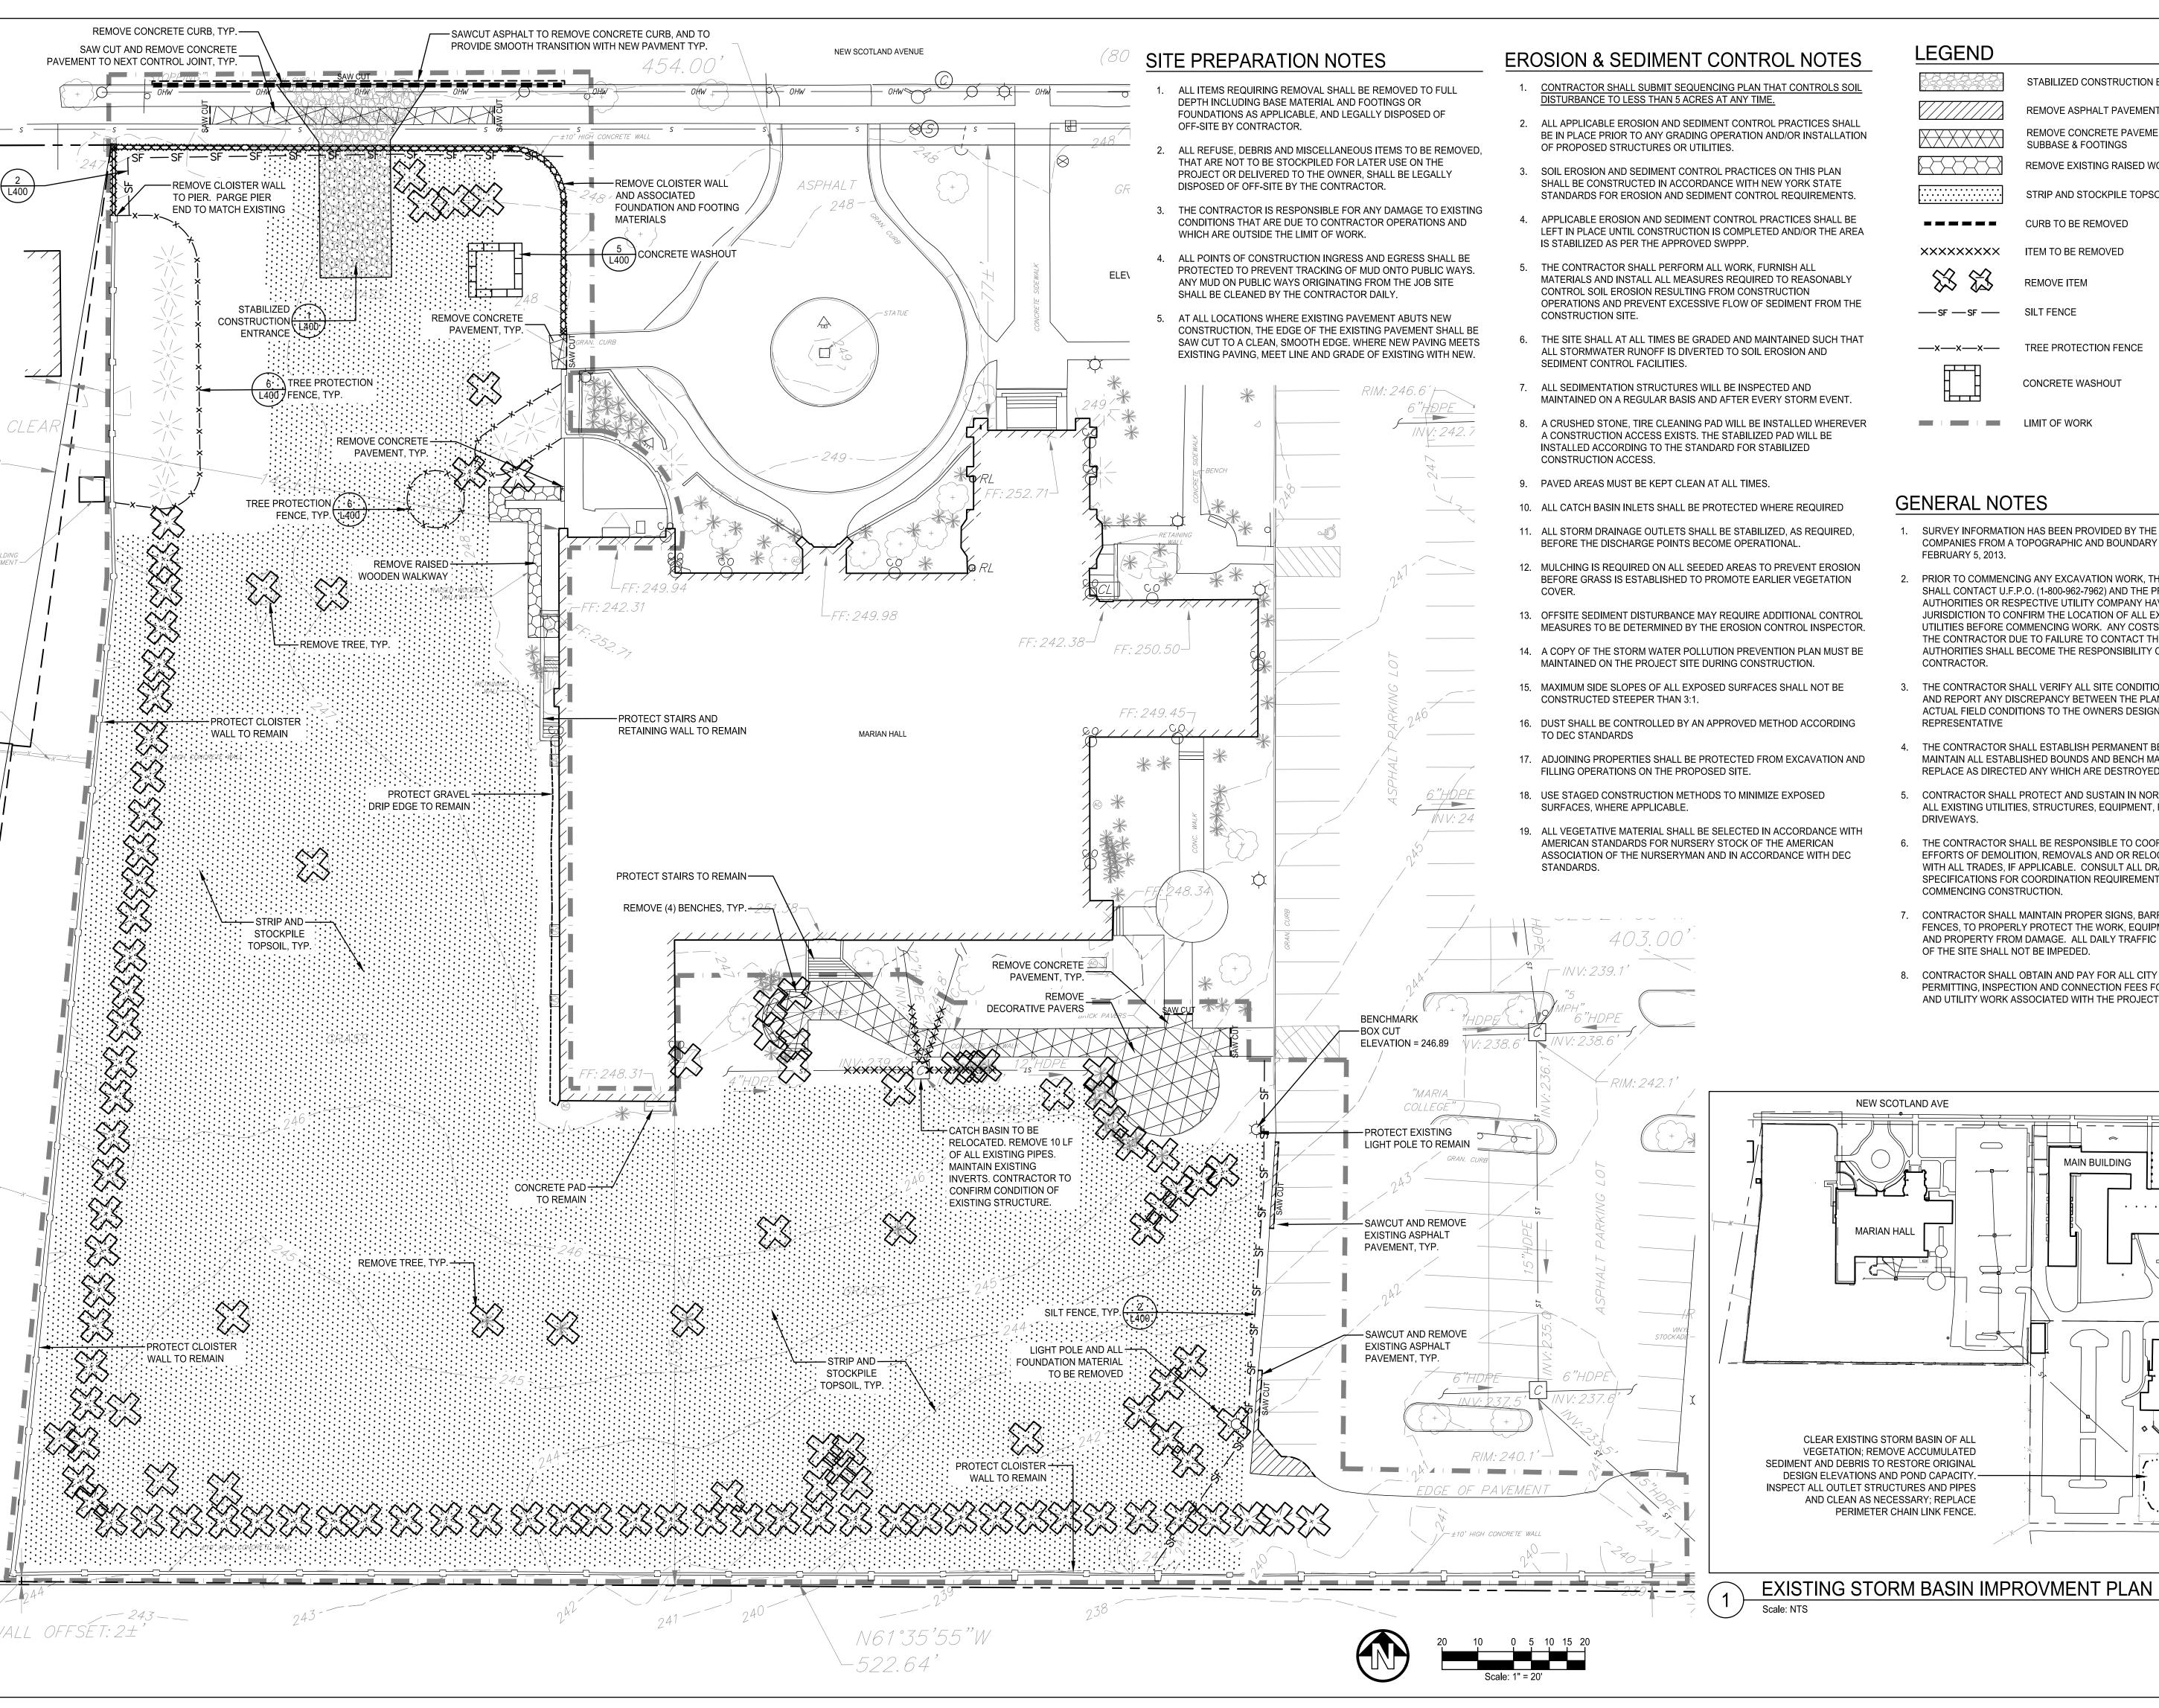

- 2. ALL APPLICABLE EROSION AND SEDIMENT CONTROL PRACTICES SHALL BE IN PLACE PRIOR TO ANY GRADING OPERATION AND/OR INSTALLATION
- LEFT IN PLACE UNTIL CONSTRUCTION IS COMPLETED AND/OR THE AREA
- OPERATIONS AND PREVENT EXCESSIVE FLOW OF SEDIMENT FROM THE
- THE SITE SHALL AT ALL TIMES BE GRADED AND MAINTAINED SUCH THAT
- A CRUSHED STONE, TIRE CLEANING PAD WILL BE INSTALLED WHEREVER

LEGEND

STABILIZED CONSTRUCTION ENTRANCE

REMOVE ASPHALT PAVEMENT & SUBBASE REMOVE CONCRETE PAVEMENT,

 $\mathbb{X} \times \mathbb{X} \times \mathbb{X}$ SUBBASE & FOOTINGS REMOVE EXISTING RAISED WOODEN WALKWAY

ITEM TO BE REMOVED

STRIP AND STOCKPILE TOPSOIL

CURB TO BE REMOVED

XXXXXXXX

REMOVE ITEM

SILT FENCE TREE PROTECTION FENCE

CONCRETE WASHOUT

LIMIT OF WORK

GENERAL NOTES

- 1. SURVEY INFORMATION HAS BEEN PROVIDED BY THE CHAZEN COMPANIES FROM A TOPOGRAPHIC AND BOUNDARY SURVEY DATED FEBRUARY 5, 2013.
- PRIOR TO COMMENCING ANY EXCAVATION WORK, THE CONTRACTOR SHALL CONTACT U.F.P.O. (1-800-962-7962) AND THE PROPER LOCAL AUTHORITIES OR RESPECTIVE UTILITY COMPANY HAVING JURISDICTION TO CONFIRM THE LOCATION OF ALL EXISTING UTILITIES BEFORE COMMENCING WORK. ANY COSTS INCURRED BY THE CONTRACTOR DUE TO FAILURE TO CONTACT THE PROPER AUTHORITIES SHALL BECOME THE RESPONSIBILITY OF THE CONTRACTOR.
- THE CONTRACTOR SHALL VERIFY ALL SITE CONDITIONS IN THE FIELD AND REPORT ANY DISCREPANCY BETWEEN THE PLANS AND THE ACTUAL FIELD CONDITIONS TO THE OWNERS DESIGNATED REPRESENTATIVE
- 4. THE CONTRACTOR SHALL ESTABLISH PERMANENT BENCH MARKS. MAINTAIN ALL ESTABLISHED BOUNDS AND BENCH MARKS AND REPLACE AS DIRECTED ANY WHICH ARE DESTROYED OR DISTURBED.
- 5. CONTRACTOR SHALL PROTECT AND SUSTAIN IN NORMAL SERVICE ALL EXISTING UTILITIES, STRUCTURES, EQUIPMENT, ROADWAYS AND DRIVEWAYS.
- 6. THE CONTRACTOR SHALL BE RESPONSIBLE TO COORDINATE HIS EFFORTS OF DEMOLITION, REMOVALS AND OR RELOCATION WORK WITH ALL TRADES, IF APPLICABLE. CONSULT ALL DRAWINGS AND SPECIFICATIONS FOR COORDINATION REQUIREMENTS BEFORE COMMENCING CONSTRUCTION.
- 7. CONTRACTOR SHALL MAINTAIN PROPER SIGNS, BARRICADES FENCES, TO PROPERLY PROTECT THE WORK, EQUIPMENT, PERSONS AND PROPERTY FROM DAMAGE. ALL DAILY TRAFFIC IN THE VICINITY OF THE SITE SHALL NOT BE IMPEDED.

MAIN BUILDING

MCAULEY

8. CONTRACTOR SHALL OBTAIN AND PAY FOR ALL CITY OF ALBANY PERMITTING, INSPECTION AND CONNECTION FEES FOR DRIVEWAY AND UTILITY WORK ASSOCIATED WITH THE PROJECT.

Maria College Campus **Development Plan** 700 New Scotland Ave. Albany, NY 12208

Project Title:

People, Purpose, Place.

p: 518-587-8100

£518-587-0180

www.thelagroup.com

40 Long Alley

© the LA Group 2017

Prepared for:

ARCHITECT:

M.E.P. ENGINEER:

NY 12866

Saratoga Springs

New York State Education Law.

Maria College

700 New Scotland Ave.

architecture •

Albany, NY 12208

Unauthorized alteration or addition to this


document is a violation of Section 7209 of the

MJM/KAC Ch'k'd: LTM 4/26/19 Scale: AS SHOWN

Drawing Title

SITE REMOVALS & **EROSION CONTROL** PLAN

Drawing No.

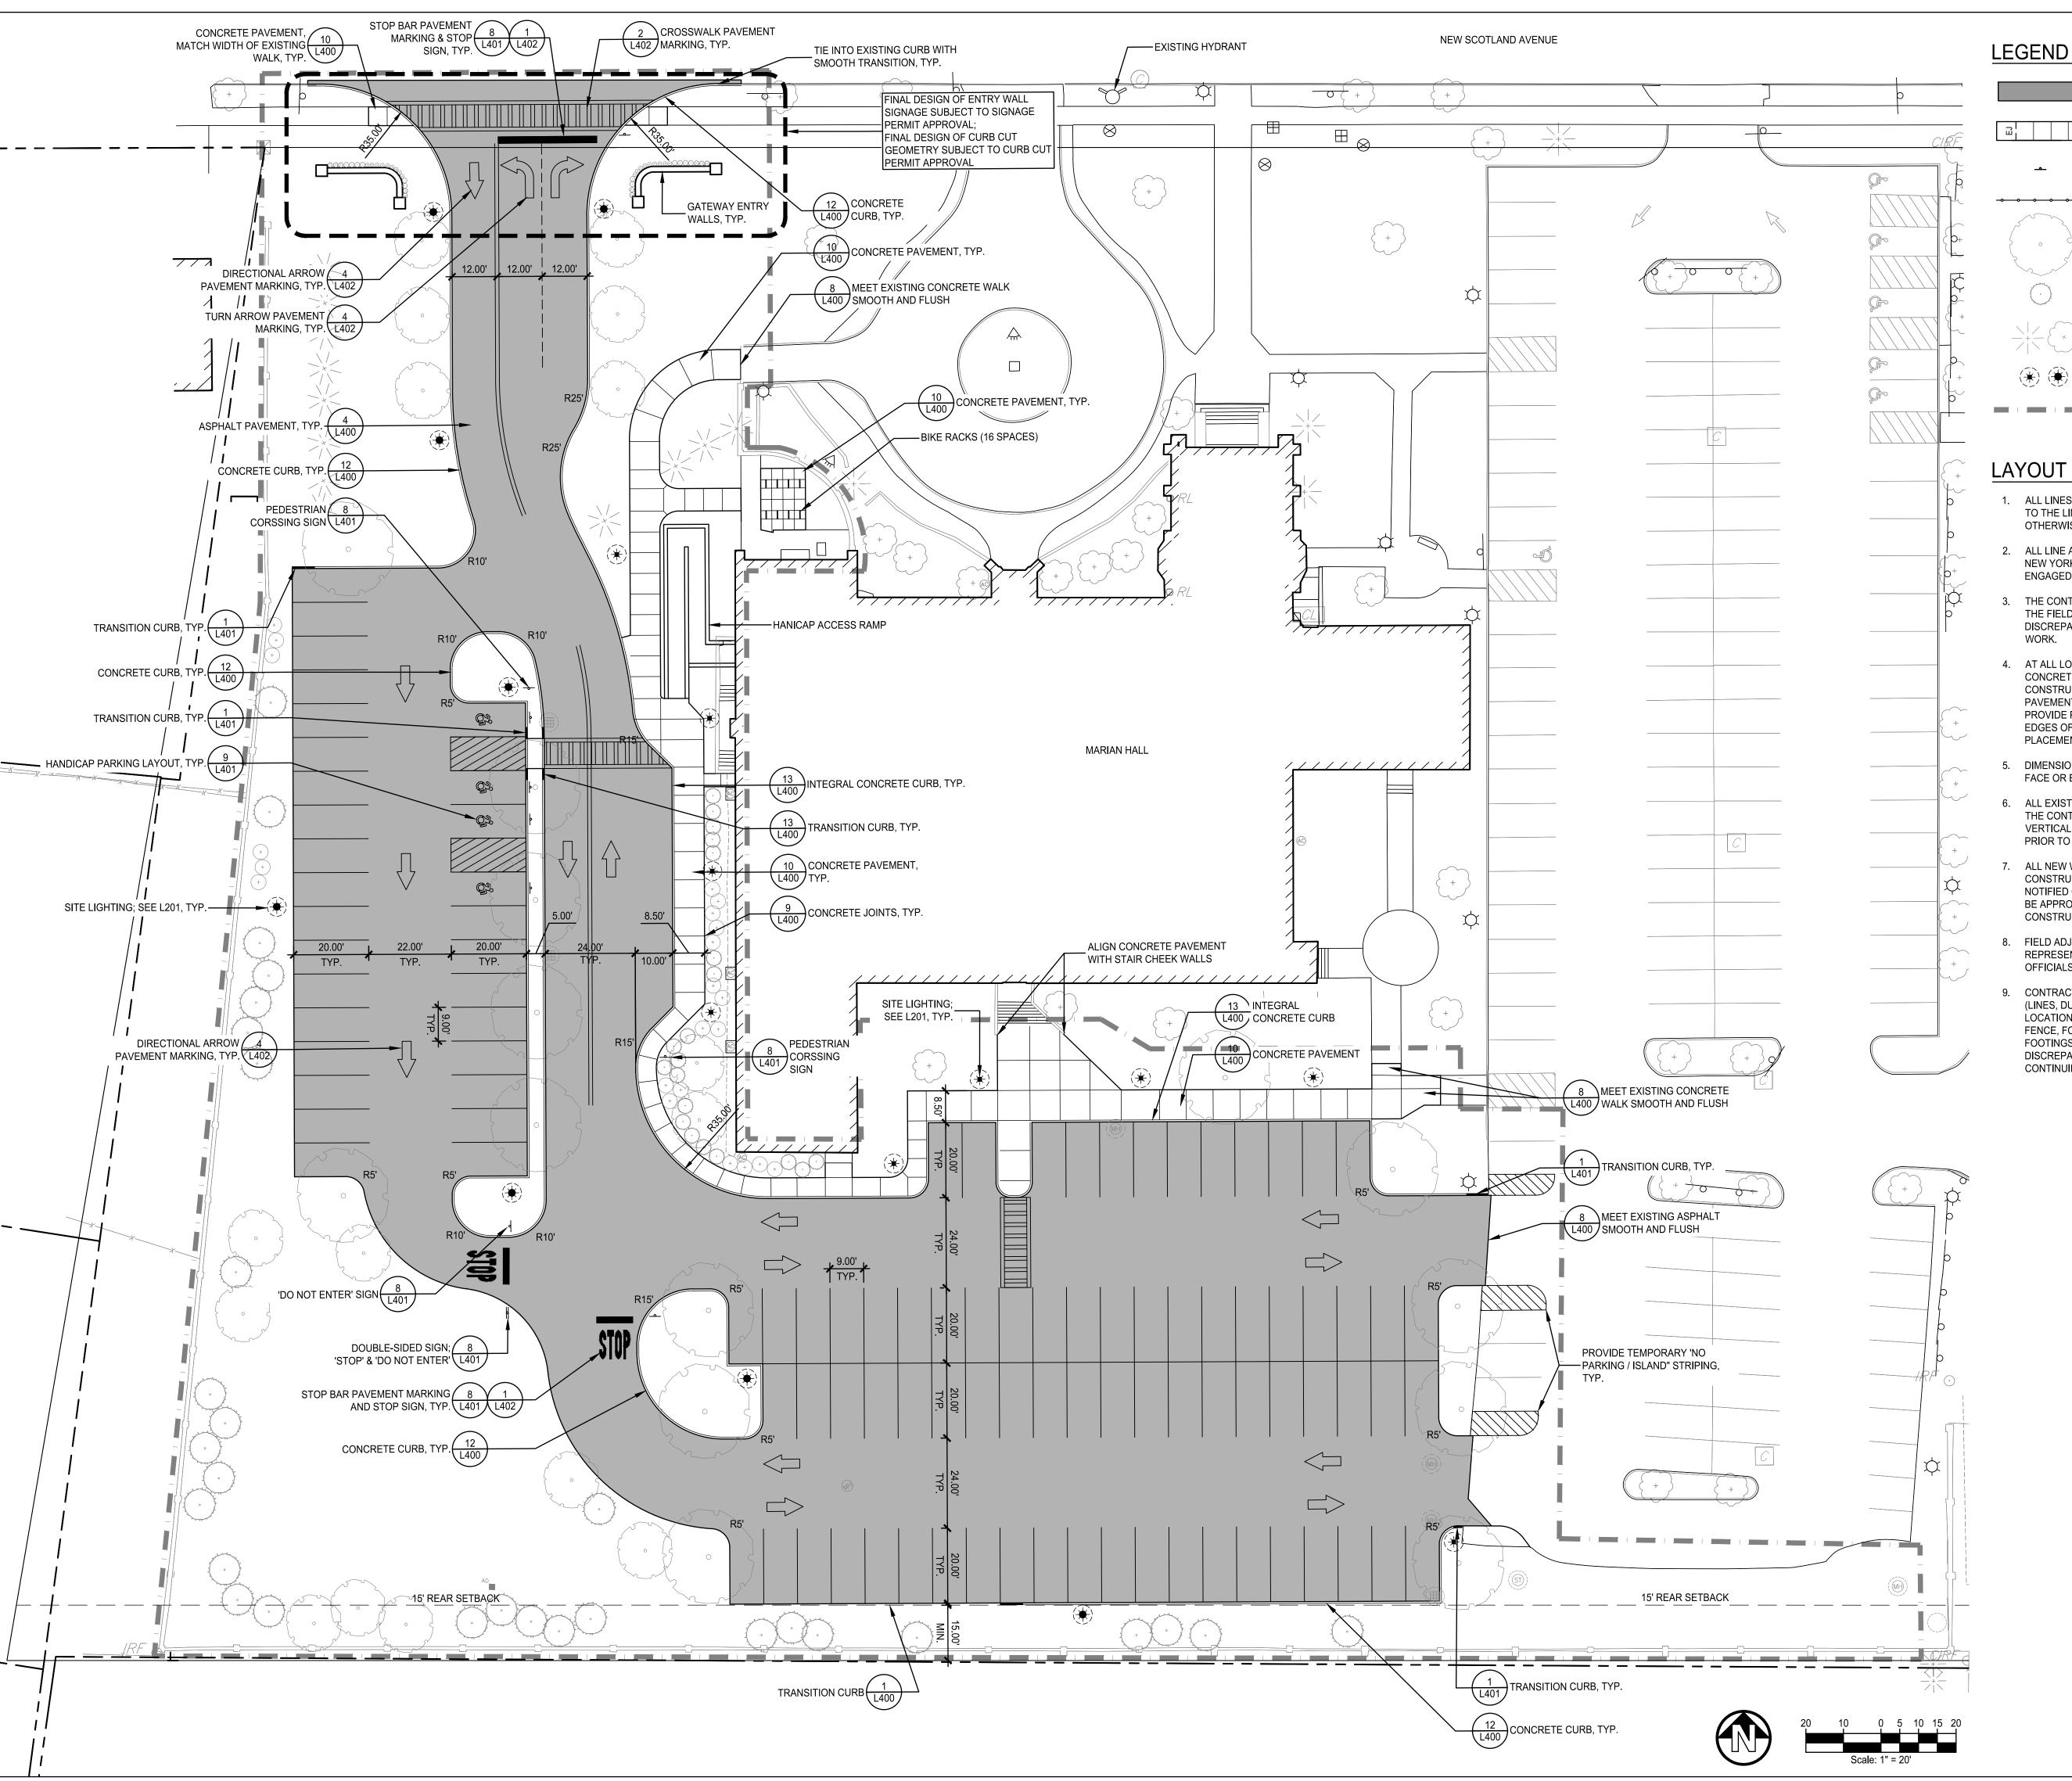


STANDARD-DUTY ASPHALT PAVEMENT

STANDARD-DUTY CONCRETE PAVING

SIGNAGE

→ → → ORNAMENTAL PICKET FENCE

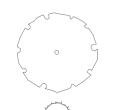

DECIDUOUS TREE; SEE L201

CONIFEROUS TREE; SEE L201

EXISTING TREE

POLE MOUNTED SITE LUMINAIRE (SEE L201)

LIMIT OF WORK

LAYOUT & MATERIALS NOTES

- ALL LINES AND DIMENSIONS ARE PARALLEL OR PERPENDICULAR TO THE LINES FROM WHICH THEY ARE MEASURED UNLESS OTHERWISE INDICATED.
- ALL LINE AND GRADE PER DRAWINGS SHALL BE LAID OUT BY A NEW YORK STATE REGISTERED CIVIL ENGINEER OR SURVEYOR ENGAGED BY THE CONTRACTOR.
- THE CONTRACTOR SHALL VERIFY ALL EXISTING CONDITIONS IN THE FIELD PRIOR TO CONSTRUCTION AND REPORT ANY DISCREPANCIES IN THE SITE SURVEY PRIOR TO STARTING WORK.
- AT ALL LOCATIONS WHERE EXISTING CURBING, BITUMINOUS CONCRETE ROADWAY OR CONCRETE SIDEWALK ABUT NEW CONSTRUCTION, THE EDGE OF THE EXISTING CURB OR PAVEMENT SHALL BE SAW CUT TO A CLEAN, SMOOTH EDGE PROVIDE PAVEMENT KEY AS DETAILED. TACK COAT EXPOSED EDGES OF EXISTING BITUMINOUS CONCRETE PRIOR TO PLACEMENT OF NEW BITUMINOUS CONCRETE PAVEMENT
- DIMENSIONS ON PARKING LOTS AND ROADWAYS ARE FROM FACE OR BOTTOM OF CURB TO FACE OR BOTTOM OF CURB.
- ALL EXISTING UTILITIES SHOWN IN THEIR RELATIVE POSITION. THE CONTRACTOR IS RESPONSIBLE FOR VERIFYING THE VERTICAL AND HORIZONTAL POSITION OF EXISTING UTILITIES PRIOR TO CONSTRUCTION.
- ALL NEW WORK SHALL BE STAKED OUT PRIOR TO CONSTRUCTION. THE OWNER'S REPRESENTATIVE SHALL BE NOTIFIED OF ANY DISCREPANCIES. FIELD ADJUSTMENTS MUST BE APPROVED BY THE OWNER'S REPRESENTATIVE PRIOR TO CONSTRUCTION.
- FIELD ADJUSTMENTS MUST BE APPROVED BY THE OWNER'S REPRESENTATIVE AND IF NECESSARY APPROPRIATE MUNICIPAL OFFICIALS.
- CONTRACTOR SHALL COORDINATE LOCATION OF ALL UTILITIES (LINES, DUCTS, CONDUITS, SLEEVES, FOOTINGS, ETC.) WITH LOCATIONS OF PROPOSED LANDSCAPE ELEMENTS (WALLS, FENCE, FOOTINGS, TREE ROOT BALLS, PROPOSED LIGHTING FOOTINGS, ETC.). CONTRACTOR SHALL REPORT ANY DISCREPANCIES TO OWNER'S REPRESENTATIVE PRIOR TO CONTINUING WORK.

People. Purpose. Place.

40 Long Alley p. 518-587-8100 Saratoga Springs f. 518-587-0180 NY 12866 www.thelagroup.com

Unauthorized alteration or addition to this document is a violation of Section 7209 of the New York State Education Law.

© the LA Group 2017

Prepared for:

Maria College 700 New Scotland Ave. Albany, NY 12208

ARCHITECT:

architecture •

M.E.P. ENGINEER:




Project Title:

Maria College Campus Development Plan

700 New Scotland Ave. Albany, NY 12208


Project No.:			2017131
Design:			MJM
Drawn:	MJM/KAC	Ch'k'd:	LTM
Date:	4/26/19	Scale:	AS SHOWN

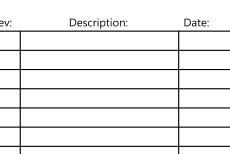

Drawing Title

SITE LAYOUT & MATERIALS PLAN

Drawing No.

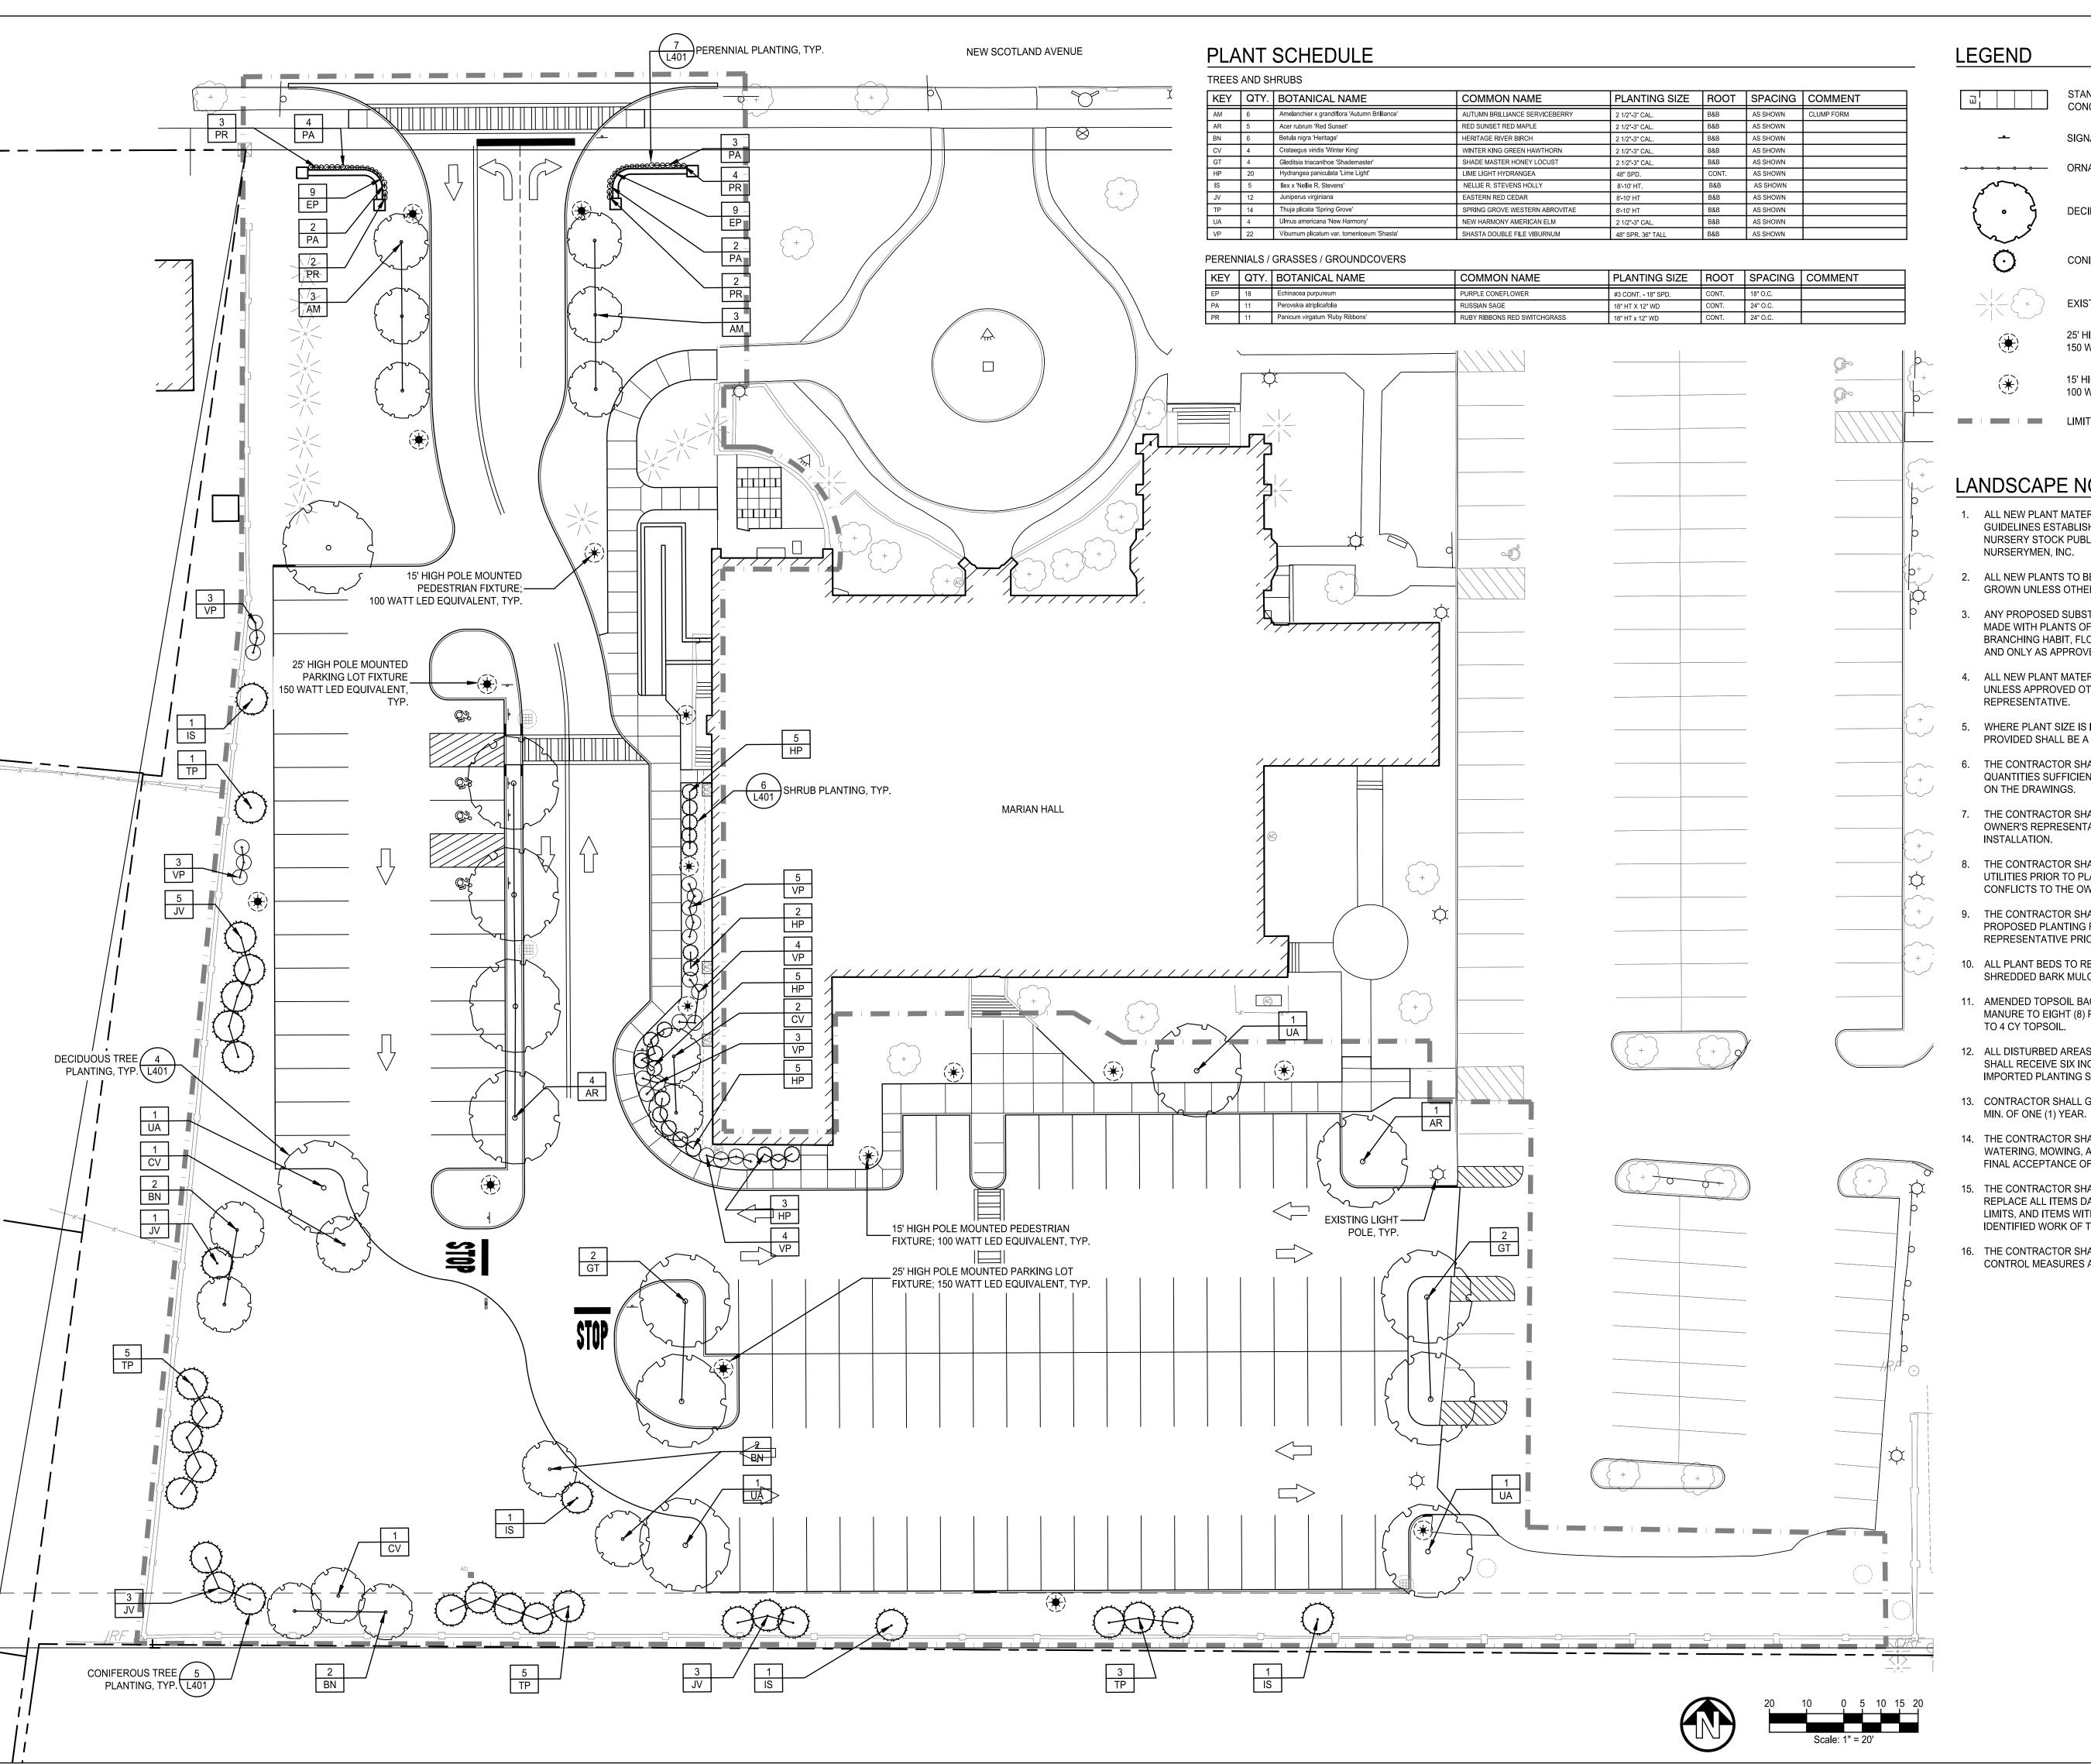

STANDARD-DUTY CONCRETE PAVING

SIGNAGE

ORNAMENTAL PICKET FENCE

DECIDUOUS TREE





CONIFEROUS TREE

EXISTING TREE



25' HIGH POLE MOUNTED PARKING LOT FIXTURE 150 WATT LED EQUIVALENT



15' HIGH POLE MOUNTED PEDESTRIAN FIXTURE;

100 WATT LED EQUIVALENT



LANDSCAPE NOTES

- 1. ALL NEW PLANT MATERIAL SHALL CONFORM TO THE MINIMUM GUIDELINES ESTABLISHED BY THE AMERICAN STANDARD FOR NURSERY STOCK PUBLISHED BY THE AMERICAN ASSOCIATION OF NURSERYMEN, INC.
- 2. ALL NEW PLANTS TO BE BALLED AND BURLAPPED OR CONTAINER GROWN UNLESS OTHERWISE NOTED ON PLANT SCHEDULE.
- ANY PROPOSED SUBSTITUTIONS OF PLANT SPECIES SHALL BE MADE WITH PLANTS OF EQUIVALENT OVERALL FORM, HEIGHT, BRANCHING HABIT, FLOWER, LEAF, COLOR, FRUIT AND CULTURE, AND ONLY AS APPROVED BY THE OWNER'S REPRESENTATIVE.
- 4. ALL NEW PLANT MATERIAL SHALL BE OF SPECIMEN QUALITY UNLESS APPROVED OTHERWISE BY THE OWNER'S REPRESENTATIVE.
- WHERE PLANT SIZE IS INDICATED AS A RANGE, THE PLANTS PROVIDED SHALL BE A FAIR REPRESENTATION OF THAT RANGE.
- THE CONTRACTOR SHALL SUPPLY ALL NEW PLANT MATERIAL IN QUANTITIES SUFFICIENT TO COMPLETE THE PLANTING SHOWN ON THE DRAWINGS.
- THE CONTRACTOR SHALL OBTAIN PLANT APPROVAL FROM THE OWNER'S REPRESENTATIVE AFTER DELIVERY AND PRIOR TO INSTALLATION.
- THE CONTRACTOR SHALL LOCATE AND VERIFY ALL EXISTING UTILITIES PRIOR TO PLANTING AND SHALL REPORT ANY CONFLICTS TO THE OWNER'S REPRESENTATIVE.
- 9. THE CONTRACTOR SHALL STAKE THE LOCATIONS OF ALL PROPOSED PLANTING FOR APPROVAL BY THE OWNER'S REPRESENTATIVE PRIOR TO THE COMMENCEMENT OF PLANTING.
- 10. ALL PLANT BEDS TO RECEIVE THREE INCHES (2") MIN. OF SHREDDED BARK MULCH ON WEED BARRIER FABRIC.
- 11. AMENDED TOPSOIL BACKFILL SHALL CONSIST OF ONE (1) PART MANURE TO EIGHT (8) PARTS TOPSOIL AND BONEMEAL @ 20 LBS. TO 4 CY TOPSOIL.
- ALL DISTURBED AREAS NOT SCHEDULED FOR OTHER WORK SHALL RECEIVE SIX INCHES (6") OF SUITABLE ON-SITE OR IMPORTED PLANTING SOIL PRIOR TO SEEDING OR SODDING.
- 13. CONTRACTOR SHALL GUARANTEE ALL PLANT MATERIAL FOR A
- 14. THE CONTRACTOR SHALL MAINTAIN ALL WORK INCLUDING WATERING, MOWING, AND PROTECTION FROM TRAFFIC UNTIL FINAL ACCEPTANCE OF THE PROJECT.
- 15. THE CONTRACTOR SHALL BE RESPONSIBLE TO REPAIR OR REPLACE ALL ITEMS DAMAGED OUTSIDE THE CONSTRUCTION LIMITS, AND ITEMS WITHIN THE SITE THAT ARE NOT PART OF THE IDENTIFIED WORK OF THIS CONTRACT.
- 16. THE CONTRACTOR SHALL PROVIDE AND MAINTAIN EROSION CONTROL MEASURES AS SHOWN ON THE PLANS.

People. Purpose. Place.

40 Long Alley p. 518-587-8100 Saratoga Springs f. 518-587-0180 NY 12866

Unauthorized alteration or addition to this document is a violation of Section 7209 of the New York State Education Law.

© the LA Group 2017

Prepared for: Maria College

700 New Scotland Ave. Albany, NY 12208

ARCHITECT:

architecture •

M.E.P. ENGINEER:




Project Title:

Maria College Campus Development Plan

700 New Scotland Ave. Albany, NY 12208


Project No.:			2017131
Design:			MJM
Drawn:	MJM/KAC	Ch'k'd:	LTM
Date:	4/26/19	Scale:	AS SHOWN

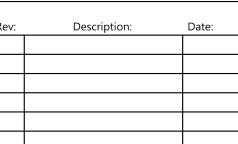

Drawing Title

SITE LIGHTING & LANDSCAPE PLAN

Drawing No.

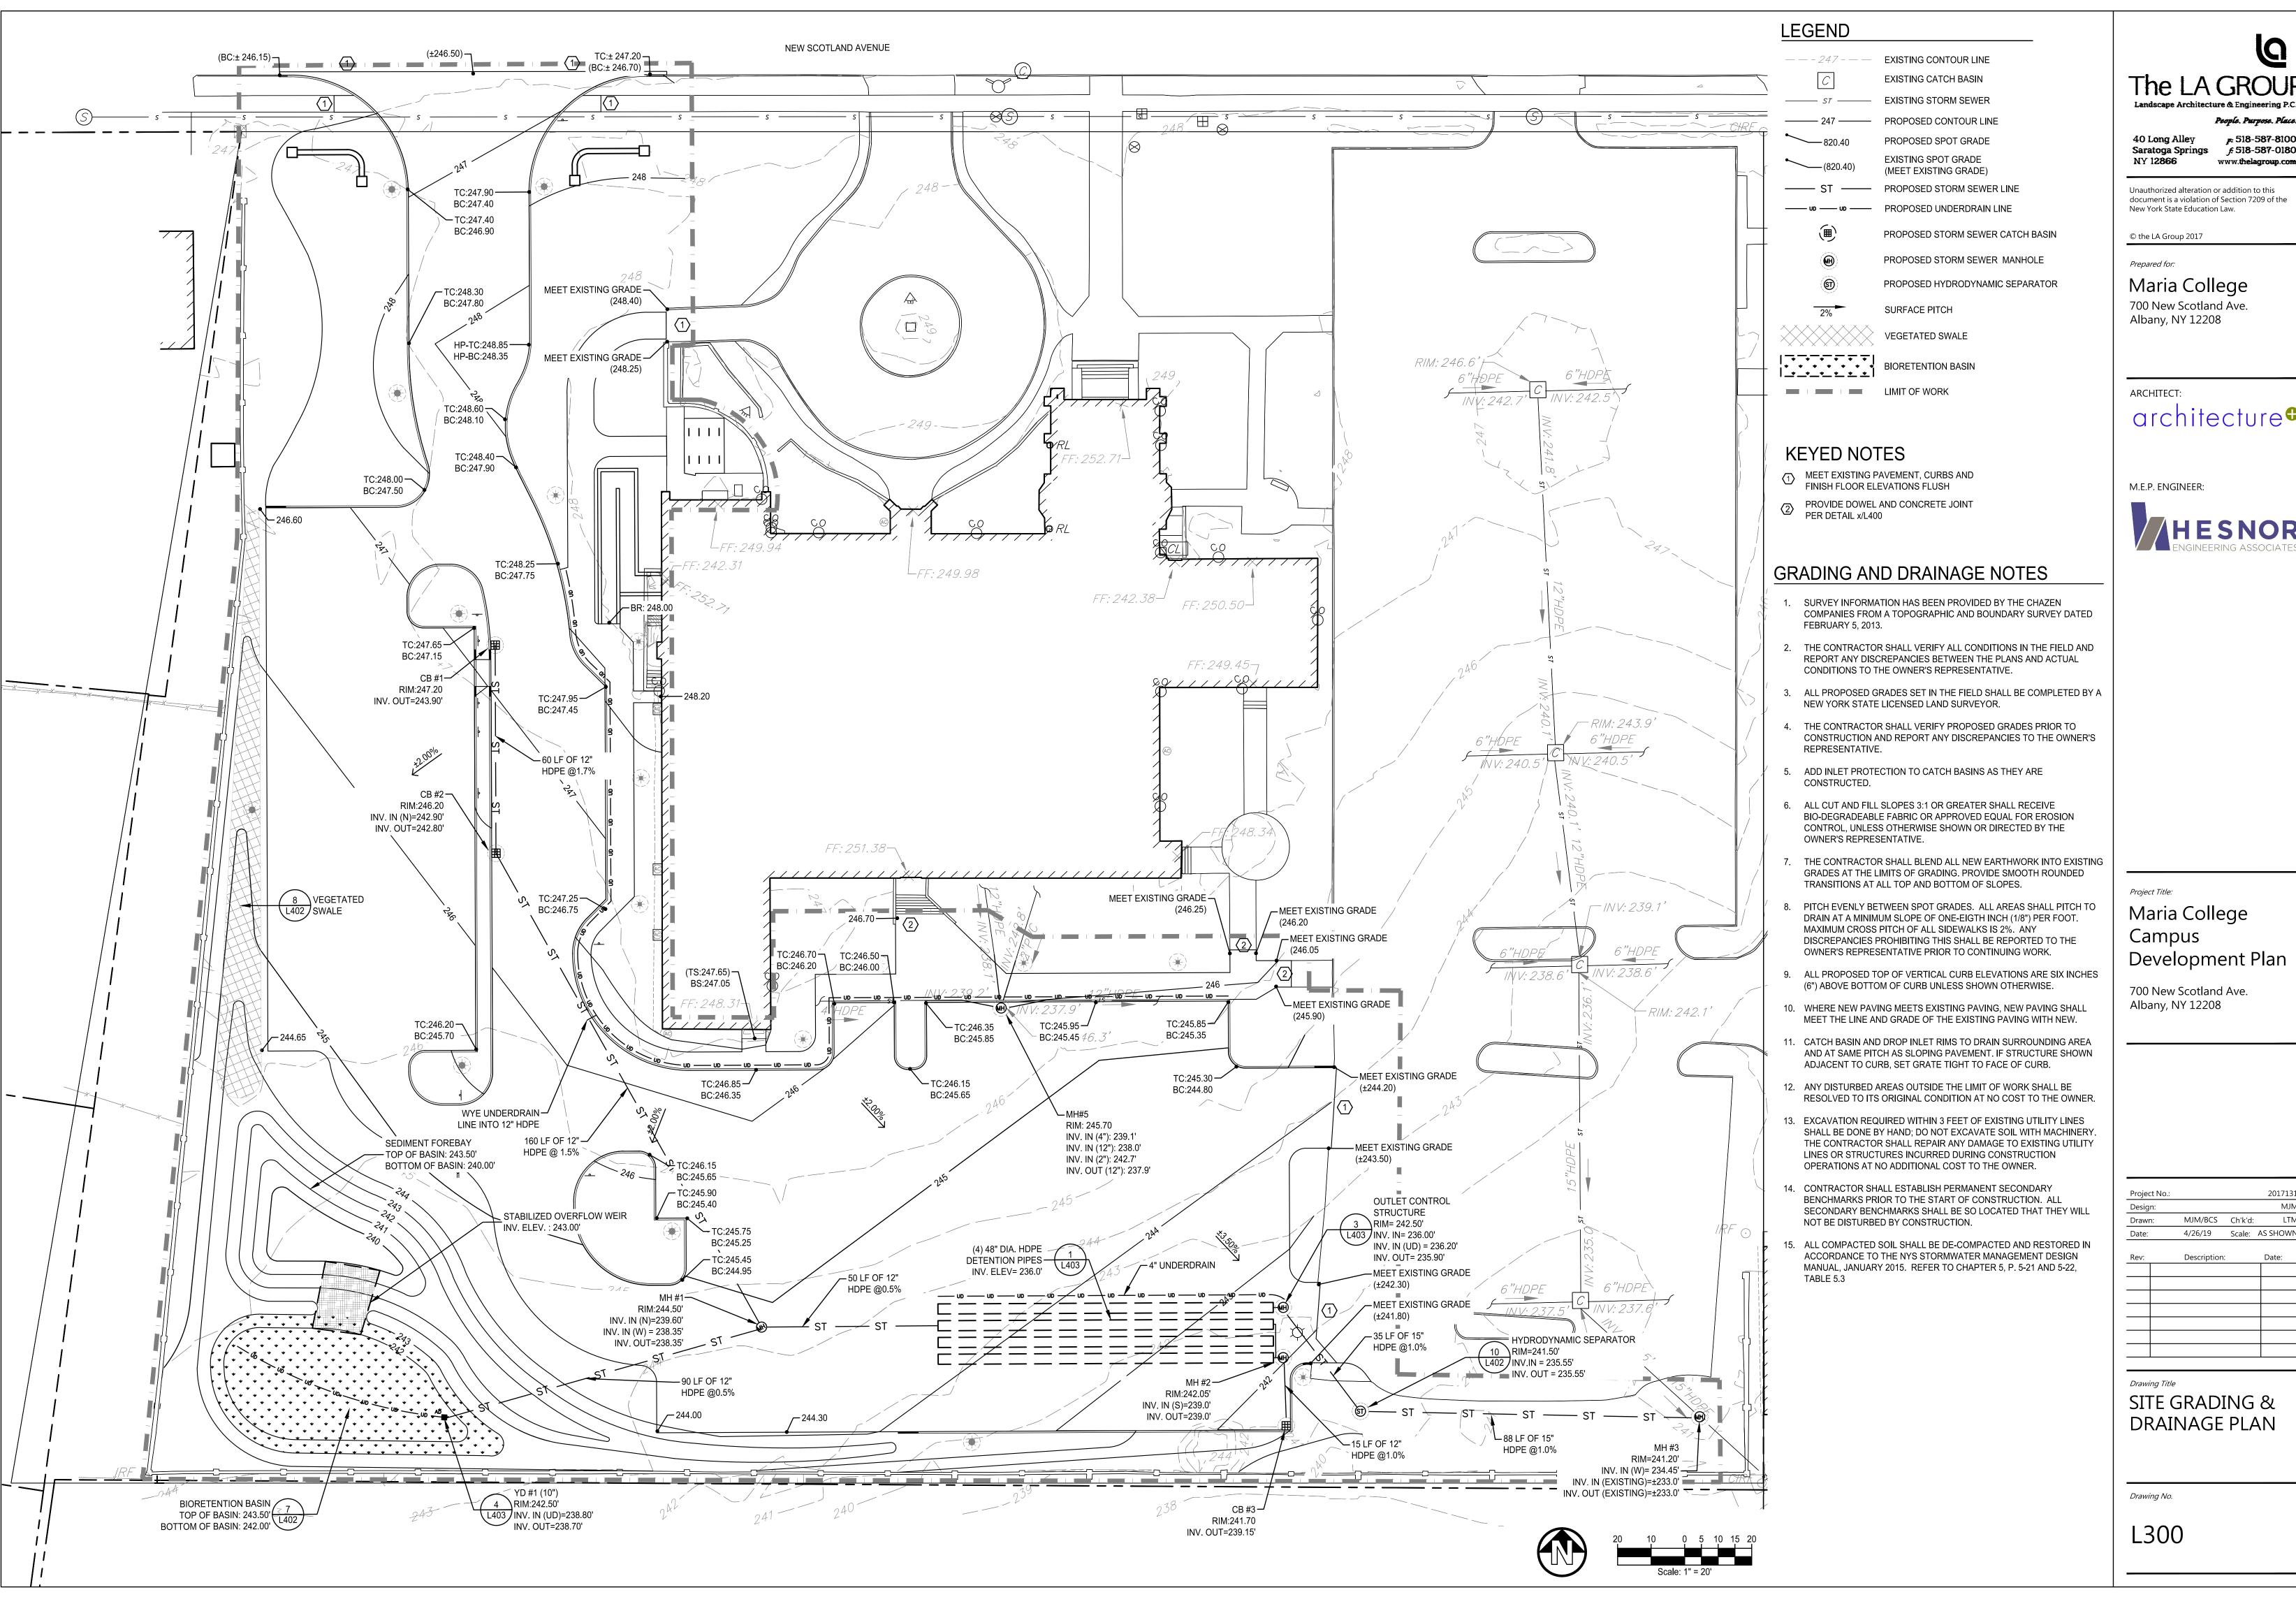

40 Long Alley p. 518-587-8100 Saratoga Springs f. 518-587-0180

Unauthorized alteration or addition to this document is a violation of Section 7209 of the

700 New Scotland Ave.

architecture •




Maria College **Development Plan**


700 New Scotland Ave.

oject No.:			2017131
esign:			MJM
rawn:	MJM/BCS	Ch'k'd:	LTM
ate:	4/26/19	Scale:	AS SHOWN
			,

SITE GRADING & DRAINAGE PLAN

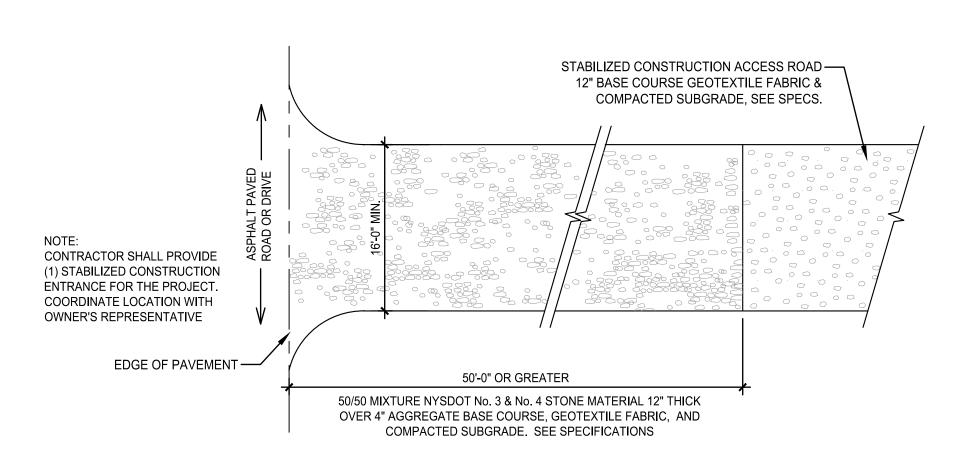


STABILIZED CONSTRUCTION ENTRANCE

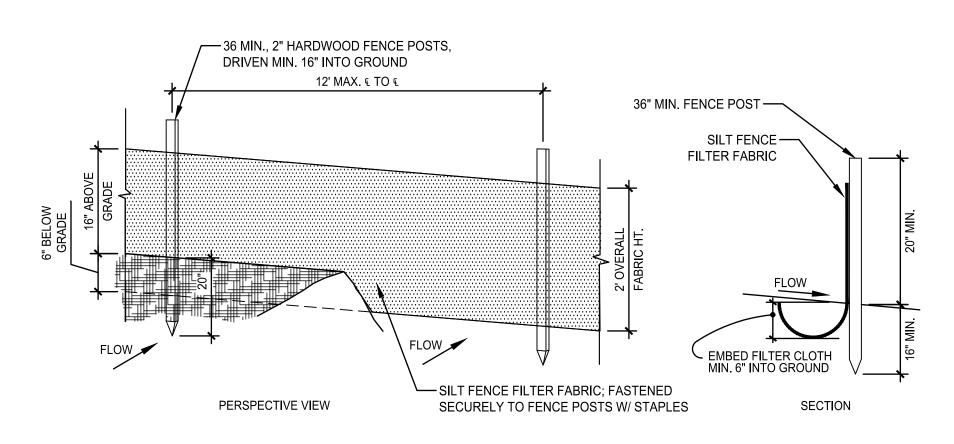

SILT FENCE

Scale: NTS

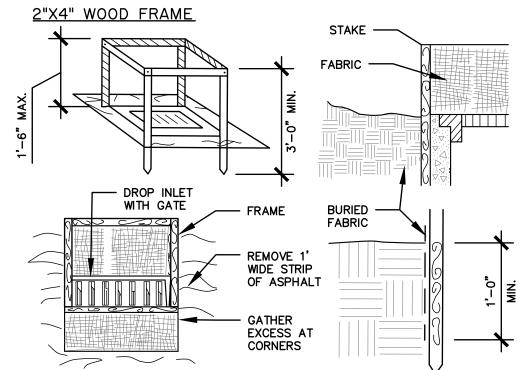

CONSTRUCTION SPECIFICATIONS

- I. FILTER FABRIC SHALL HAVE AN EOS OF 40-85. BURLAP MAY BE USED FOR SHORT
- 2. CUT FABRIC FROM A CONTINUOUS ROLL TO ELIMINATE JOINTS. IF JOINTS ARE NEEDED THEY WILL BE OVERLAPPED TO THE NEXT STAKE. 3. STAKE MATERIALS WILL BE STANDARD 2" x 4" WOOD OR EQUIVALENT.nMETAL WITH A MINIMUM LENGTH OF 3 FEET.
- 4. SPACE STAKES EVENLY AROUND INLET 3 FEET APART AND DRIVE A MINIMUM 18 INCHES DEEP. SPANS GREATER THAN 3 FEET MAY BE BRIDGED WITH THE USE OF WIRE
- MESH BEHIND THE FILTER FABRIC FOR SUPPORT. 5. FABRIC SHALL BE EMBEDDED I FOOT MINIMUM BELOW GROUND AND BACKFILLED. IT
- SHALL BE SECURELY FASTENED TO THE STAKES AND FRAME. 6. A 2" x 4" WOOD FRAME SHALL BE COMPLETED AROUND THE CREST OF THE FABRIC
- FOR OVER FLOW STABILITY. 7. TO BE USED OUTSIDE OF PAVED AREAS.

MAXIMUM DRAINAGE AREA I ACRE

INLET PROTECTION - LAWN AREAS

-USE SILT SACK UNDER GRATE TO CONTROL SEDIMENT RUNOFF. SACK SHALL BE MAINTAINED AND CLEANED ON A REGULAR BASIS (SEE NOTE BELOW)


I. SILT SACK SHALL BE MAINTAINED & REMOVED ONLY AFTER ACCEPTANCE OF ROADWAY. SILT SACK SHALL BE CLEANED PERIODICALLY TO KEEP CATCH BASIN WORKING PROPERLY WHILE IN PLACE AT REMOVAL OF SILT SACK ALL CATCH BASINS SHALL BE CLEANED OF DEBRIS

2. GRATE SILT SACK SHALL ONLY BE USED FOR IN-PAVEMENT STRUCTURES ONLY DURING AND AFTER INSTALLATION OF PAVEMENT.

INLET PROTECTION - FINISHED PAVED AREAS

Scale: NTS


Scale: NTS

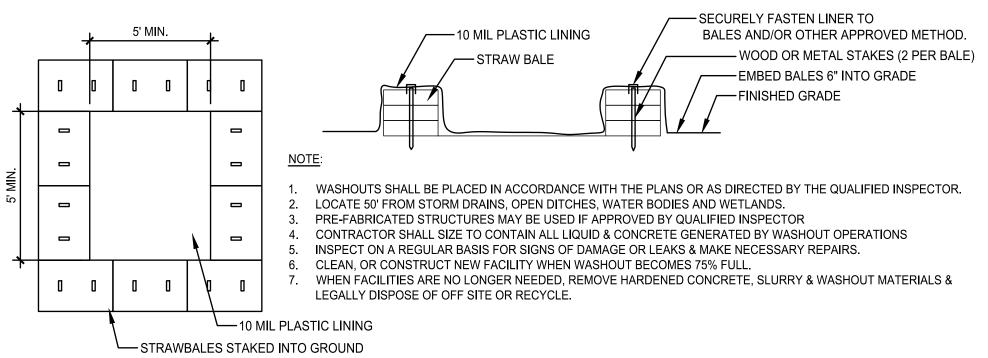


CONCRETE WASHOUT

POLYETHYLENE WARNING FENCE -WATERPROOF PERMANENT SIGN READING: "TREE PROTECTION AREA" -METAL POST

TREE PROTECTION

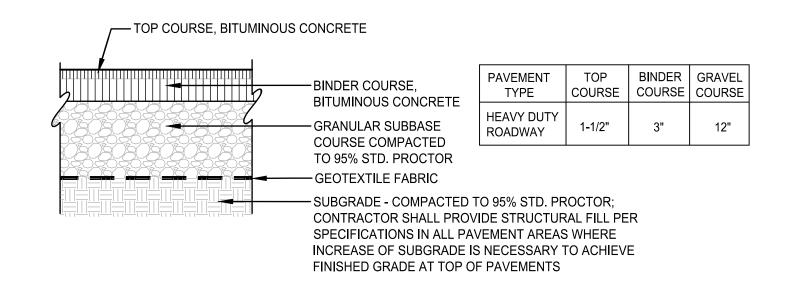


ASPHALT PAVEMENT

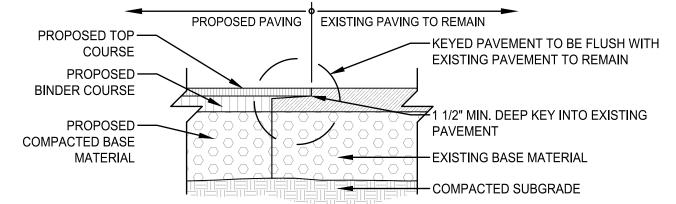


NOTE: THIS DETAIL IS FOR A NEW BITUMINOUS PAVEMENT ADJACENT TO EXISTING BITUMINOUS PAVEMENT TO REMAIN.


ASPHALT PAVEMENT KEY

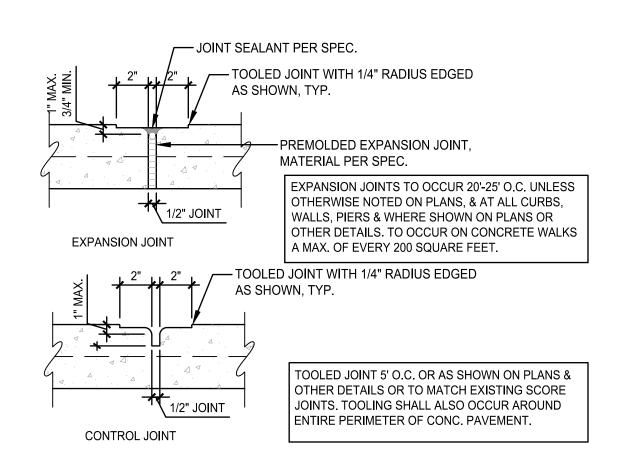


CONCRETE JOINTS

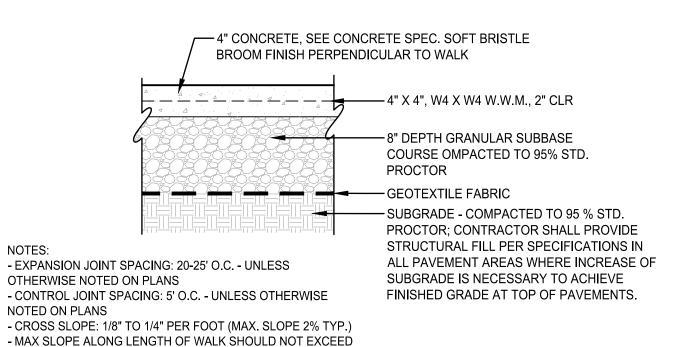


CONCRETE PAVEMENT

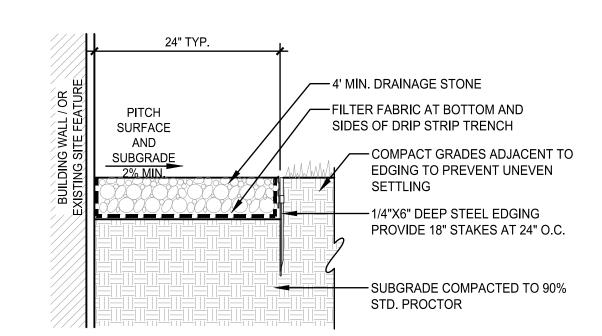

PAVEMENT DRIP STRIP

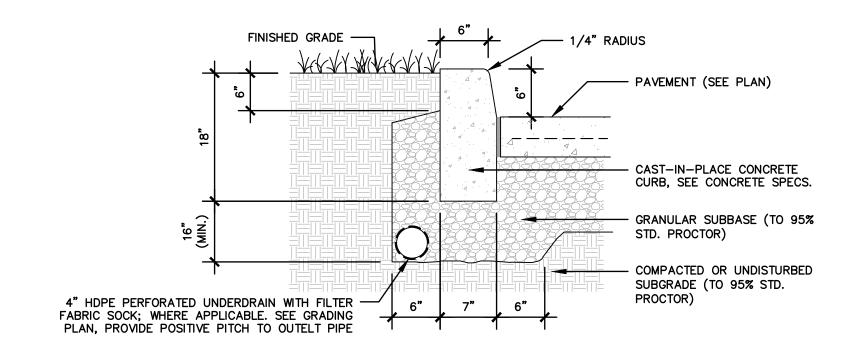

CONCRETE CURB WITH UNDERDRAIN

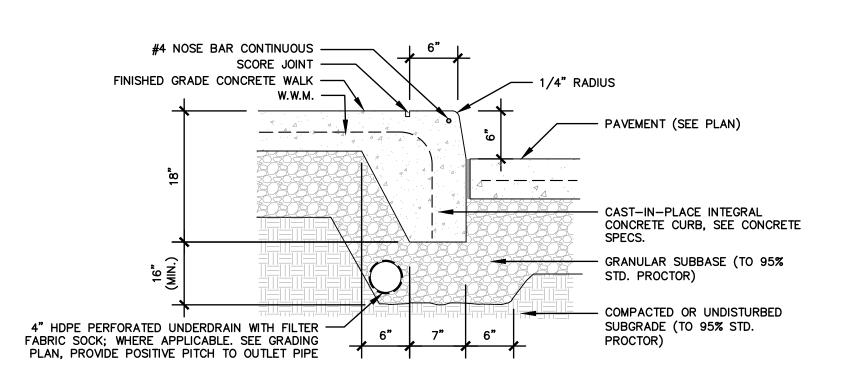

INTEGRAL CURB WITH UNDERDRAIN

Scale: NTS

4/26/19 Scale: Description:

L400

People, Purpose, Place. 40 Long Alley p: 518-587-8100 Saratoga Springs *f*: 518-587-0180

NY 12866 Unauthorized alteration or addition to this document is a violation of Section 7209 of the New York State Education Law.

© the LA Group 2017

Prepared for: Maria College

700 New Scotland Ave. Albany, NY 12208

ARCHITECT:

architecture •

M.E.P. ENGINEER:



Project Title:

Maria College Campus **Development Plan**


700 New Scotland Ave. Albany, NY 12208

Project No.: MJM/KAC Ch'k'd: LTM NTS

Drawing Title


SITE DETAILS

Drawing No.

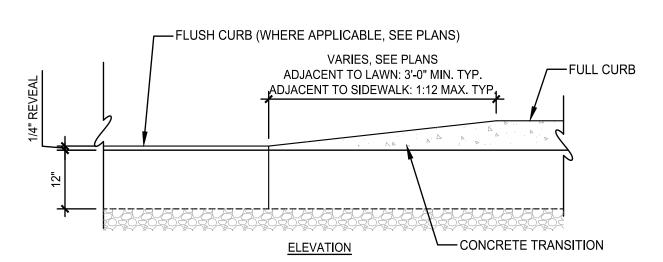


CONCRETE TRANSITION AND FLUSH CURB


Scale: NTS

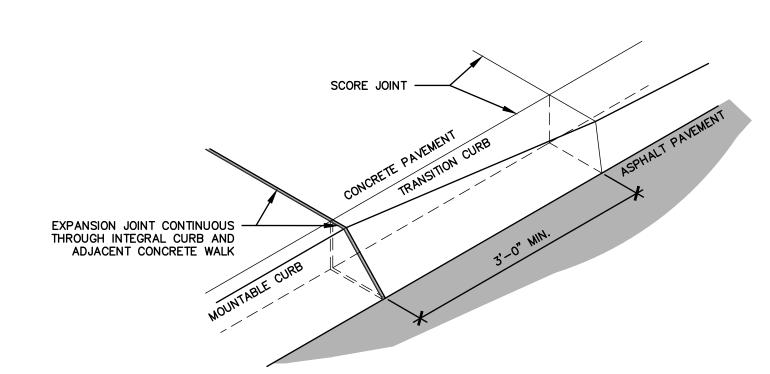


CONCRETE TRANSITION AND MOUNTABLE CURB

Scale: NTS

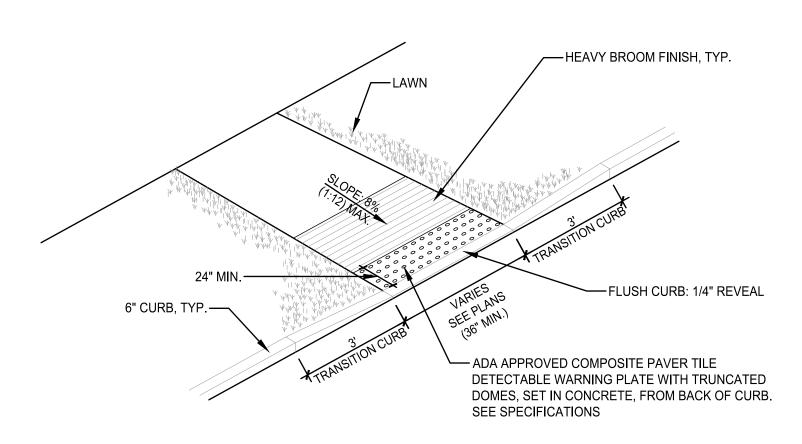

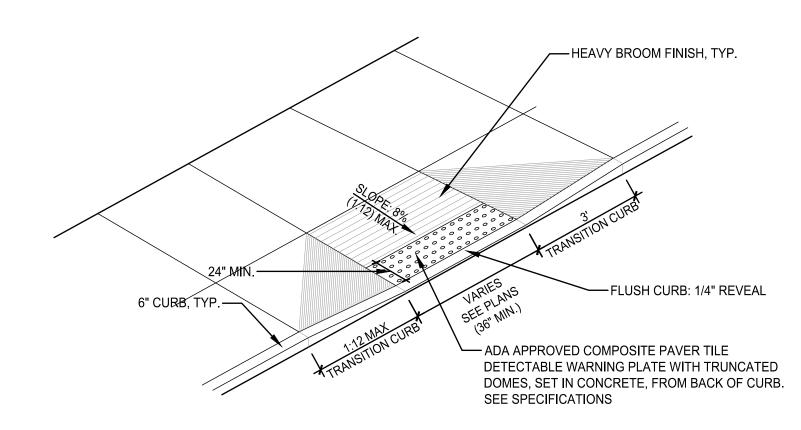


DROP CURB / CURB RAMP

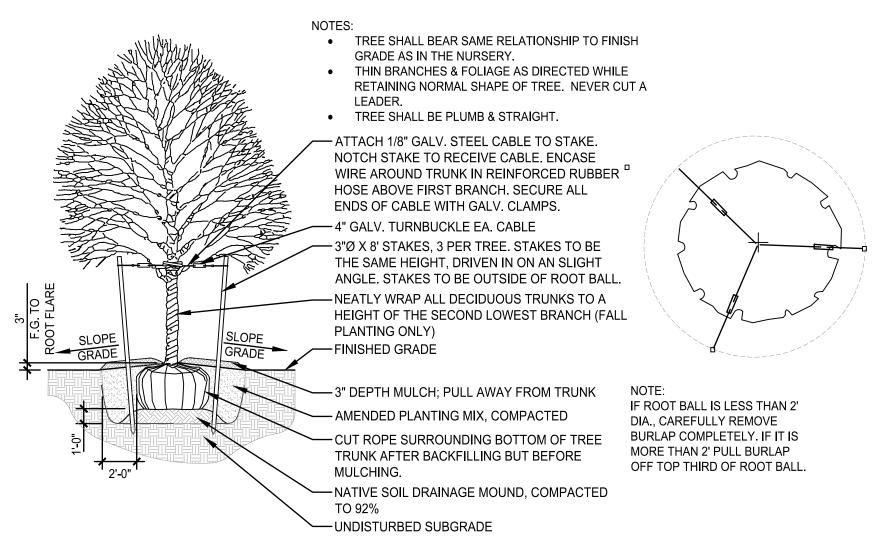


DECIDUOUS TREE

 TREE SHALL BEAR SAME RELATIONSHIP TO FINISH GRADE AS IN THE NURSERY. NEVER CUT A LEADER TREE SHALL BE PLUMB & STRAIGHT -INSTALL 3 GUYS PER TREE EQUALLY SPACED AROUND ROOT BALL. ATTACH 1/8" GALV. STEEL CABLES @ 2/3 HEIGHT OF TREE. PROVIDE REINFORCED RUBBER HOSE TO ENCASE CABLE AROUND TRUNK. SECURE ALL ENDS OF CABLE W/ GALV. CLAMPS — 3"Ø X 2'-0" CEDAR STAKES, 3 PER TREE, DRIVEN IN AT A 25° ANGLE; STAKES TO BE OUTSIDE OF TREE PIT - 3" DEPTH PINE BARK MULCH; PULL MULCH AWAY FROM TRUNK - AMENDED PLANTING MIX, COMPACTED IF ROOT BALL IS LESS THAN 2' -CUT ROPE SURROUNDING BOTTOM OF TREE DIA. CAREFULLY REMOVE TRUNK AFTER BACKFILLING BUT BEFORE BURLAP COMPLETELY. IF IT IS MORE THAN 2' PULL BURLAP OFF NATIVE SOIL DRAINAGE MOUND, COMPACT TO TOP THIRD OF ROOT BALL. -UNDISTURBED SUBGRADE


CONIFEROUS TREE

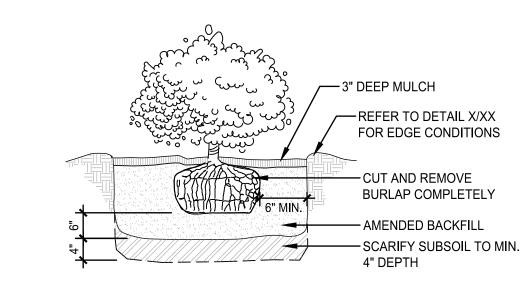

SHRUB PLANTING

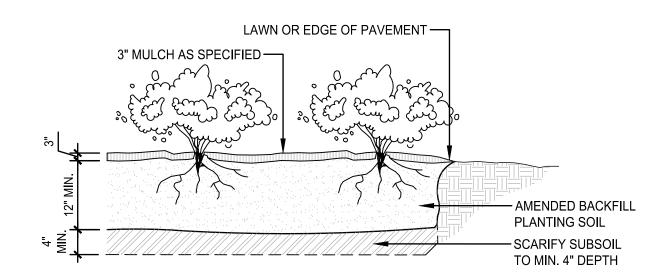


PERENNIAL PLANTING

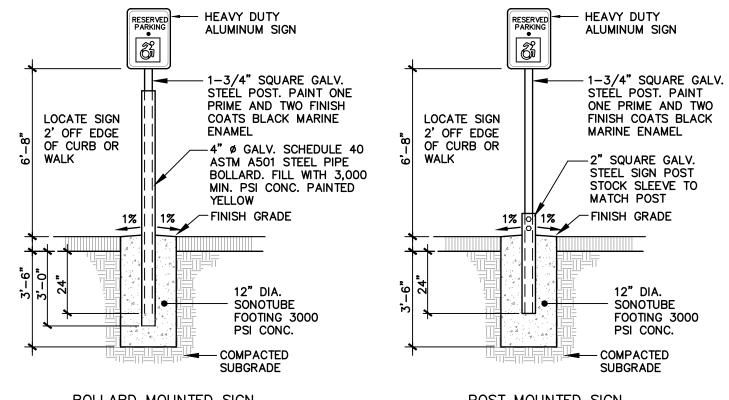


BOLLARD MOUNTED SIGN

POST MOUNTED SIGN

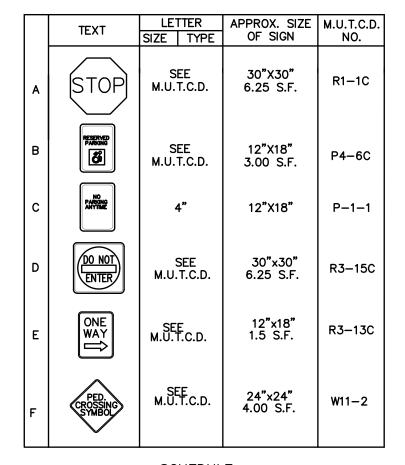


OWNER TO APPROVE LOCATIONS PRIOR TO INSTALLATION.

SCHEDULE

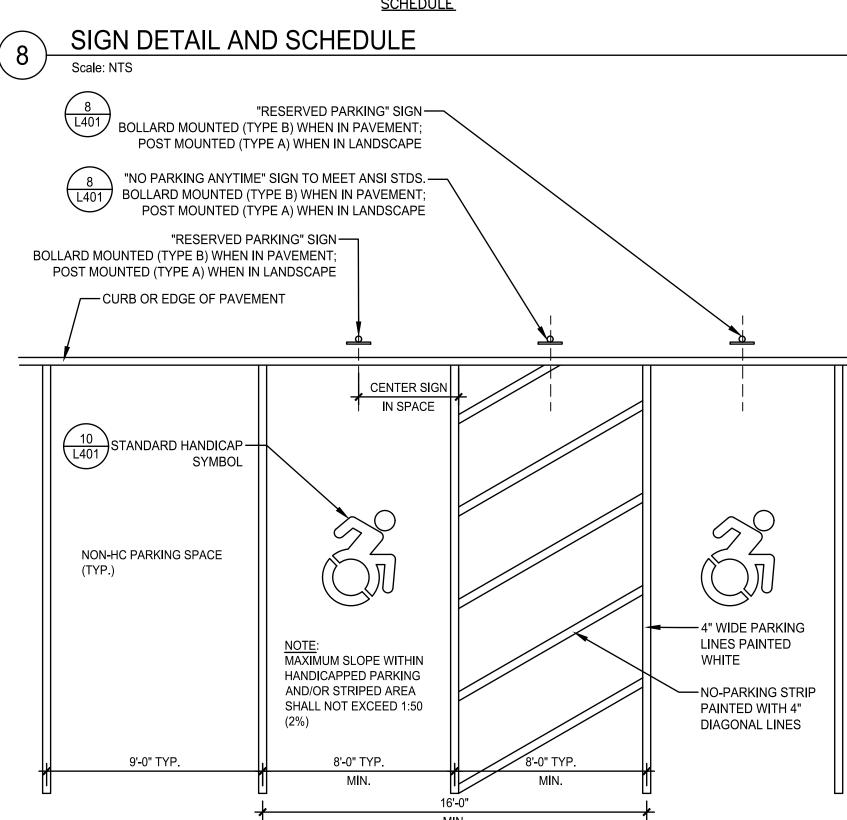

HANDICAP PARKING LAYOUT

HANDICAP SYMBOL

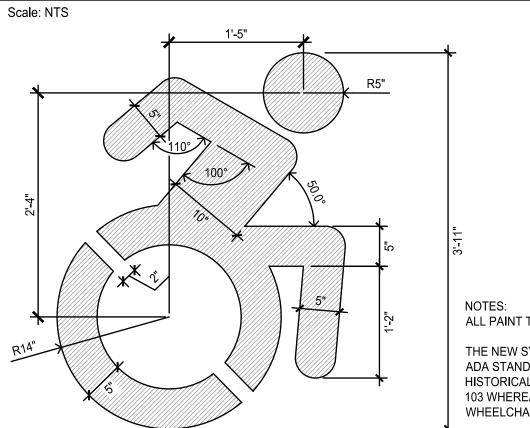

ALL PAINT TO BE COLOR BLUE AND AS SPECIFIED

THE NEW SYMBOL DOES NOT MATCH THE HISTORICAL ADA STANDARDS, BUT SLIGHT VARIATIONS ON THE HISTORICAL SYMBOL ARE PERMISSIBLE UNDER SECTION 103 WHEREAS THE SYMBOL CLEARLY DISPLAYS A WHEELCHAIR AND SIGNIFIES ACCESSIBILITY.

L401

Maria College Campus Development Plan

Project Title:

People. Purpose. Place.

p: 518-587-8100

Unauthorized alteration or addition to this

New York State Education Law.

Maria College

700 New Scotland Ave. Albany, NY 12208

document is a violation of Section 7209 of the

architecture •

40 Long Alley

© the LA Group 2017

Prepared for:

ARCHITECT:

M.E.P. ENGINEER:

NY 12866


700 New Scotland Ave. Albany, NY 12208

MJM/KAC Ch'k'd: LTM 4/26/19 Scale:

Drawing Title


SITE DETAILS

Drawing No.

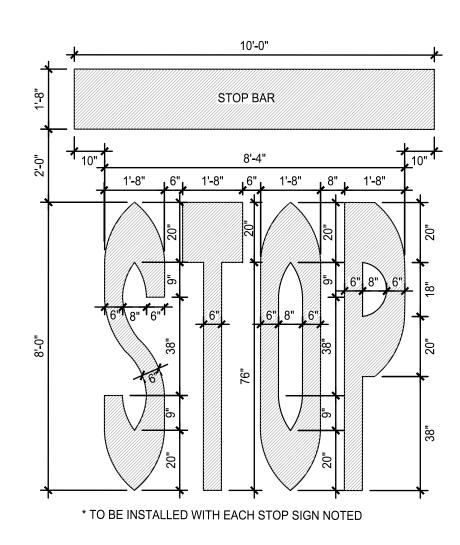


STOP BAR MARKING

Scale: NTS

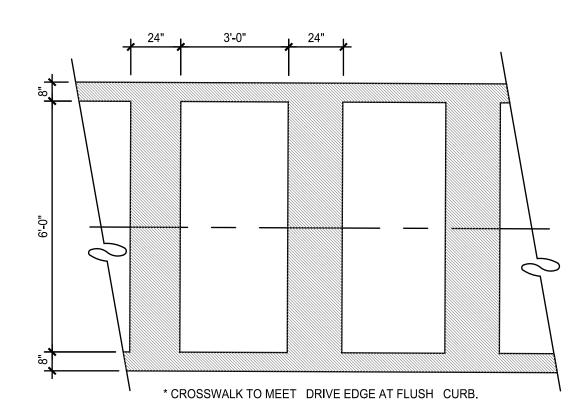


CROSSWALK MARKING

Scale: NTS

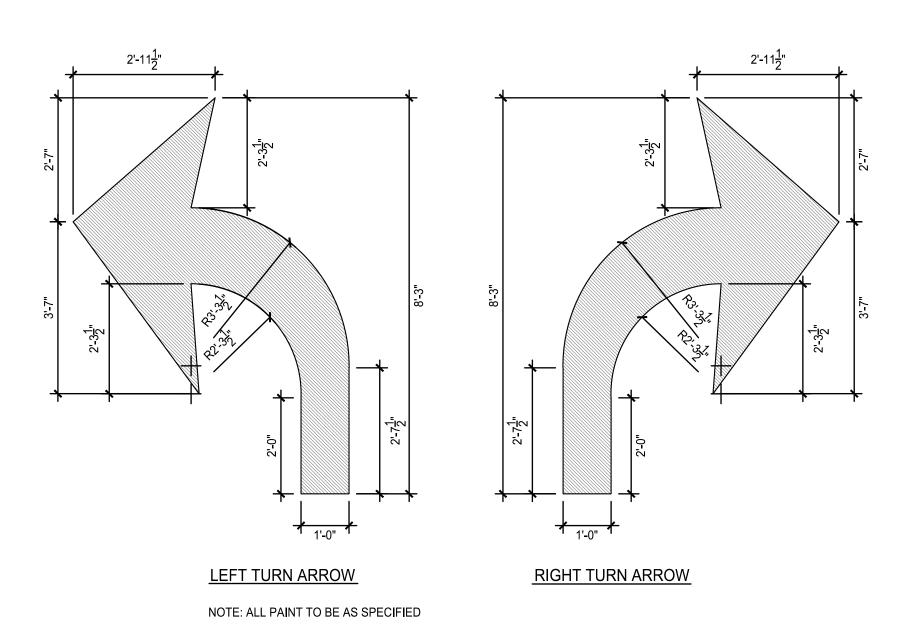

TURN ARROW MARKING

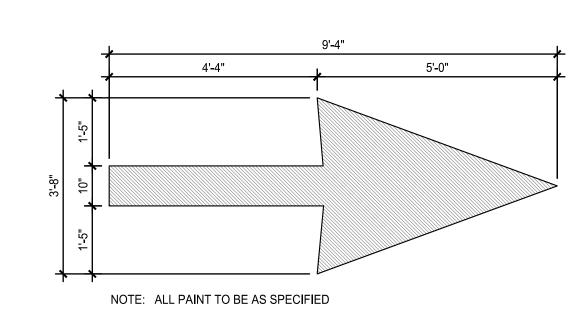

DIRECTIONAL ARROW MARKING

FINISHED GRADE — CLEAR OP'NING PRECAST CONCRETE GRADE ADJUSTMENTS 6" MIN. TO 20" MAX. NO CONCRETE BRICK SHIM COURSES CONE EXTENSIONS AS REQ'D TO ADJUST TO FINISHED GRADE. \ USE PRECAST UNITS ECCENTRIC CONE SECTION -PRECAST CONCRETE SECTIONS - 4000 PSI AT 28 DAYS, AIR - ENTRAINED REINFORCED PLASTIC -– JOINTS BUTYL SEALED - INDUSTRY STD. OR NON-SLIP STEPS PER A.O.B.E NYSDOT 725-02.01 RISER SECTION - SIZE AND LOCATION OF PIPES AS SPECIFIED BOTTOM SECTION —12" CRUSHED STONE -UNDISTURBED SUBGRADE OR ADDITIONAL FOUNDATION STONE A.O.B.E. PRECAST CONCRETE MANHOLE FOR STORM


— CAST IRON MANHOLE FRAME AND COVER

LABELED "STORM"


ALLOW 2" FOR FINAL — ADJUSTMENT OF FRAME — STORM SEWER PIPE FRAME TO BE MORTARED-TO BE MORTARED IN TO TOP OF CATCH BASIN PLACE WITH NON-SHRINK HEAVY DUTY FRAME GROUT ALLOW 2" FOR AND GRATE -FINAL ADJUSTMENT OF CAMPBELL NO. 2816B MIN. I.D.** WITH GRATE OPTION OR APPROVED MIN. I.D.* EQUAL KNOCKOUT-PANEL EACH SIDE -12" TYPE 2 CRUSHED STONE ON UNDISTURBED SUBGRADE SECTIONS N.T.S. CONCRETE - 4000 PSI @ 28 DAYS MIN. REINFORCMENT - 6x6 - 10/10 WWM ALL FOUR SIDES AND BOTTOM (CONFORM TO ASTM STD. A-615)

1. ALL CATCH BASINS TO BE PLACED IN ANY TRAFFIC AREAS SHALL MEET N.Y.S.D.O.T. HIGHWAY LOADING H-20.


CATCH BASIN

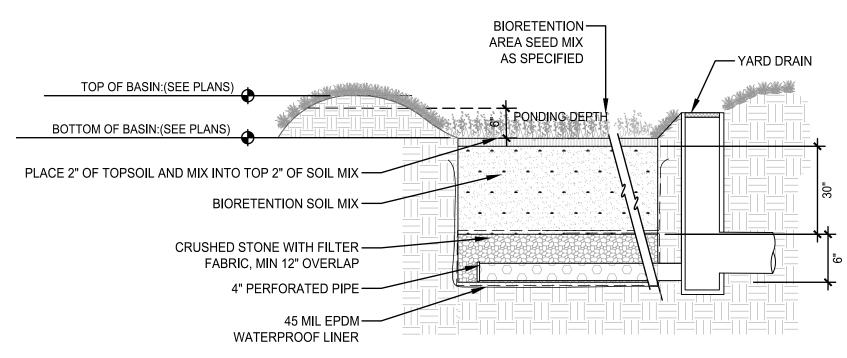

BIORETENTION BASIN

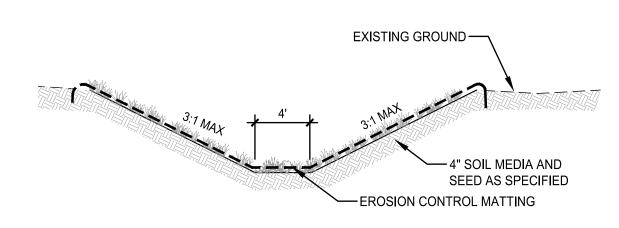

VEGETATED SWALE

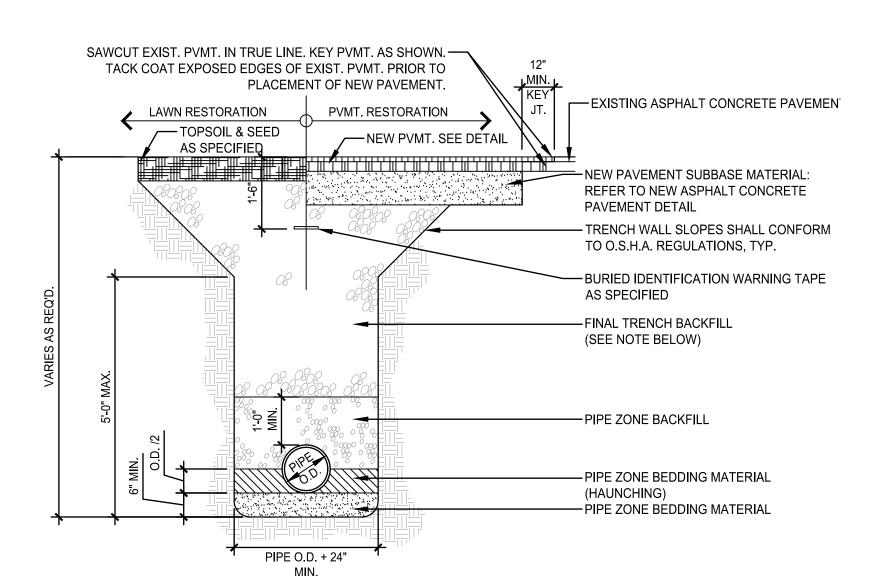

IVIIIN.			
ITEM	DEPTH	MATERIAL	METHOD OF PLACEMENT
PIPE ZONE BEDDING	6" MIN.	CRUSHED STONE	MECHANICAL COMPACTION
PIPE ZONE BEDDING (HAUNCHING)	PIPE O.D./2	CRUSHED STONE	MECHANICAL COMPACTION
PIPE ZONE BACKFILL	12" MIN. COVER	CRUSHED STONE	MECHANICAL COMPACTION
FINAL TRENCH BACKFILL	VARIES	SEE NOTE	MECHANICAL COMPACTION


NOTES:

1) FINAL TRENCH BACKFILL

- a) IN NON-PAVED AREAS, FINAL TRENCH BACKFILL SHALL BE EXCAVATED MATERIAL WHEN DETERMINED SUITABLE BY THE ENGINEER OF RECORD; OTHERWISE IT SHALL BE STRUCTURAL FILL, MIN. MOD. PROCTOR DENSITY SHALL BE 90 PERCENT.
- b) IN PAVED AREAS, FINAL TRENCH BACKFILL SHALL BE STRUCTURAL FILL, MIN. MODIFIED PROCTOR DENSITY SHALL BE 95 PERCENT.
- 2) ALL PIPE ZONE BEDDING, PIPE ZONE BACKFILL, AND FINAL TRENCH BACKFILL SHALL BE PLACED IN 6 INCH MAXIMUM. COMPACTED LIFTS. ALL BEDDING AND BACKFILL MATERIALS SHALL BE MECHANICALLY COMPACTED TO THE SATISFACTION OF THE ENGINEER.

3) EXCAVATION SHALL BE KEPT DRY AND DEWATERED AT ALL TIMES DURING TRENCHING OPERATIONS.

TYPICAL STORM TRENCH

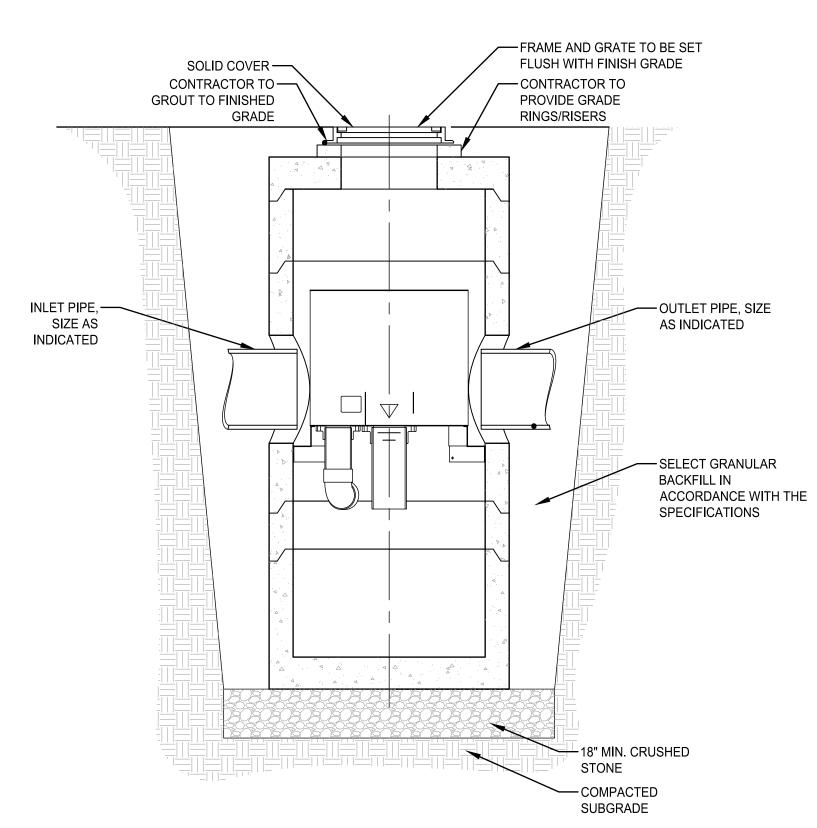

HYDRODYNAMIC SEPARATOR

People. Purpose. Place.

40 Long Alley p. 518-587-8100 Saratoga Springs f. 518-587-0180 NY 12866

Unauthorized alteration or addition to this document is a violation of Section 7209 of the New York State Education Law.

© the LA Group 2017

Prepared for: Maria College

700 New Scotland Ave. Albany, NY 12208

ARCHITECT:

architecture •

M.E.P. ENGINEER:



Project Title:

Maria College Campus Development Plan


700 New Scotland Ave. Albany, NY 12208


Project No.:			2017131
Design:			MJM
Drawn:	MJM/KAC	Ch'k'd:	LTM
Date:	4/26/19	Scale:	NTS
Rev:	ev: Description:		Date:

Drawing Title

SITE DETAILS

Drawing No.

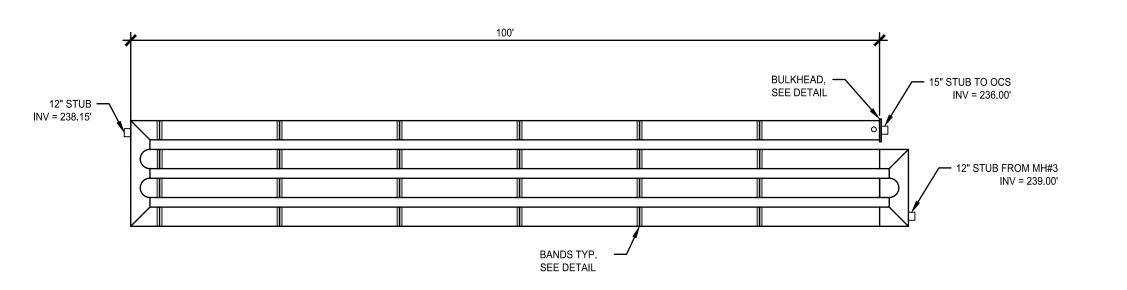

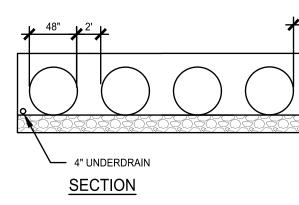

LOADING: H20/H25 SYSTEM INV = 236.00 MAINLINE PIPE GAUGE = 16

ALT2 FINISH = PIPE DIAMETER = 48"

WALL TYPE = SOLID


- NOTES:

 1. ALL RISER AND STUB DIMENSIONS ARE TO CENTERLINE.
- 2. ALL FITTINGS AND REINFORCEMENT COMPLY WITH ASTM A998.
- 3. ALL RISERS AND STUBS ARE 2-2/3" X 1/2" CORRUGATION AND 16 GAGE UNLESS OTHERWISE NOTED.


RISERS TO BE FIELD TRIMMED TO GRADE.


QUANTITY OF PIPE SHOWN DOES NOT PROVIDE EXTRA PIPE FOR CONNECTING THE SYSTEM TO EXISTING PIPE OR DRAINAGE STRUCTURES. OUR SYSTEM AS DETAILED PROVIDES NOMINAL INLET AND/OR OUTLET PIPE STUB FOR CONNECTION TO EXISTING DRAINAGE FACILITIES.

UNDERGROUND DETENTION PIPING

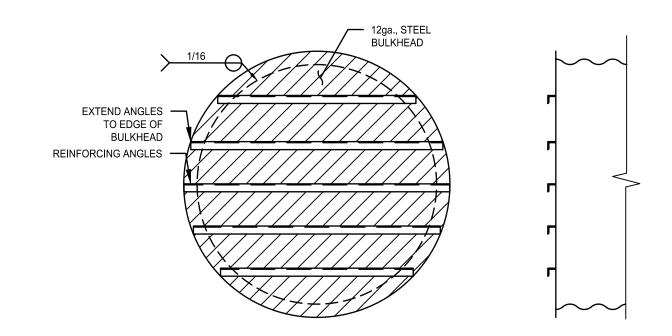



DETENTION PIPE BULKHEAD

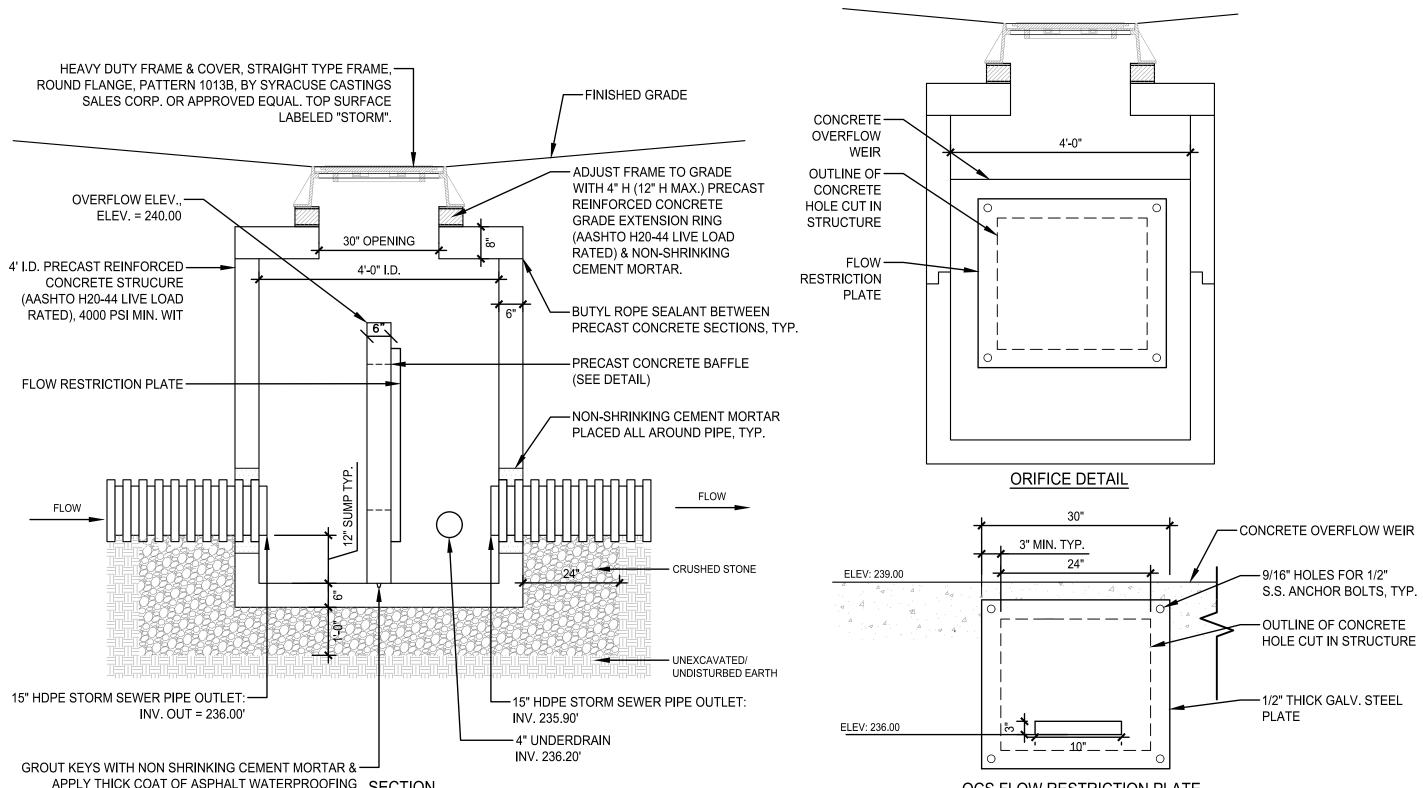

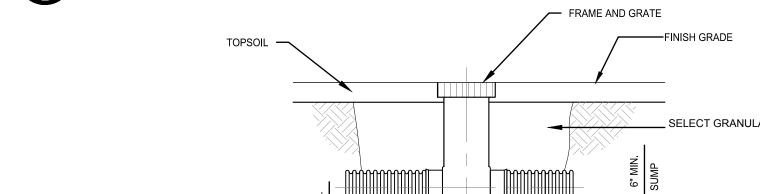

—— COMPACTED SUBGRADE YARD DRAIN SCALE: N.T.S

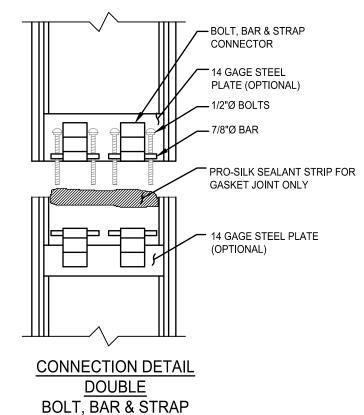

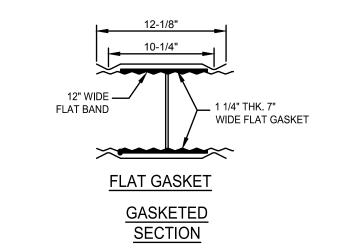

CORRUGATIONS	PIPE PRODUCTS
2-2/3"X1/2"	GALVANIZED
3" X 1"	ALUMINIZED BITUMINOUS COATED
5" X 1" 3/4"X3/4"X7-1/2"	SMOOTH-FLO ALUMINUM CONCRETE-LINER STEEL ULTRA-FLO

- GENERAL NOTES:

 1. REFER TO CONTECH BAND SELECTION GUIDE FOR BAND WIDTH, GAGE, AND FASTENER TYPES.
- BAND FASTENERS ARE ATTACHED WITH SPOT WELDS, RIVETS OR HAND WELDS. ALL ALUMINUM BANDS, BOTH SINGLE AND DOUBLE BB&S, ARE FURNISHED WITH A 14 GAGE ALUMINUM
- BACK-UP PLATE WELDED TO THE BAND AND THE STRAP. 3. REROLLED ANNULAR END CORRUGATIONS ARE NORMALLY 2-2/3"
- 4. DIMENSIONS ARE SUBJECT TO MANUFACTURING TOLERANCES.
- 5. ORDER SHALL DESIGNATE GASKET OPTION.

H-12 HUGGER BAND DETAIL

p: 518-587-8100 NY 12866

Unauthorized alteration or addition to this document is a violation of Section 7209 of the New York State Education Law.

© the LA Group 2017

Prepared for:

Maria College 700 New Scotland Ave. Albany, NY 12208

ARCHITECT:



M.E.P. ENGINEER:




Project Title:

Maria College Campus Development Plan

700 New Scotland Ave. Albany, NY 12208

Project No.:			2017131
Design:			MJM
Drawn:	MJM/KAC	Ch'k'd:	LTM
Date:	4/26/19	Scale:	NTS
Rev:	Description:		Date:

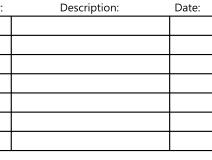

Drawing Title

SITE DETAILS

Drawing No.

